SEQUENCE OF ACTIVITY - HOUSE LOT DEVELOPMENT SEDIMENT AND EROSION CONTROL NARRATIVE

- I. DESIGN CRITERIA/CONSTRUCTION METHODS AND DETAILS: State of Connecticut DOT form 8 1 4 guidelines for soil erosion and sediment control. 2. LIMITS OF DISTURBANCE: Upon approval of individual site plan development, the limit of development shall be established in the field for each proposed structure. Disturbance limits as shown shall be bounded by staked hay bales or silt fence.
- 3. EROSION CONTROLS: Area to be disturbed shall be bounded by staked hay bales or silt fence. All erosion controls, including silt fence and anti-tracking pad shall be installed and inspected by the Land use ZEO and/or Wetland Agent prior to stumps being pulled, grubbing, or excavation. The ZEO and Wetland Agent may modify the erosion control requirement based on field conditions so as to adequately control erosion and siltation from the site.
- 4. TREES CLEARED: Trees shall be cleared and cut to length and stacked or removed from the site. Then the pulling of stumps, grubbing and/or excavation shall begin.
- 5. DEMOLITION OF EXISTING STRUCTURES: All demolition materials to be placed in containers, removed off site and properly disposed of. Any resulting holes will be filled with clean fill and re-graded to match existing
- 6. DRIVEWAYS: All driveway and driveway shoulders shall be stripped, graded as shown on plan, and graveled. All driveway shoulders shall be stabilized immediately upon grading, either by diverting runoff, mulching, or seeding and hay bales, silt fence or other approved measures the same day that cuts are made.
- 7. TOPSOIL: All topsoil shall be stripped and saved in an area as shown on the plan or as approved by the Planner and Wetland Agent. Topsoil shall not be removed from the site except as in compliance with the Zoning
- 8. CONSTRUCTION & DISTURBED AREA: Excavation and construction shall commence following inspection and approval of erosion control and construction of the driveway. The disturbed area shall be so as to contain runoff within the lot to the greatest extent possible.
- 9. SITES IN WINTER: When a site will be open during the winter months, rough grading and 4-6 inch mulching must occur prior to construction in order to minimize erosion and uncontrolled runoff.
- 10. DRAINS: Foundation and curtain drains shall be installed as shown on the approved plan. Any changes to the location of the drains or the additions of any drains shall be approved by the Wetlands Agenda prior to
- II. COMPLETE SITE WORK: Finish grading shall occur as soon as possible on all lots where there is potential for erosion and for degradation of wetlands and watercourses. Lots shall be finish graded, seeded with perennial grasses suitable for the respective amount of sun or shade and mulched prior to Certificate of Zoning Compliance.
- 12. FINAL STABILIZATION: Erosion controls shall be maintained on the lot as long as they are needed to control erosion and sedimentation.
- 13. E&S CONTROLS: All E&S controls shall be inspected on a daily basis and maintained as necessary until all disturbed areas are permanently re-vegetegated or otherwise stabilized. Remove silt at hay bales or silt fence outlets after all rainfalls. The responsibility of such inspection shall be that of the contractor.
- 14. SCHEDULE: Construction to commence August 1, 2022 and completion by August 1, 2024.

NOTE: BUILDER RESPONSIBLE FOR CONSTRUCTION OF BLDG. AND OTHER IMPROVEMENTS AND IS RESPONSIBLE FOR ALL EROSION CONTROL MEASURES SHOWN HEREON AND AS OTHERWISE REQUIRED BY CONSTRUCTION TECHNIQUES UTILIZED.

MAP STANDARD NOTES:

1. THIS SURVEY (OR MAP) HAS BEEN PREPARED PURSUANT TO THE REGULATIONS OF CONNECTICUT STATE AGENCIES SECTIONS 20-300b-1 THRU 20-300b-20 AND THE "STANDARDS AND SUGGESTED METHODS AND PROCEDURES FOR SURVEYS AND MAPS IN THE STATE OF CONNECTICUT" AS ADOPTED BY THE CONNECTICUT ASSOCIATION OF LAND SURVEYORS, INC. ON AUGUST 29, 2019.

TYPE OF SURVEY: IMPROVEMENT LOCATION SURVEY **BOUNDARY DETERMINATION: RESURVEY** HORIZONTAL ACCURACY CLASS: A-2 TOPOGRAPHIC ACCURACY CLASS: T-2 VERTICAL DATUM: NAVD 88 (CTGS MON. 505 ELEV: 71.125)

THE INTENDED PURPOSE OF THIS MAP/SURVYE IS TO DEPICT A **CURRENT WETLANDS DELINEATION AND EXISTING CONDITIONS** OF THE SITE.


MAP REFERENCES:

1. "IMPROVEMENT LOCATION PLAN PREPARED FOR BRENT ALI, SHOWING PROPOSED HOUSE, 67 KITEMAUG ROAD, MONTVILLE, CONNECTICUT" DATED 11/26/2012 REVISED THROUGH 2/13/13, SCALE: 1"=20' SHEET 1 OF 1, BY ROB HELLSTROM LAND SURVEYING, LLC.

2."PLAN OF BUILDING LOTS ON MASSAPEAG FARM OWNED BY F.W. BROWNING

3."PLAN OF SHORE LOTS HAUGHTON COVE TERRACE MONTVILLE, CT. FOR BY

F.W.WILBER REALTY CO.AUGUST 1911" 4."FLOOD INSURANCE RATE MAP NEW LONDON COUNTY CONNECTICUT PANEL 353 OF 554 MAP# 09011C0353G JULY 18, 2011"

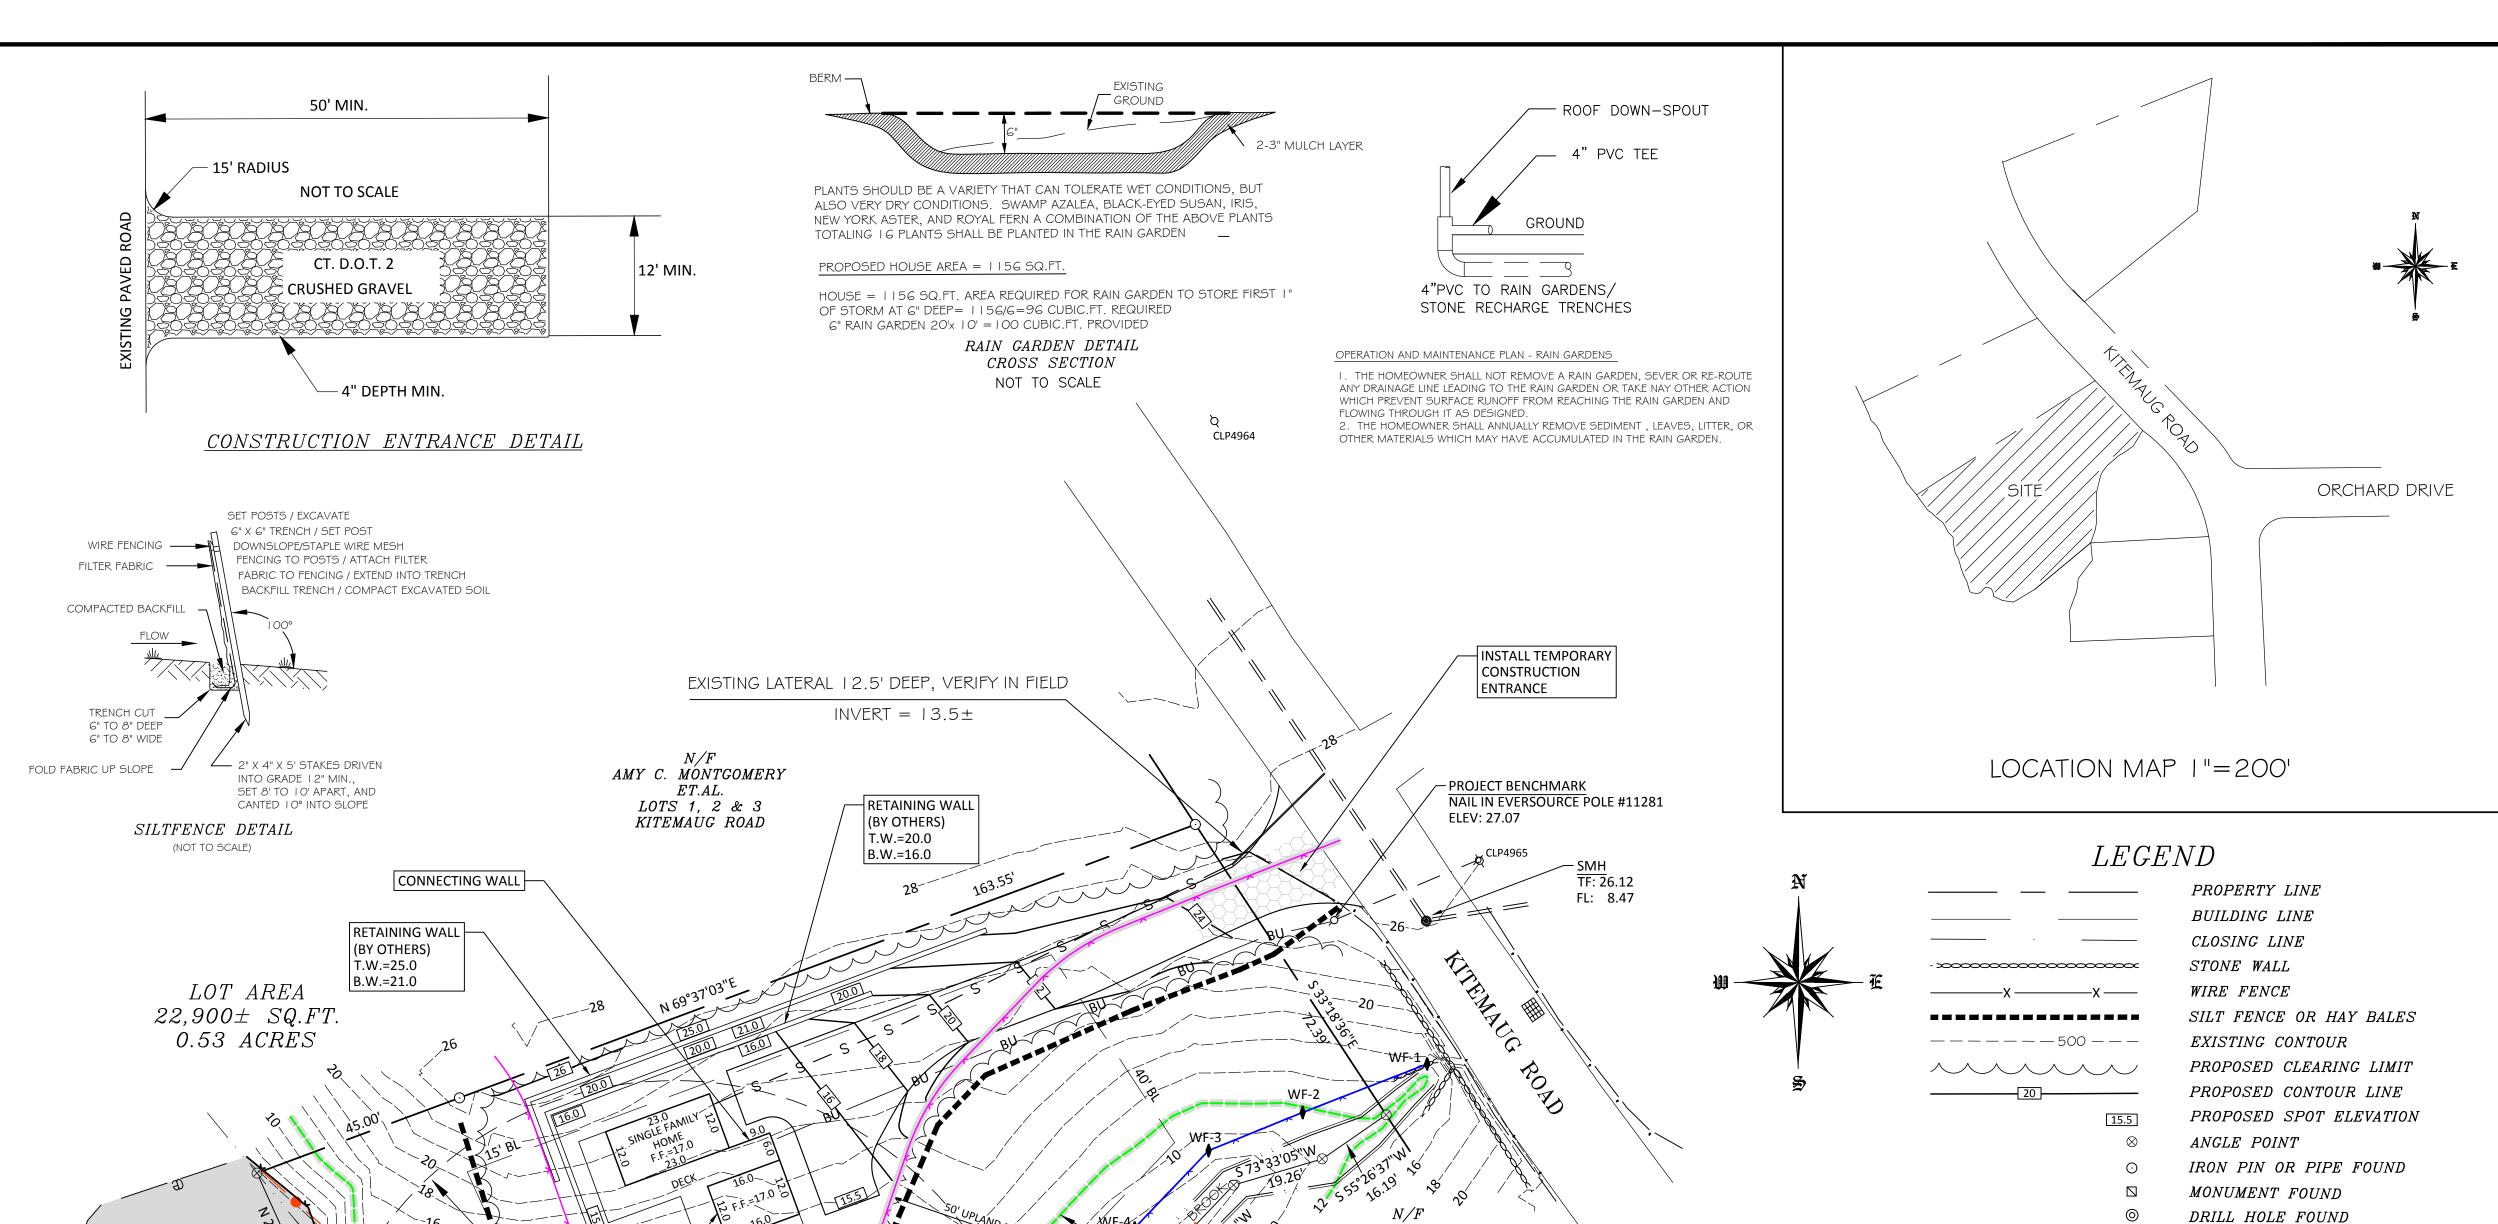

S 81°39'20"W 40.26'/ CLOSING LINE BOUNDARY IS CENTER LINE OF STREAM CLQŚING LINE, BOUNDARY LINE IS MEAN HIGH WATER ELEVATION 1.2 HORTON COVE

ANY REPRODUCTION, POSSESSION OR USE OF THIS DRAWING OR ANY PART THEREOF

WITHOUT THE WRITTEN PERMISSION OF THE SURVEYOR INDICATED BELOW IS PROHIBITIED.
VIOLATORS WILL BE PROSECUTED TO THE FULL EXTENT OF THE LAW.

`**&** WF**-**5♦

√ **W**F-6

ACCESSORY -

DWELLING

HORTON COVE

COVERAGE TABLE

814± S.F.

 $0.02\pm AC$.

NONE

 $1,211 \pm S.F.$

 $0.03\pm AC$.

INLAND WETLANDS

(ON PROPERTY)

INLAND WETLANDS

DISTURBED

URA DISTURBED

(ON PROPERTY)

FOR PERMITTING ONLY

-s-s-s-s-s-

ARE SUBSTANTIALLY CORRECT. ROB HELLSTROM LAND SURVEYING LLC DATE IAN COLE REGISTERED SOIL SCIENTIST #2006 32 MAIN STREET HEBRON, CONNECTICUT (860)-228-9853

IMPROVEMENT LOCATION SURVEY - PREPARED FOR -

IRON PIN TO BE SET 5/8" REBAR

PROPOSED SANITARY SEWER LINE

100 YEAR FLOOD ZONE AE ELEVATION 12

MONUMENT TO BE SET

OVERHEAD UTILITIES

EDGE OF WATER

INLAND WETLAND LINE

TIDAL WETLAND AREA

RAIN GARDEN 10'x 20'

COASTAL JURISDICTION LINE

ELEVATION = 2.3 NAVD 88

DRILL HOLE TO BE SET

SURVEYOR CONTROL POINT 50' UPLAND REVIEW AREA

HARLON DALTON DEDICTING WETLANDS & FVISTING CONDITIONS

DELICITING WEILANDS & EXISTING CONDITIONS
67 KITEMAUG ROAD
MONTVILLE CONNECTICUT

TO MY KNOWLEDGE AND BELIEF. THIS MAP IS GRAPHIC SCALE SUBSTANTIALLY CORRECT AS NOTED HEREON. Mailing Address: P.O. BOX 378 HEBRON, CT 06248 THIS DRAWING IS NOT VALID UNLESS IT BEARS AN ORIGINAL INK SIGNATURE AND EMBOSSED SEAL REVIEW COMMENTS 2 | 8/4/22 www.rhlsct.com SHEET NO.: 1 OF 1 JOB NO.: REVIEW COMMENTS 22-118 Email: hellstromsurveying@yahoo.com (IN FEET) NO. DATE DESCRIPTION I inch = 20 ft.JULY 7th, 2022 BY: JRR FILE NO.: 22-118_67_KITEMAUG_RD SCALE: 1" = 20' ROBERT W. HELLSTROM, L.S. #13626 R E V I S I O N S

DOMINICK M. CRISTELLO

LOT 5

KITEMAUG ROAD

COASTAL JURISDICTION LINE ELEV. 2.3

100 YEAR FLOOD ZONE AE ELEV. 12

INLAND WETLAND LINE

I HEREBY DECLARE THAT THE

WETLANDS DEPICTED ON THIS MAP