BREZELINE UNCASVILLE CT



689 Old Colchester Rd. Uncasville, CT

30% PROGRESS SET 12/13/22 (N.F.C.)


MASTER ARREVIATION KEY.


4.5	AUCHOR ROLT			1.454	1 AN AINTATE		COLITI
AB	ANCHOR BOLT	-	FACT	LAM	LAMINATE	5 6 TD4D	SOUTH
AC	AIR CONDITIONER	E	EAST EVEN I CONT	LAV	LAVATORY	S-TRAP	SEDIMENT TRAP
ACI	AMERICAN CONCRETE INSTITUTE	EJ EJC	EXPANSION JOINT	MAG	MAGONEV	SC SCED	SOLID CORE
ACOUST		EL	EXPANSION JOINT COVER ELEVATION	MAS MAT	MASONRY MATERIAL	SD SD	SCHEDULE STORM DRAIN
AFF	ABOVE FINISH FLOOR	ELEC	ELECTRICAL	MAX	MAXIMUM	SF	SQUARE FOOT
ALT	ALTERNATE	ELEV	ELEVATOR	MECH	MECHANICAL	SH	SHOWER
ALUM	ALUMINUM	EQ	EQUAL	MEM	MEMBRANE	SHT	SHEET
ANCH	ANCHOR	EQUIP	EQUIPMENT	MEP	MECHANICAL,	SIM	SIMILAR
ANOD	ANODIZED	ER	EMERGENCY ROOM	17121	ELECTRICAL, PLUMBING	SL	SLIDING
ASTM	AMERICAN SOCIETY FOR	EST	ESTIMATE	METTP	METAL TOILET PARTITION	SMR	SINGLE PLY MEMBRANE
	TESTING MATERIALS	EWC	ELECTRICAL WATER	MFR	MANUFACTURER		ROOF
			COOLER	MH	MANHOLE	SP/PT/FIN	SPECIAL PAINT FINISH
BD	BOARD	EXH	EXHAUST	MIN	MINIMUM	SPEC	SPECIFICATION
BIT	BITUMINOUS	EXIST	EXISTING	MISC	MISCELLANEOUS	SPKR	SPEAKER
BL	BUILDING LINE	EXP	EXPANSION	MO	MASONRY OPENING	SQ	SQUARE
BLDG	BUILDING	EXPD	EXPANDED	MTL	METAL	55	STAINLESS STEEL
BLK	BLOCK	EXT	EXTERIOR	MULL	MULLION	STA	STATION
BLKG	BLOCKING					STD	STANDARD
BM	BEAM	F/F	FACE OF FOUNDATION	N	NORTH	STL	STEEL
BOC	BOTTOM OF CURB	E4	WALL	NAT	NATURAL	STOR	STORAGE
BOF	BOTTOM OF FOOTING ELEVATION	FA	FRESH AIR	NEC	NECESSARY	STRG	STRINGER
ВОТ	BOTTOM	FAP	FIRE ALARM PANEL	NIC	NOT IN CONTRACT	STRUCT	STRUCTURAL
BRG	BEARING	FD	FLOOR DRAIN	NOM	NOMINAL	SU	SITE UTILITY
BRK	BRICK	FE FEC	FIRE EXTINGUISHER	NRC	NOISE REDUCTION	SUSP	SUSPEND (SUSPENDED)
BSMT	BASEMENT	FEC	FIRE EXTINGUISHER CABINET	NTG	COEFFICIENT	SYMM	SYMMETRICAL
BTW	BETWEEN	FIN	FINISH	NTS	NOT TO SCALE	5Y5	SYSTEM
BUR	BUILT-UP ROOF	FL	FLOW LINE	OC	ON CENTER	_	TD5.4.D
DOIL	BOILT OF NOOT	FLR	FLOOR	OD	ON CLIVILK OUTSIDE DIAMETER	T	TREAD
CAB	CABINET	FND	FOUNDATION	OF/C	OUTSIDE FACE OF	T#G	TONGUE & GROOVED
СВ	CATCH BASIN	FOF	FACE OF FINISH	01/0	CONCRETE	T/FRM	TOP OF FRAME
CER	CERAMIC	FOM	FACE OF MASONRY	ОН	OVERHEAD	T/SLB	TOP OF SLAB
CF	CUBIC FOOT	FOS	FACE OF STUD	OPG	OPENING	TB TEL	TACKBOARD TELEPHONE
Cl	CAST IRON	FR	FIRE RATED	OPP	OPPOSITE	TEMP	TEMPORARY
CJ	CONTROL JOINT	FS	FULL SIZE	OR	OPERATING ROOM	TERR	TERRAZZO
CL	CLOSET	FT	FOOT			THK	THICK
CLCB	CURBLESS CATCH BASIN	FTG	FOOTING	PBD	PARTICLE BOARD	THLD	THRESHOLD
CLG	CEILING	FUR	FURRED (FURRING)	PCF	POUNDS PER CUBIC	TOC	TOP OF CURB
CM	CONTRACT MANAGER	FVC	FIRE VALVE CABINET		FOOT	TOF	TOP OF FOUNDATION
CMU	CONCRETE MASONRY			PL	PROPERTY LINE	TOS	TOP OF SLAB
	UNIT	GA	GAUGE	PLAM	PLASTIC LAMINATE	TOW	TOP OF WALL ELEVATION
CO	CLEAN OUT	GALV	GALVANIZED	PLAS	PLASTER	TR	TO REMAIN
COL	COLUMN	GC	GENERAL CONTRACTOR	PLYWD	PLYWOOD	TYP	TYPICAL
COMP	COMPACTED	GEN	GENERAL	PNL	PANEL		
	(COMPOSITION)	GL	GLASS	PSF	POUNDS PER SQUARE	UH	UNIT HEATER
CONC	CONCRETE	GLZ	GLAZING	DCI	FOOT	UL	UNDERWRITERS
CONST	CONSTRUCTION	GRD	GRADE	PSI	POUNDS PER SQUARE INCH		LABORATORIES, INC.
CONTR	CONTINUOUS	GYP	GYPSUM	PT	PAINT	UOD	UNDERSIDE OF DECK
CORR	CONTRACTOR			PTD	PAINTED	UON	UNLESS OTHERWISE
CORR CP	CORRUGATED CONTROL PANEL	HŧV	HEATING & VENTILATING	PTN	PARTITION		NOTED
C5G	CASING	HC	HANDICAP	PVC	POLYVINYL CHLORIDE	UR	URINAL
CSMT	CASEMENT	HDWD	HARDWOOD	1 10	TOLIVINIE OFFICIAL	UV	UNIT VENTILATOR
CT	CERAMIC TILE	HGT	HEIGHT	QT	QUARRY TILE		
CTR	CENTER	НМ	HOLLOW METAL	σ,	5,57,1,00	VAR	VARIES OR VARIABLE
CY	CUBIC YARD	HP	HIGH POINT	R	RADIUS	VB	VINYL BASE
01	ODIO TARD	HVAC	HEATING, VENTILATION, AIR CONDITIONING	R/A	RETURN AIR	VCT	VINYL COMPOSITION TIL
DF	DRINKING FOUNTAIN	HWH	HOT WATER HEATER	RC	REINFORCED CONCRETE	VERT	VERTICAL
DIA	DIAMETER	TIVVII	HOT WATER HEATER	RD	ROOF DRAIN	VEST	VESTIBULE
DIAG	DIAGONAL	ID	INSIDE DIAMETER	REF	REFERENCE	VIF	VERIFY IN FIELD
DIM	DIMENSION	IN	INCH	REFR	REFRIGERATOR	VNR VOL	VENEER VOLUME
DL	DEAD LOAD	INSUL	INSULATION	REINF	REINFORCE	V UL	V OLUIVIL
DN	DOWN	INT	INTERIOR	REQD	REQUIRED	W	WEST
DR	DOOR	INV	INVERT	RGH	ROUGH	W/	WITH
DS	DOWNSPOUT	41 T V		RL	RAIN LEADER	w/ WC	WATER CLOSET
DS/C	DRIVE SIDE OF CURB	JC	JANITOR'S CLOSET	RM	ROOM	WD	WOOD
DTL	DETAIL	JST	JOIST	RO	ROUGH OPENING	WDW	WINDOW
DWG	DRAWING	JT	JOINT	ROW	RIGHT OF WAY	WGL	WIRE GLASS
				RQMT	REQUIREMENT	WP	WEATHERPROOF (WATERPROOFING)


(WATERPROOFING)

WWF WELDED WIRE FABRIC

LOCUS MAP: (N.T.S.)

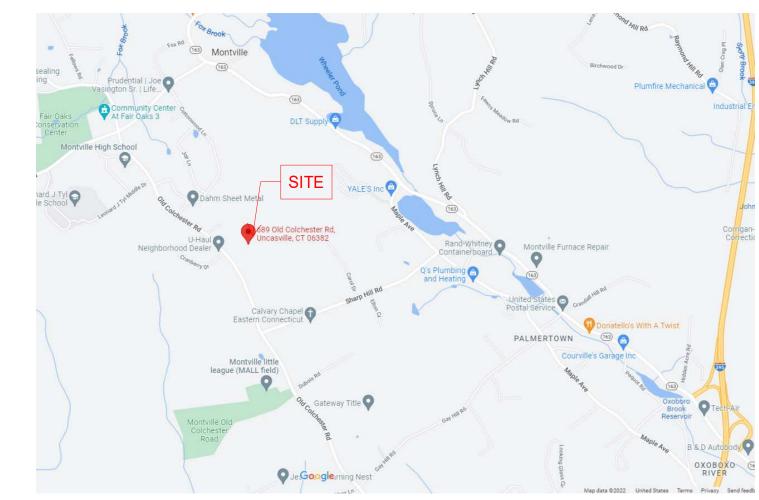

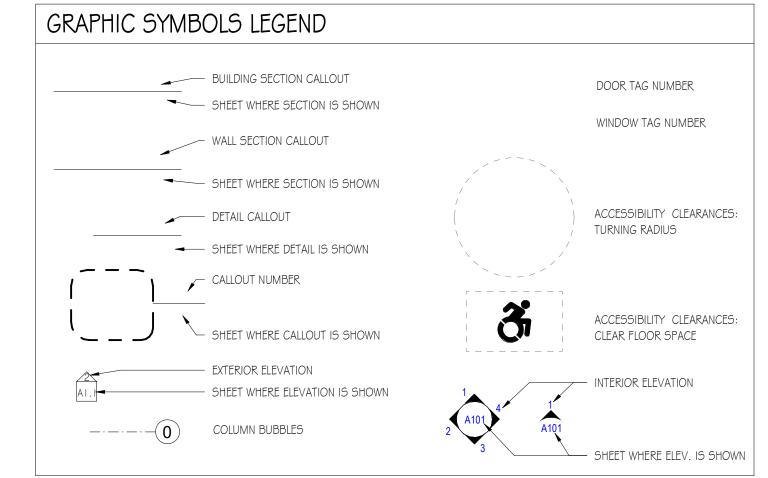

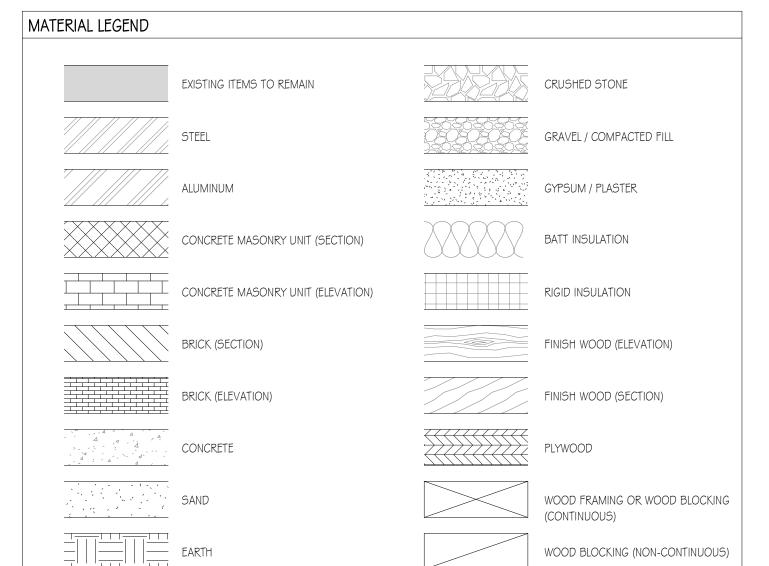

DRAWING SHEET INDEX:

Sheet	Sheet Name	Issued	Revision	Revision Date
PCS	PROJECT COVER SHEET	N.F.C.		
A1.1	PLAN & REFLECTED CLG PLAN	N.F.C.		
A3.1	EXTERIOR ELEVATIONS	N.F.C.		
A4.1	BUILDING SECTIONS	N.F.C.		
A7.1	ENLARGED RESTROOM AND INT ELEVATIONS	N.F.C.		

Revision Schedule

T | W Designs, LLC 254 Drake Hill Rd.

Civil Engineer:

Structural Engineer:

Electrical Engineer

Mechanical Engineer:

Fire Protection Eng.:

General Contractor:

22044

Project Info:

Breezeline Uncasville, CT

689 Old Colchester Rd.


Uncasville, CT 06353.


GENERAL NOTES:

- DO NOT SCALE DRAWING OR DIMENSIONS. FOR MISSING DIMENSIONS OR DIMENSIONS IN CONFLICT, CONTACT THE CONTRACTOR IMMEDIATELY BEFORE CONTINUING WITH WORK.
- ANY DISCREPANCIES IN THESE PLANS WILL BE BROUGHT TO THE CONTRACTOR'S ATTENTION IN WRITING IMMEDIATELY REFER TO MECHANICAL, ELECTRICAL, PLUMBING, AND FIRE PROTECTION DESIGN-BUILD PLANS AND SPECIFICATION FOR LOCATIONS OF ALL BLOCK OUTS, INSERTS, OPENINGS, CURBS, BASES, & PADS THAT ARE NOT
- DIMENSIONED OR SHOWN ON CONTRACTOR'S DWG'S. OR STRUCTURAL DWG'S. STRUCTURAL STEEL, MECHANICAL, ELECTRICAL, PLUMBING, AND FIRE PROTECTION PLANS AND SPECIFICATION SHALL BE PROVIDED AND ARE THE RESPONSIBILITY OF THERE RESPECTIVE SUBCONTRACTORS IF NOT
- CARRIED IN ARCHITECTURAL SERVICES
- ALL CONSTRUCTION SHALL CONFORM TO AND BE IN ACCORDANCE WITH THE REGULATOR REQUIREMENTS MANDATED BY ALL FEDERAL, STATE AND LOCAL AUTHORITIES HAVING JURISDICTION IN ACCORDANCE TO THE STATE IN WHICH THE WORK IS PERFORMED (STATE BUILDING CODE, STATE LIFE SAFETY & FIRE CODE ETC.)
- THE CONTRACTOR SHALL REVIEW ALL DOCUMENTS AND VERIFY ALL DIMENSIONS AND FIELD CONDITIONS, AND SHALL CONFIRM WORK IS BUILDABLE AS SHOWN. ANY CONFLICTS OR OMISSIONS, ETC. SHALL BE
- IMMEDIATELY REPORTED IN WRITING TO THE ARCHITECT FOR CLARIFICATION
- DIMENSIONS ARE FROM EXTERIOR FACE OF FOUNDATION, VENEER, OR WALL STUD AND TO CENTER OF ALL INTERIOR STUD WALLS OR FACE OF INTERIOR MASONRY. UNLESS NOTED OTHERWISE.
- CLEAR DIMENSIONS ARE FROM FACE TO FACE OF WALL FINISH. UNLESS NOTED OTHERWISE REFER TO MECHANICAL DRAWINGS / SPEC. FOR ALL SIZES AND LOCATIONS OF MECHANICAL DUCT WORK.
- UNLESS OBVIOUSLY SHOWN OTHERWISE, DOOR LOCATIONS NOT DESIGNATED BY WRITTEN DIMENSION SHALL BE CENTERED IN THE WALL OR SHALL BE LOCATED FOUR (4) INCHES FROM FINISH WALL TO EDGE OF DOOR
- PROVIDE METAL CORNER BEAD AT ALL OUTSIDE CORNERS OF PLASTERED OR DRYWALL SURFACES, UNLESS NOTED OTHERWISE PENETRATIONS OF ALL FIRE RATED ASSEMBLIES SHALL BE PROTECTED BY LIKE RATED CONSTRUCTION DAMPERS, SEALANTS, COLLARS, ETC., TYPICAL.
- CONTRACTOR SHALL FURNISH, LOCATE AND INSTALL ALL ACCESS PANELS AS REQUIRED AFTER INSTALLATION OF MECHANICAL DUCTS, PLUMBING AND ELECTRICAL WORK, FIRE RATED AS REQUIRED.
- FURNISH AND INSTALL SOLID BLOCKING BEHIND ALL WALL HUNG MILLWORK ITEMS, RAILS, FIXTURES, GRAB BARS, ETC. . WHERE INDICATED OR REQUIRED. CONTRACTOR SHALL LAYOUT OR MARK, ALL EQUIPMENT, SYSTEMS AND MILLWORK ON THE FLOOR FOR ARCHITECT OR OWNER'S APPROVAL PRIOR TO BEGINNING CEILING / OVER HEAD WORK.
- ALL SPRINKLER HEAD LOCATIONS, MAINS, BRANCHES AND RISER PIPE LOCATIONS MUST BE COORDINATED WITH THE DESIGN / BUILD CONTRACTOR PRIOR TO WORK. FURNISH AND INSTALL FIRE EXTINGUISHERS IN TYPE, QUANTITY, AND LOCATION PER LOCAL FIRE DEPARTMENT. TYPICAL
- CONTRACTOR SHALL VERIFY, COORDINATE LOCATION WITH THE ARCHITECT ANY SMOKE, CARBON MONOXIDE DETECTOR OR FIRE ALARM DEVICE AS REQUIRED BY THE LOCAL FIRE DEPARTMENT. FURNISH & INSTALL FIRE DAMPERS WITH FUSIBLE LOUVER WHEREVER DUCT WORK PENETRATES ONE OR TWO HOUR CEILINGS OR WALLS. TYPICAL UNLESS NOTED OTHERWISE. 20. PROVIDE PLASTER AND GYPSUM WALL BOARD CONTROL JOINTS AT 30'-0" ON CENTER FROM FLOOR TO CEILING, OR AS NOTED ON THE CONSTRUCTION DOCUMENTS. VERIFY IN FEILD WITH ARCHITECT PRIOR TO WORL
- SHEET NUMBER

COVER SHEET

PROJECT

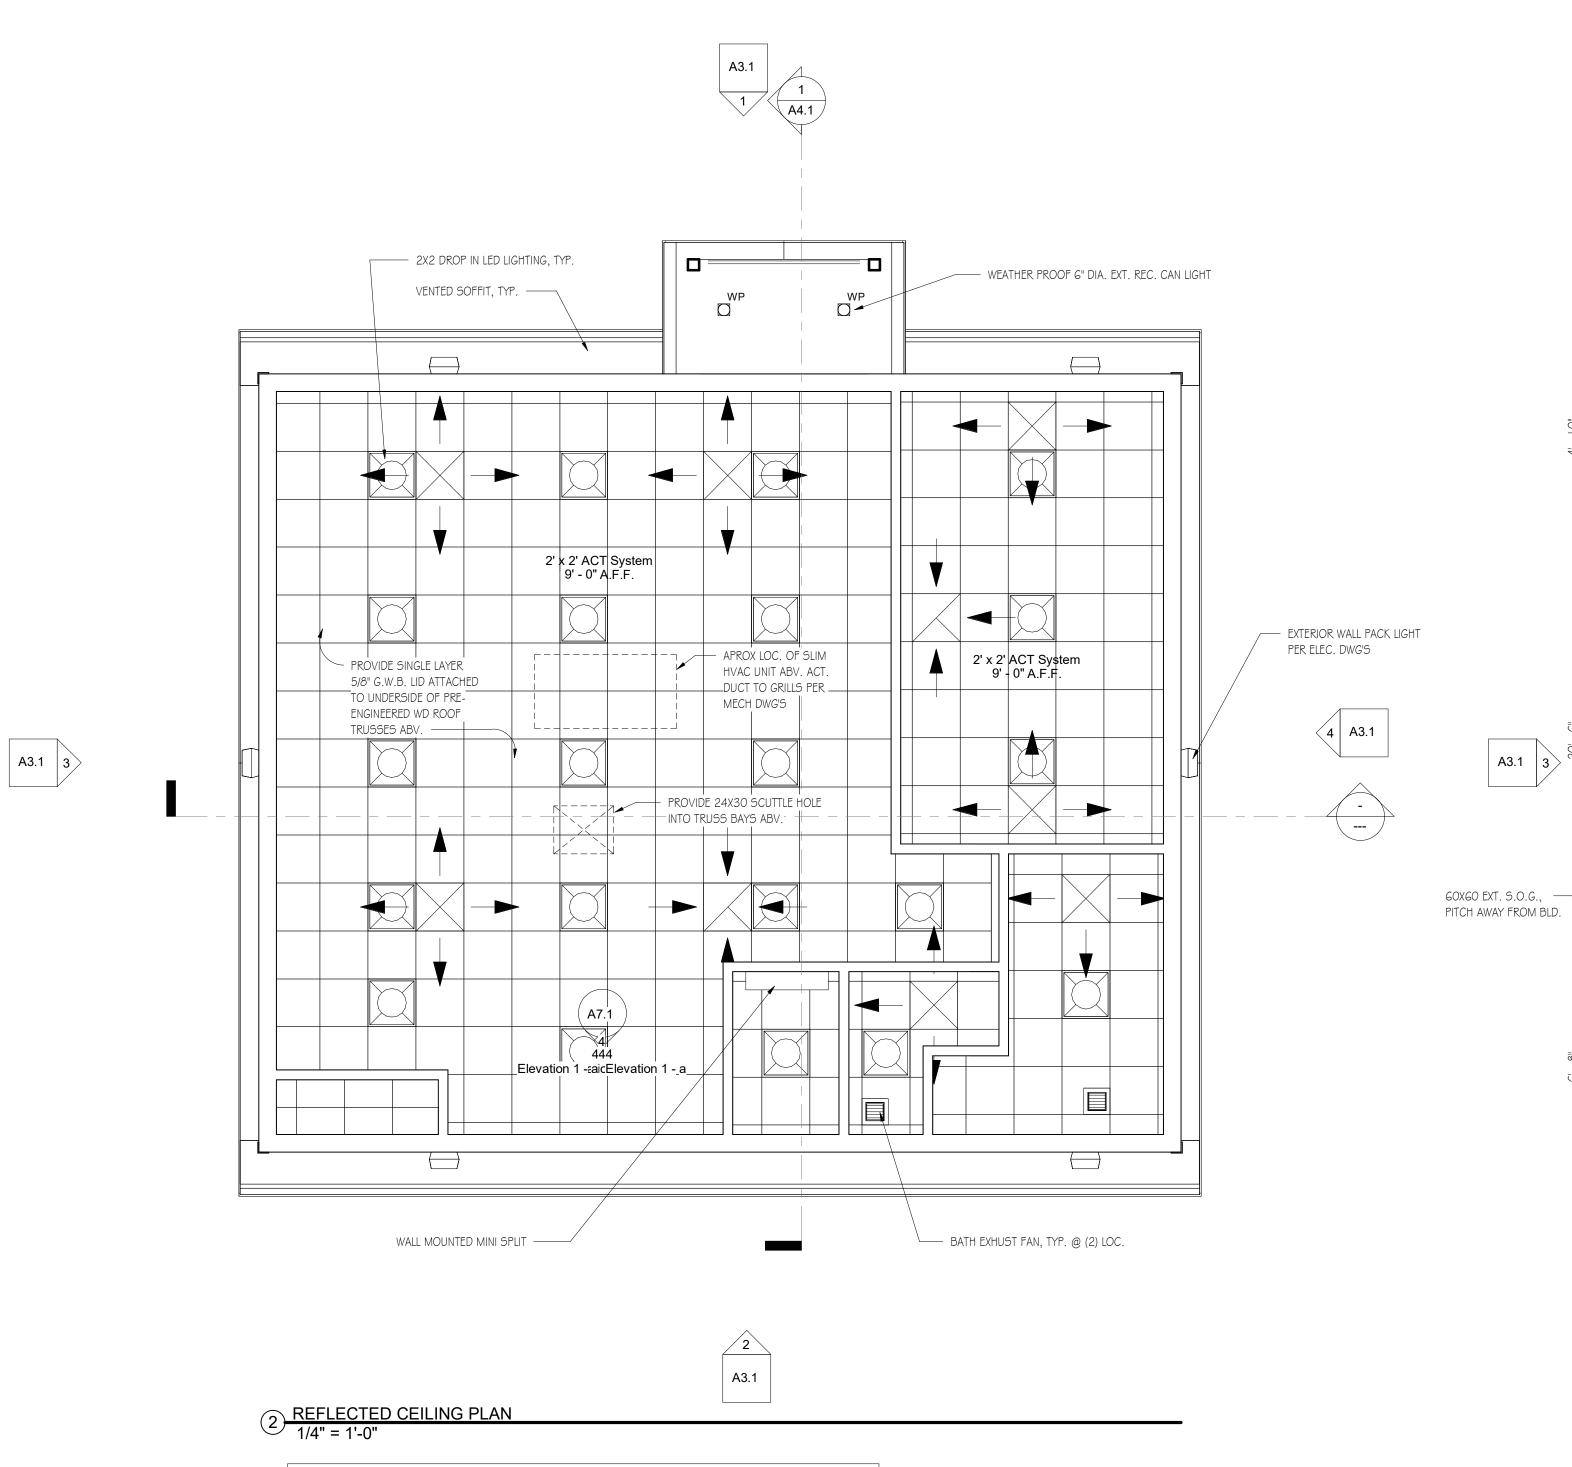

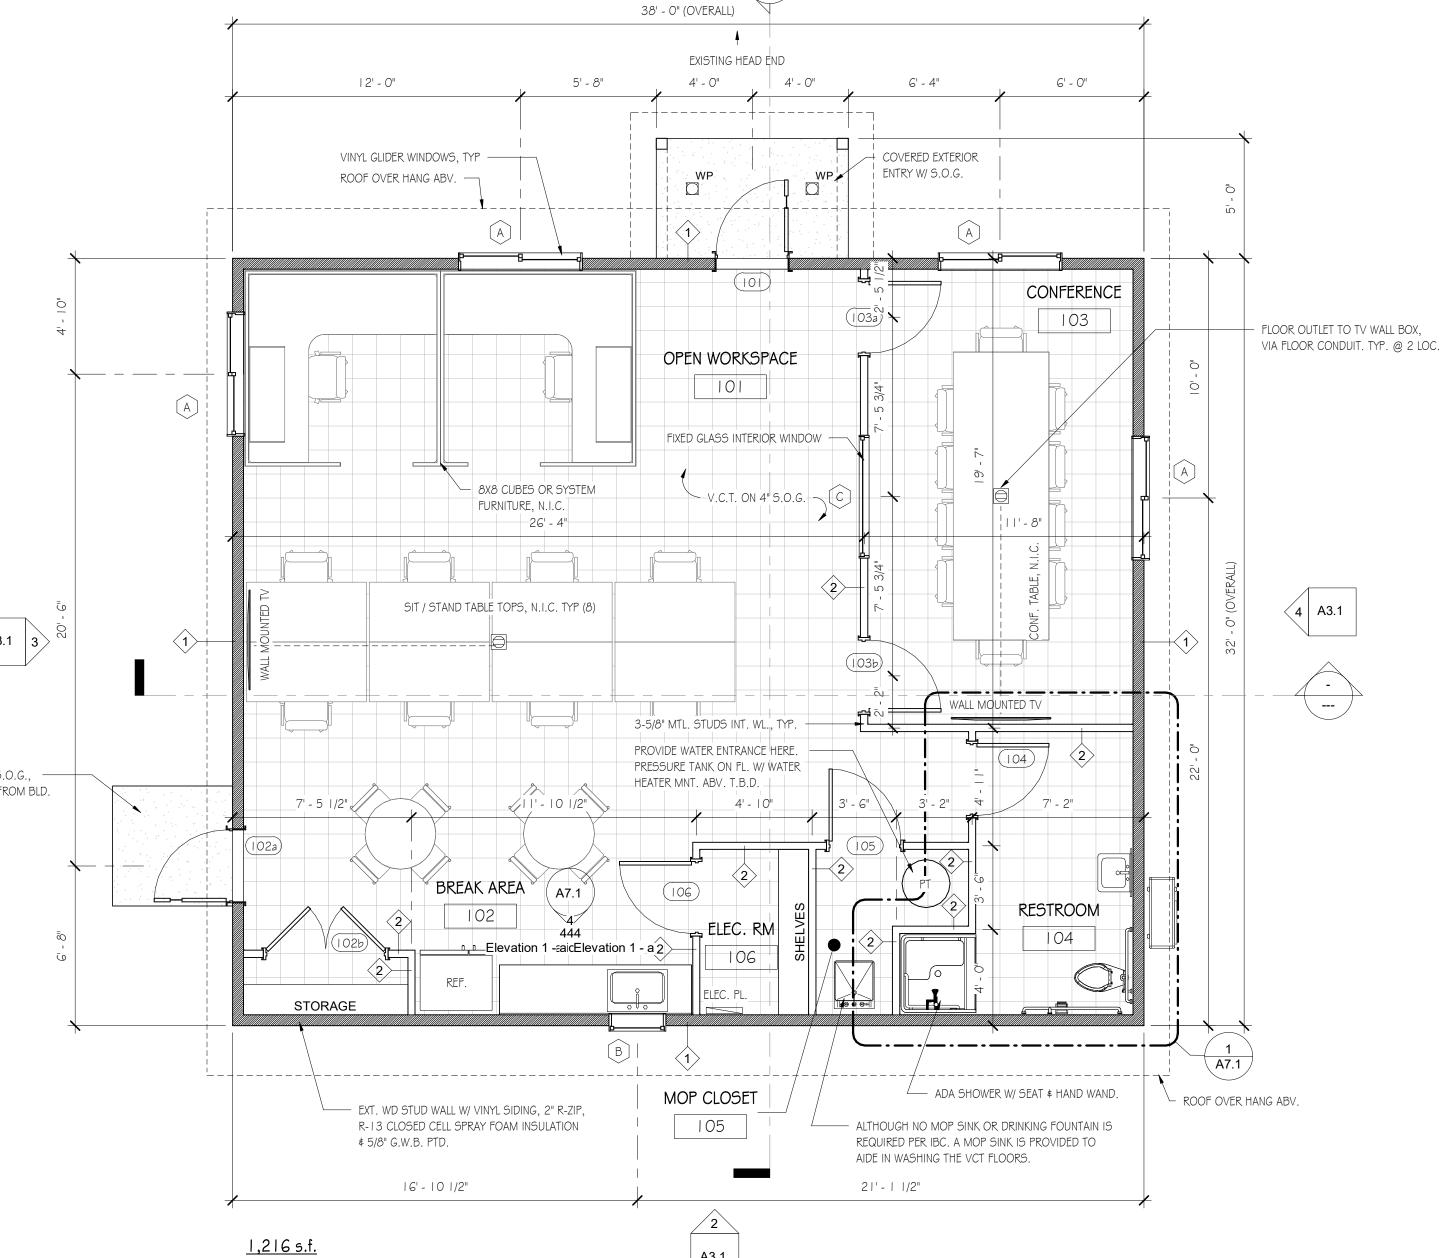

A3.1

1) FIRST FLOOR PLAN
1/4" = 1'-0"

R.C.P. NOTES:

I. HVAC GRILLS & THEIR LOCATIONS T.B.D.

2. HVAC SLIM PACKAGE UNIT SHALL BE HUNG FROM THE BOT. OF ROOF TRUSS @ | | 1'-6", ABOVE THE A.C.T. @ 9'-0" | 3. BOT. OF ROOF TRUSS SHALL BE SHEATHED W/ ONE LAYER OF 5/8" G.W.B. FOR PURPOSE OF AIT INFILTRATION.

4. R-49 BLOWN IN INSULATION IN TRUSS CAVITY.

5. PROVIDE SCUTTLE HOLE IN G.W.B. TO ACCESS TRUSS CAVITY.

PROJECT NORTH

Revision Schedule

P: 603.664.2181 | F: 603.664.9508

BREEZELINE UNCASVILLE

689 Old Colchester Rd. Uncasville, CT

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 30% PROGRESS SET

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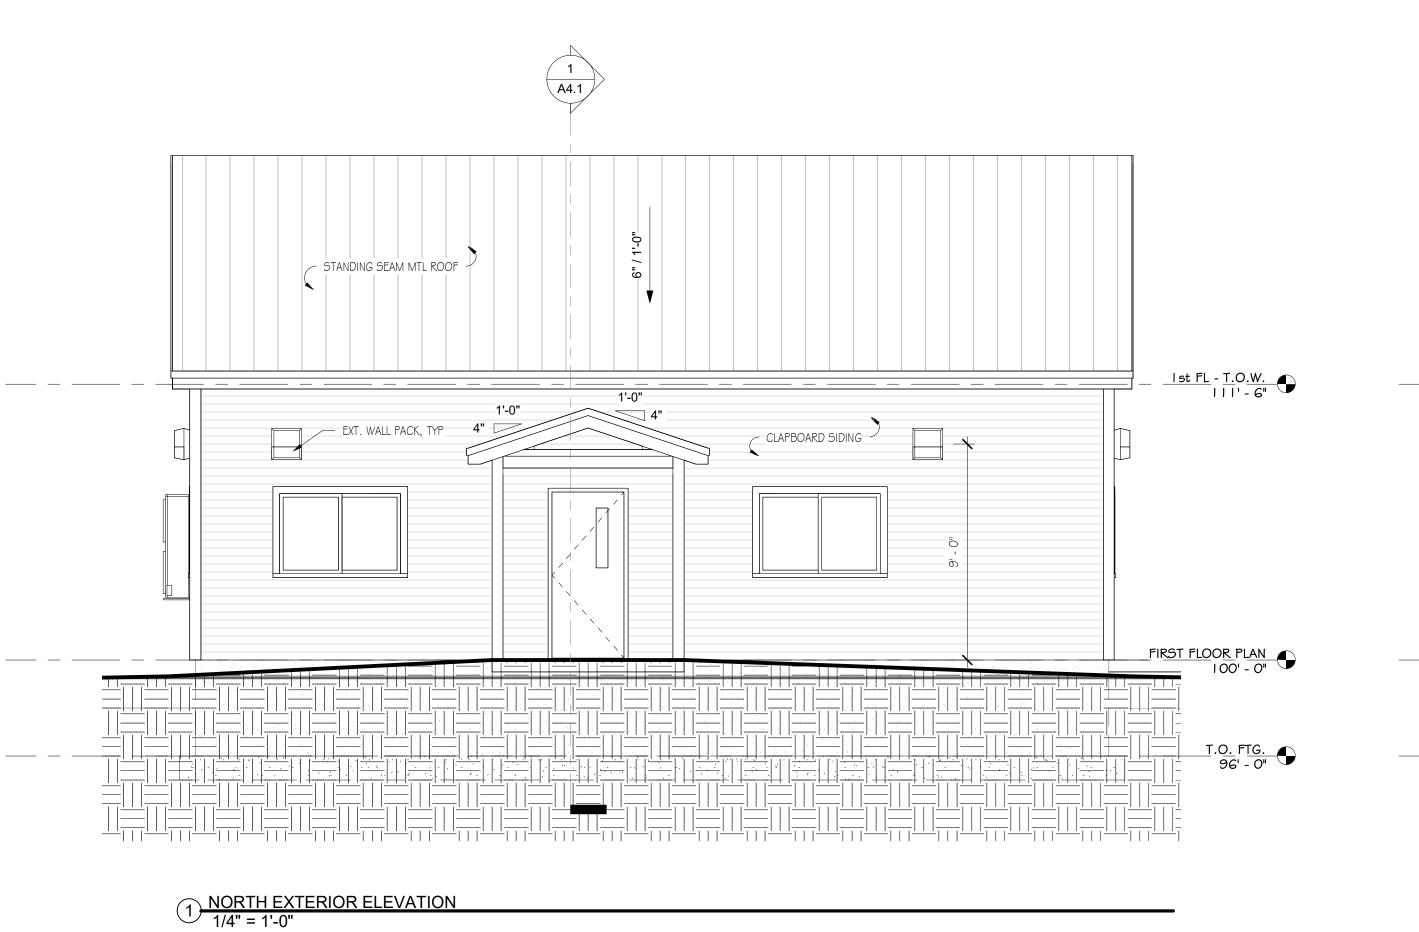
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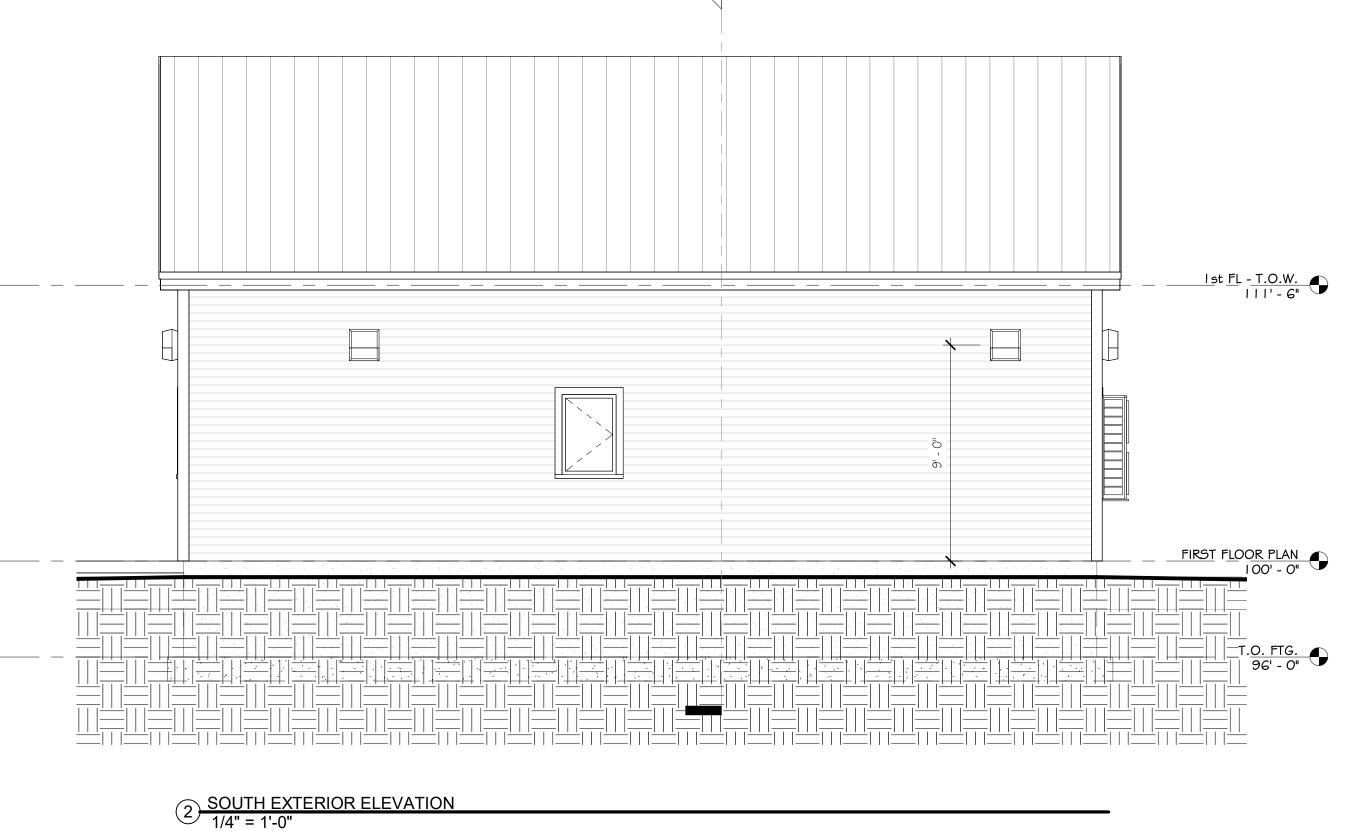
1/4" = 1'-0" SCALE:


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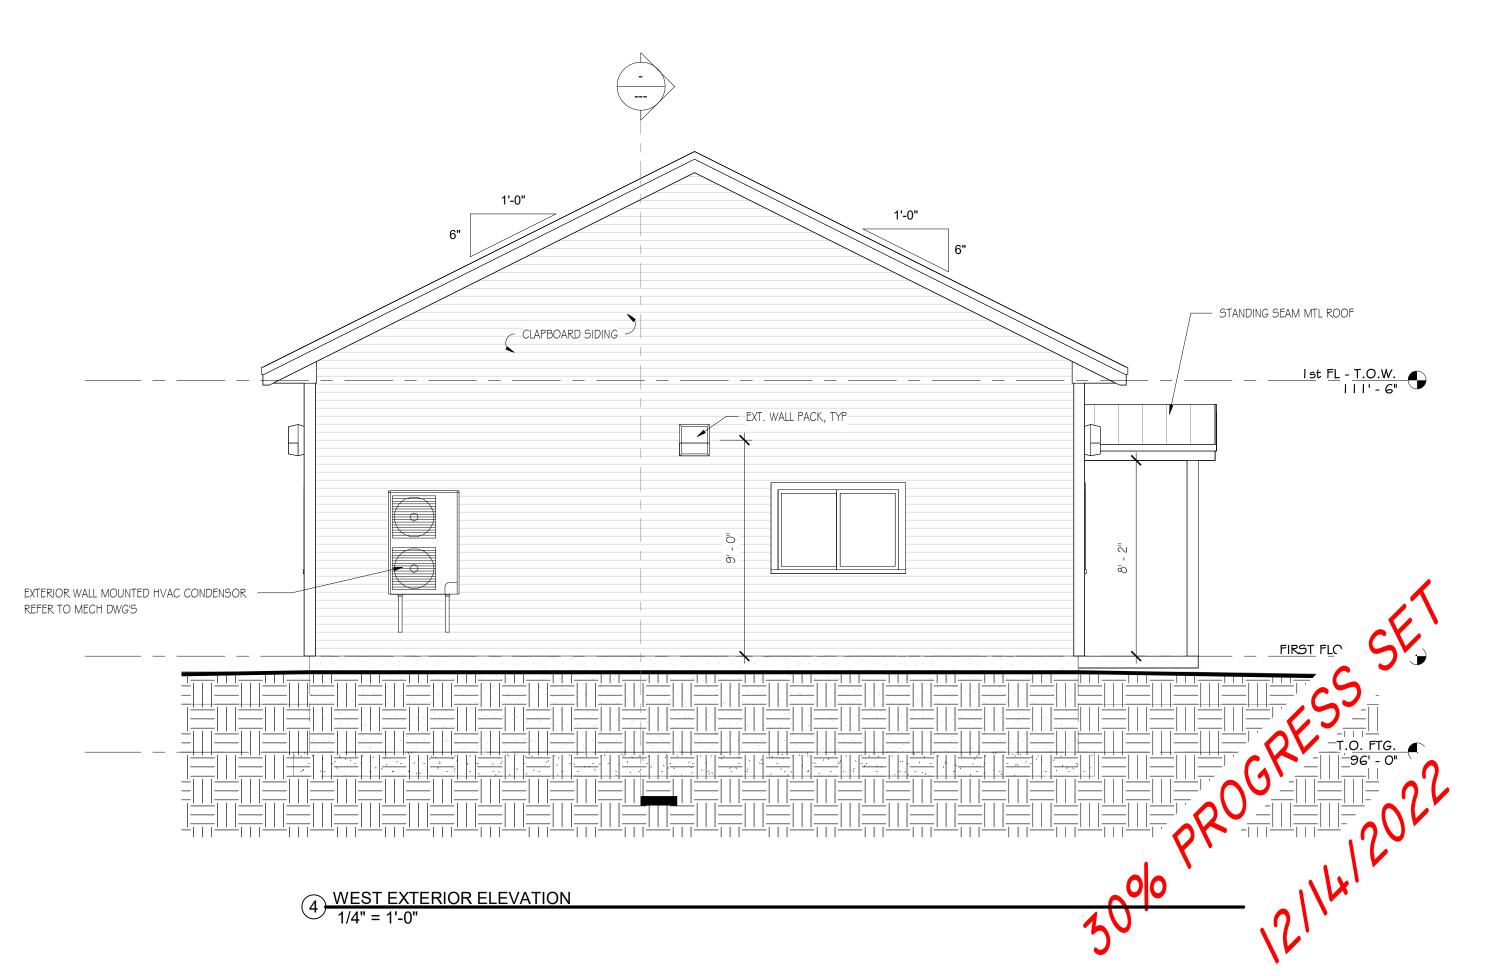
Sheet Number:

Printed on: 12/14/2022








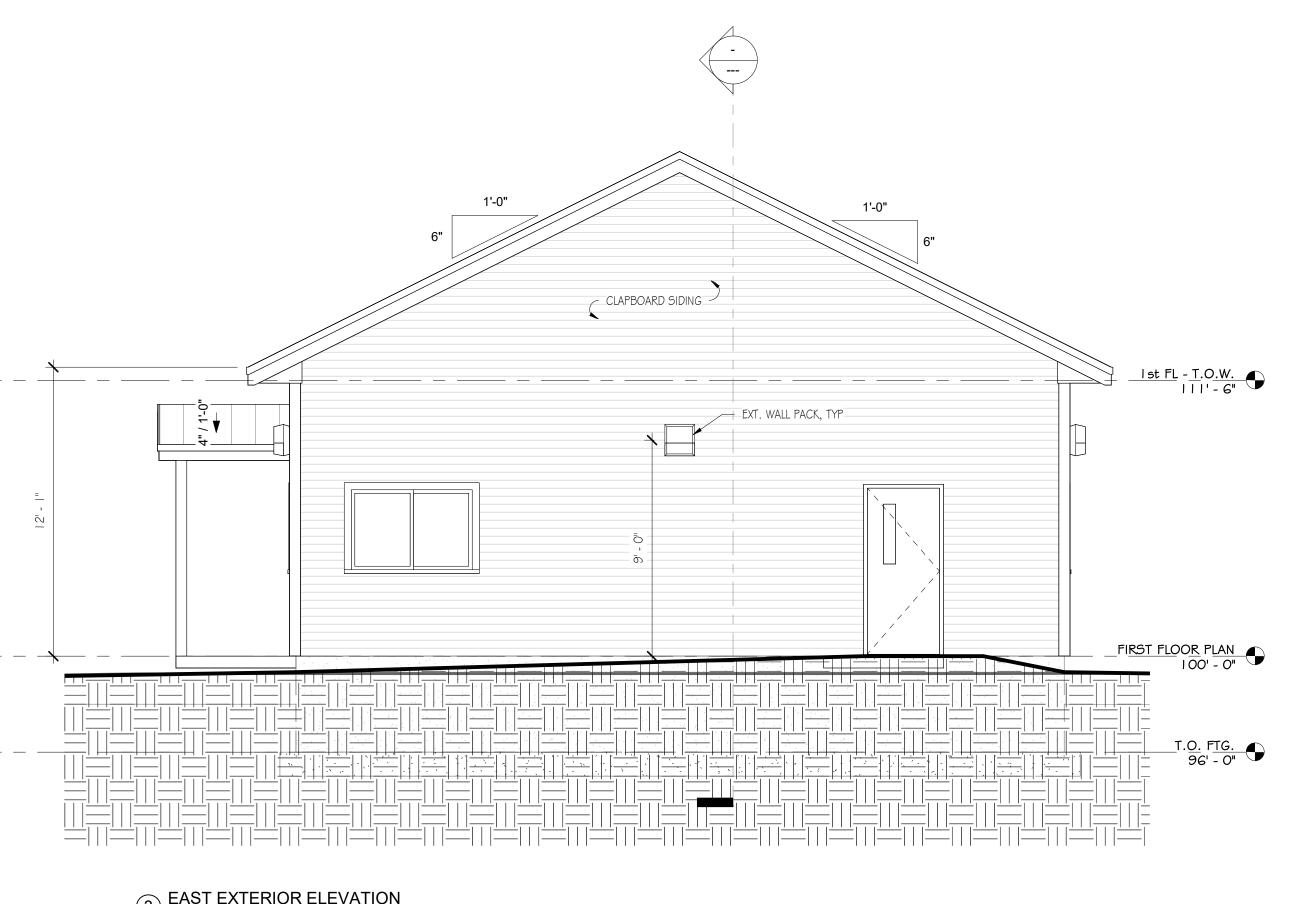



254 DRAKE HILL RD. STRAFFORD, NH P: 603.664.2181 | F: 603.664.9508

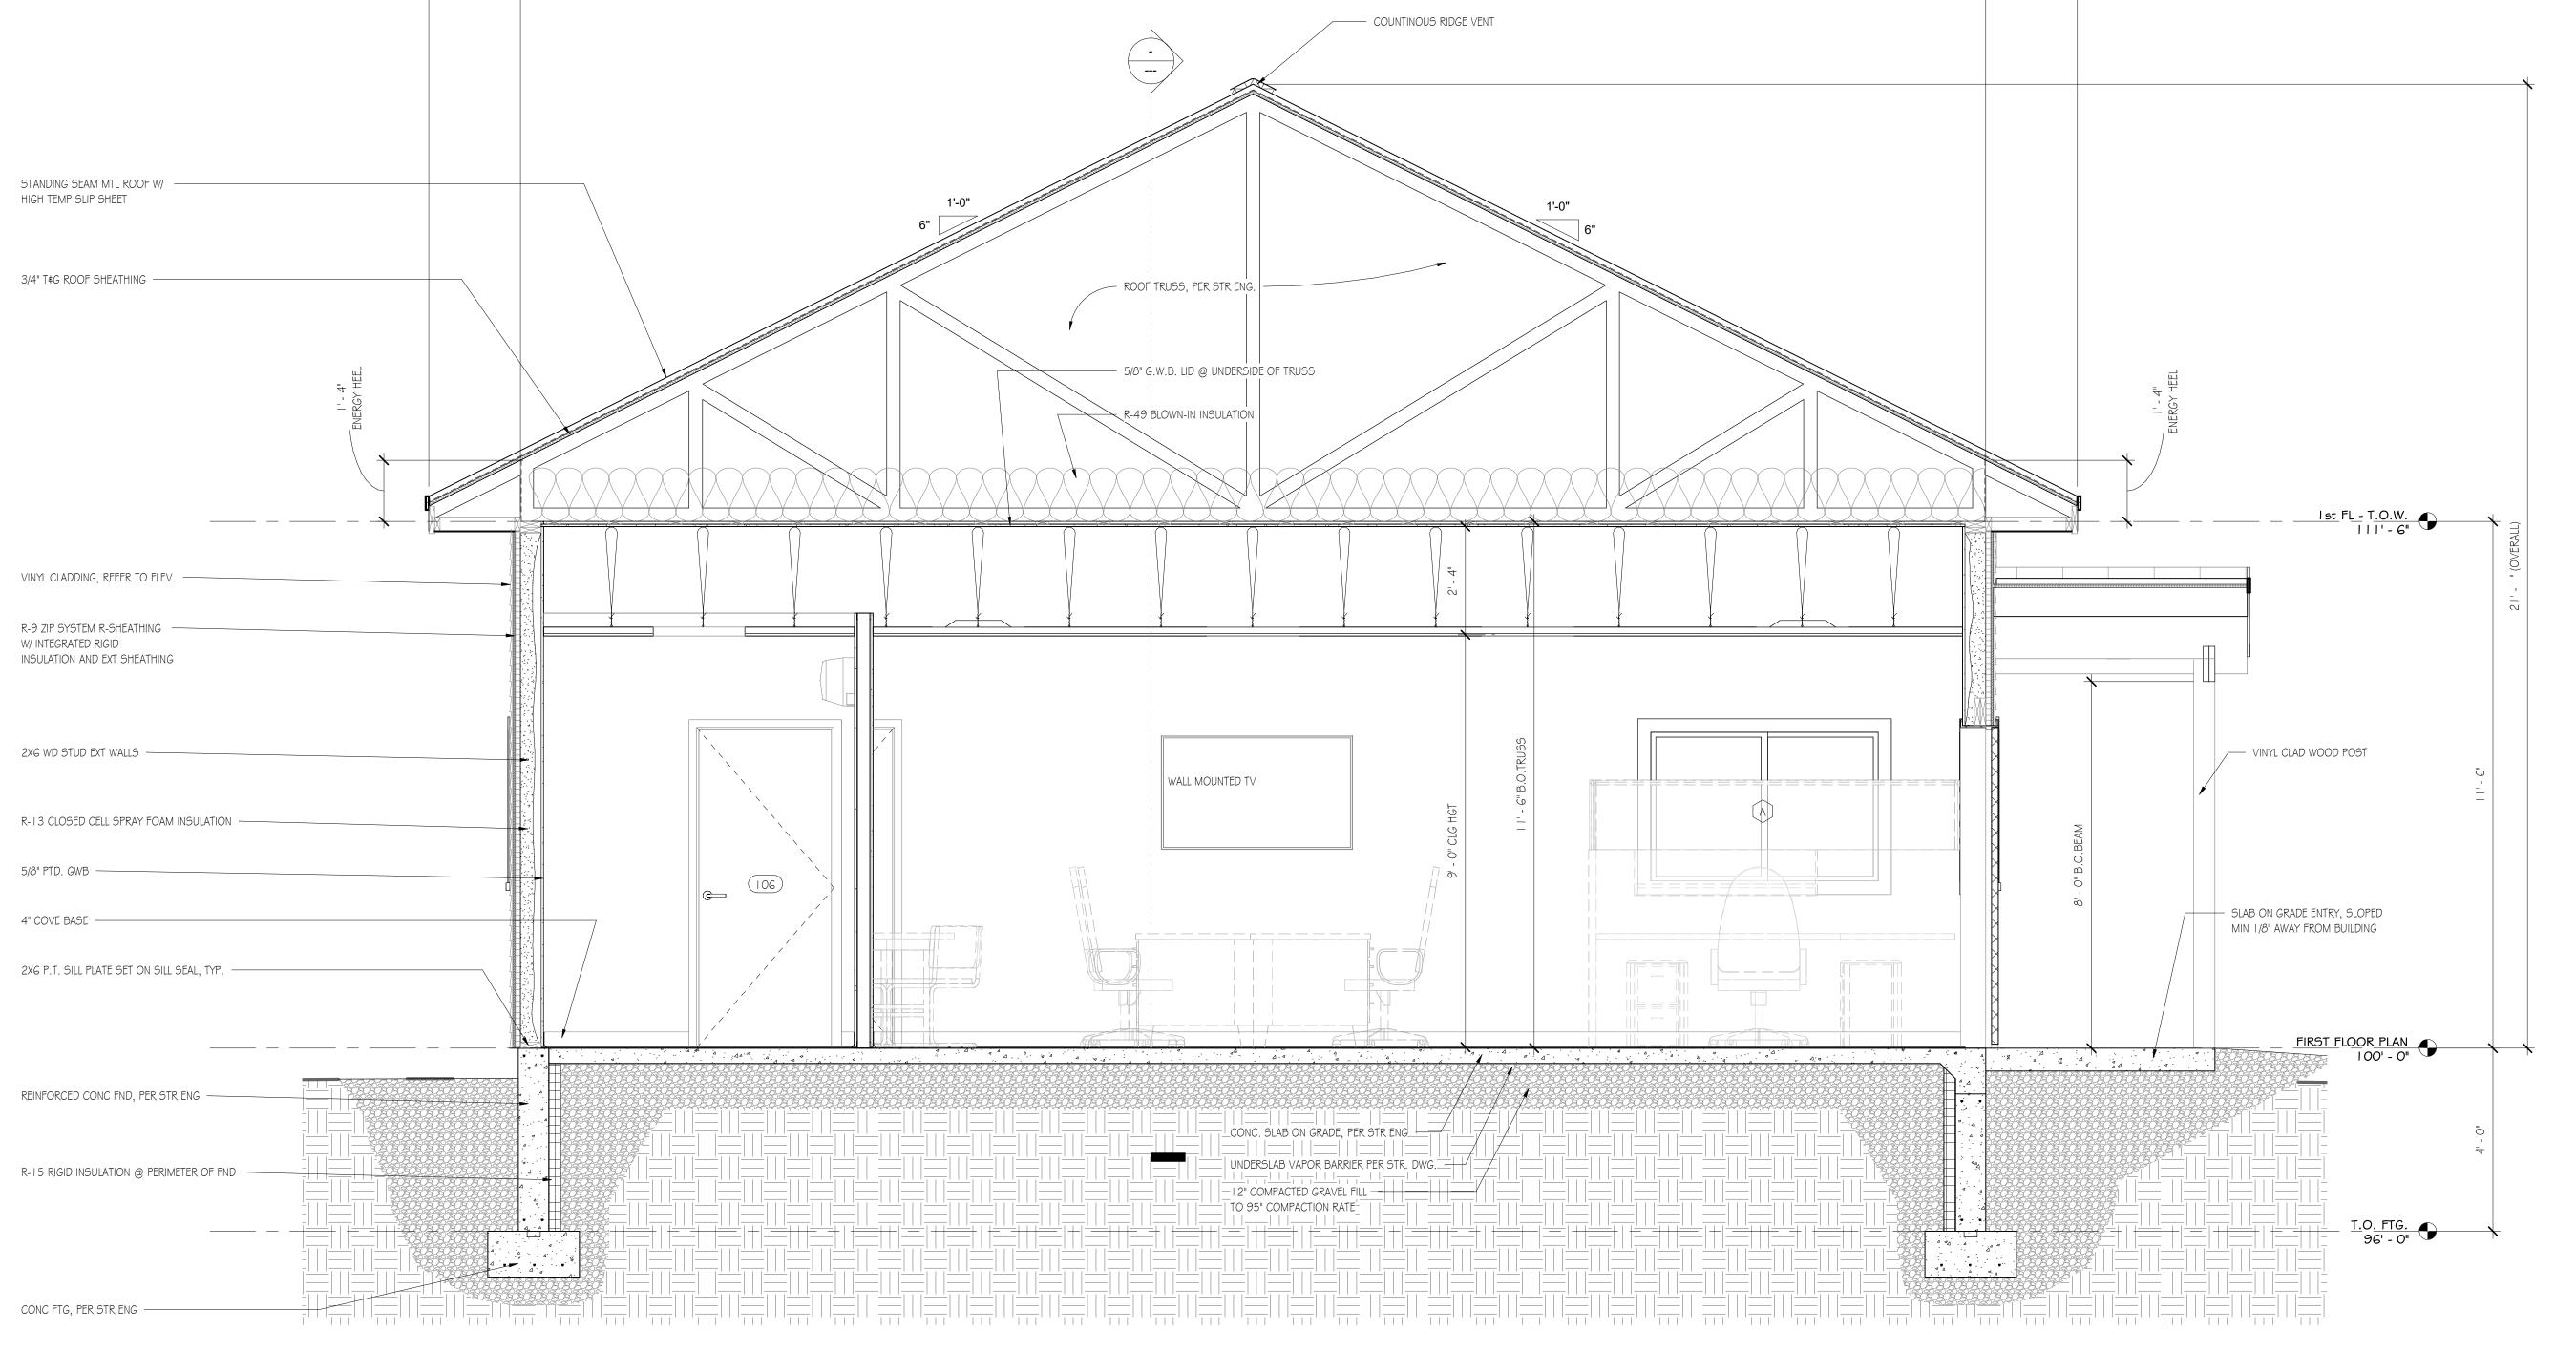

32' - 0"

SECTION 'A'

200 PROGRESS SK

No. Description Date

Revision Schedule

Project Info: BREEZELINE UNCASVILLE CT

689 Old Colchester Rd. Uncasville, CT

Sheet Status: Latest Release:

Issued For: 30% PROGRESS SET Org. Issue Date: 12/13/22 (N.F.C.)

B NO: 22044
RAFTED: Author
Checker


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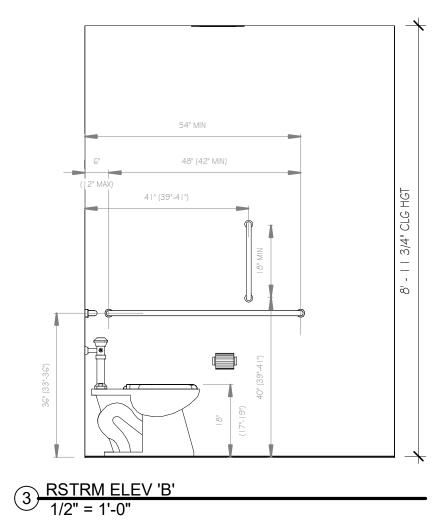
BUILDING


SECTIONS

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BREEZELINE UNCASVILLE CT

Revision Schedule

254 DRAKE HILL RD. STRAFFORD, NH P: 603.664.2181 | F: 603.664.9508
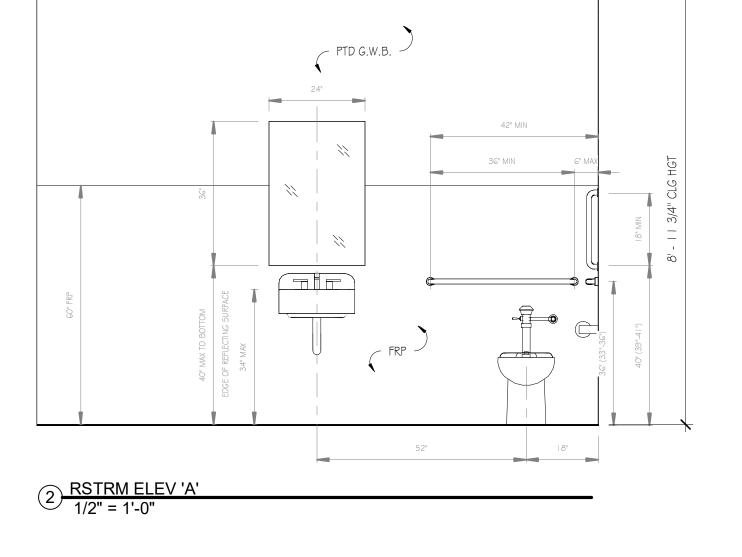
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As indicated

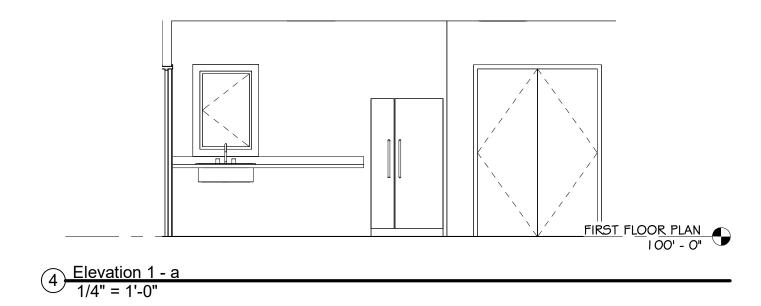Sheet Title:

ENLARGED RESTROOM AND INT ELEVATIONS

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