


C-1 / RT 32 OZ DISTRICT MAP 70 LOT 010-000

PROPOSED 22 UNIT CONDOMINIUM DEVELOPMENT

245 NORWICH-NEW LONDON ROAD (CT ROUTE 32) MONTVILLE, CONNECTICUT

> APPLICANT WESTERN GROUP, LLC 338 Westport Road Wilton, CT

> OWNER WESTERN GROUP, LLC 338 Westport Road Wilton, CT

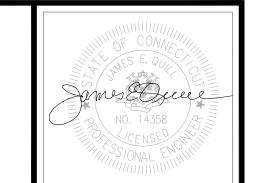

Office (203) 333-9465 fax (203) 336-1769

T CONDOMINICS NORWICH-NEW LONG MONTVILLE, CONNPRED FOR WESTERN GRO 22 UNIT 245 N

Job Number: FE22-1700

Job Start Date: 1/4/22

Building Mods/Cond. of Approval 08/10/22

Drawn By: Checked By

Sheet Title:

COVER SHEET

Sheet Number: C-0

EXPIRATION DATE


SEC PLAN APPROVAL DATE


DRAWING LIST


SHEET NO.	SHEET NAME	PLAN DATE	LATEST REVISION
C-0	COVER SHEET	01/25/22	08/10/22
	IMPROVEMENT LOCATION PLAN	01/07/22	08/10/22
C-2.1	SITE LAYOUT PLAN	01/25/22	08/10/22
C-3.1	GRADING, DRAINAGE PLAN	01/25/22	08/10/22
C-3.2	UTILITY PLAN	01/25/22	08/10/22
C-4.1	SOIL EROSION & SEDIMENT CONTROL PLAN	01/25/22	08/10/22
C-4.2	SOIL EROSION & SEDIMENT CONTROL NOTES & DETAILS	01/25/22	08/10/22
C-5.1	LANDSCAPE & LIGHTING PLAN	01/25/22	08/10/22
C-6.1	DETAIL SHEET	01/25/22	08/10/22
C-6.2	DETAIL SHEET	01/25/22	08/10/22
C-6.3	DETAIL SHEET	01/25/22	08/10/22

ARCHITECTURAL DRAWINGS 03/10/22 03/10/22 **ELEVATIONS UNITS 10-22** 03/10/22 03/10/22 03/10/22 03/10/22 03/10/22 03/10/22 03/10/22

03/10/22 03/10/22 03/10/22

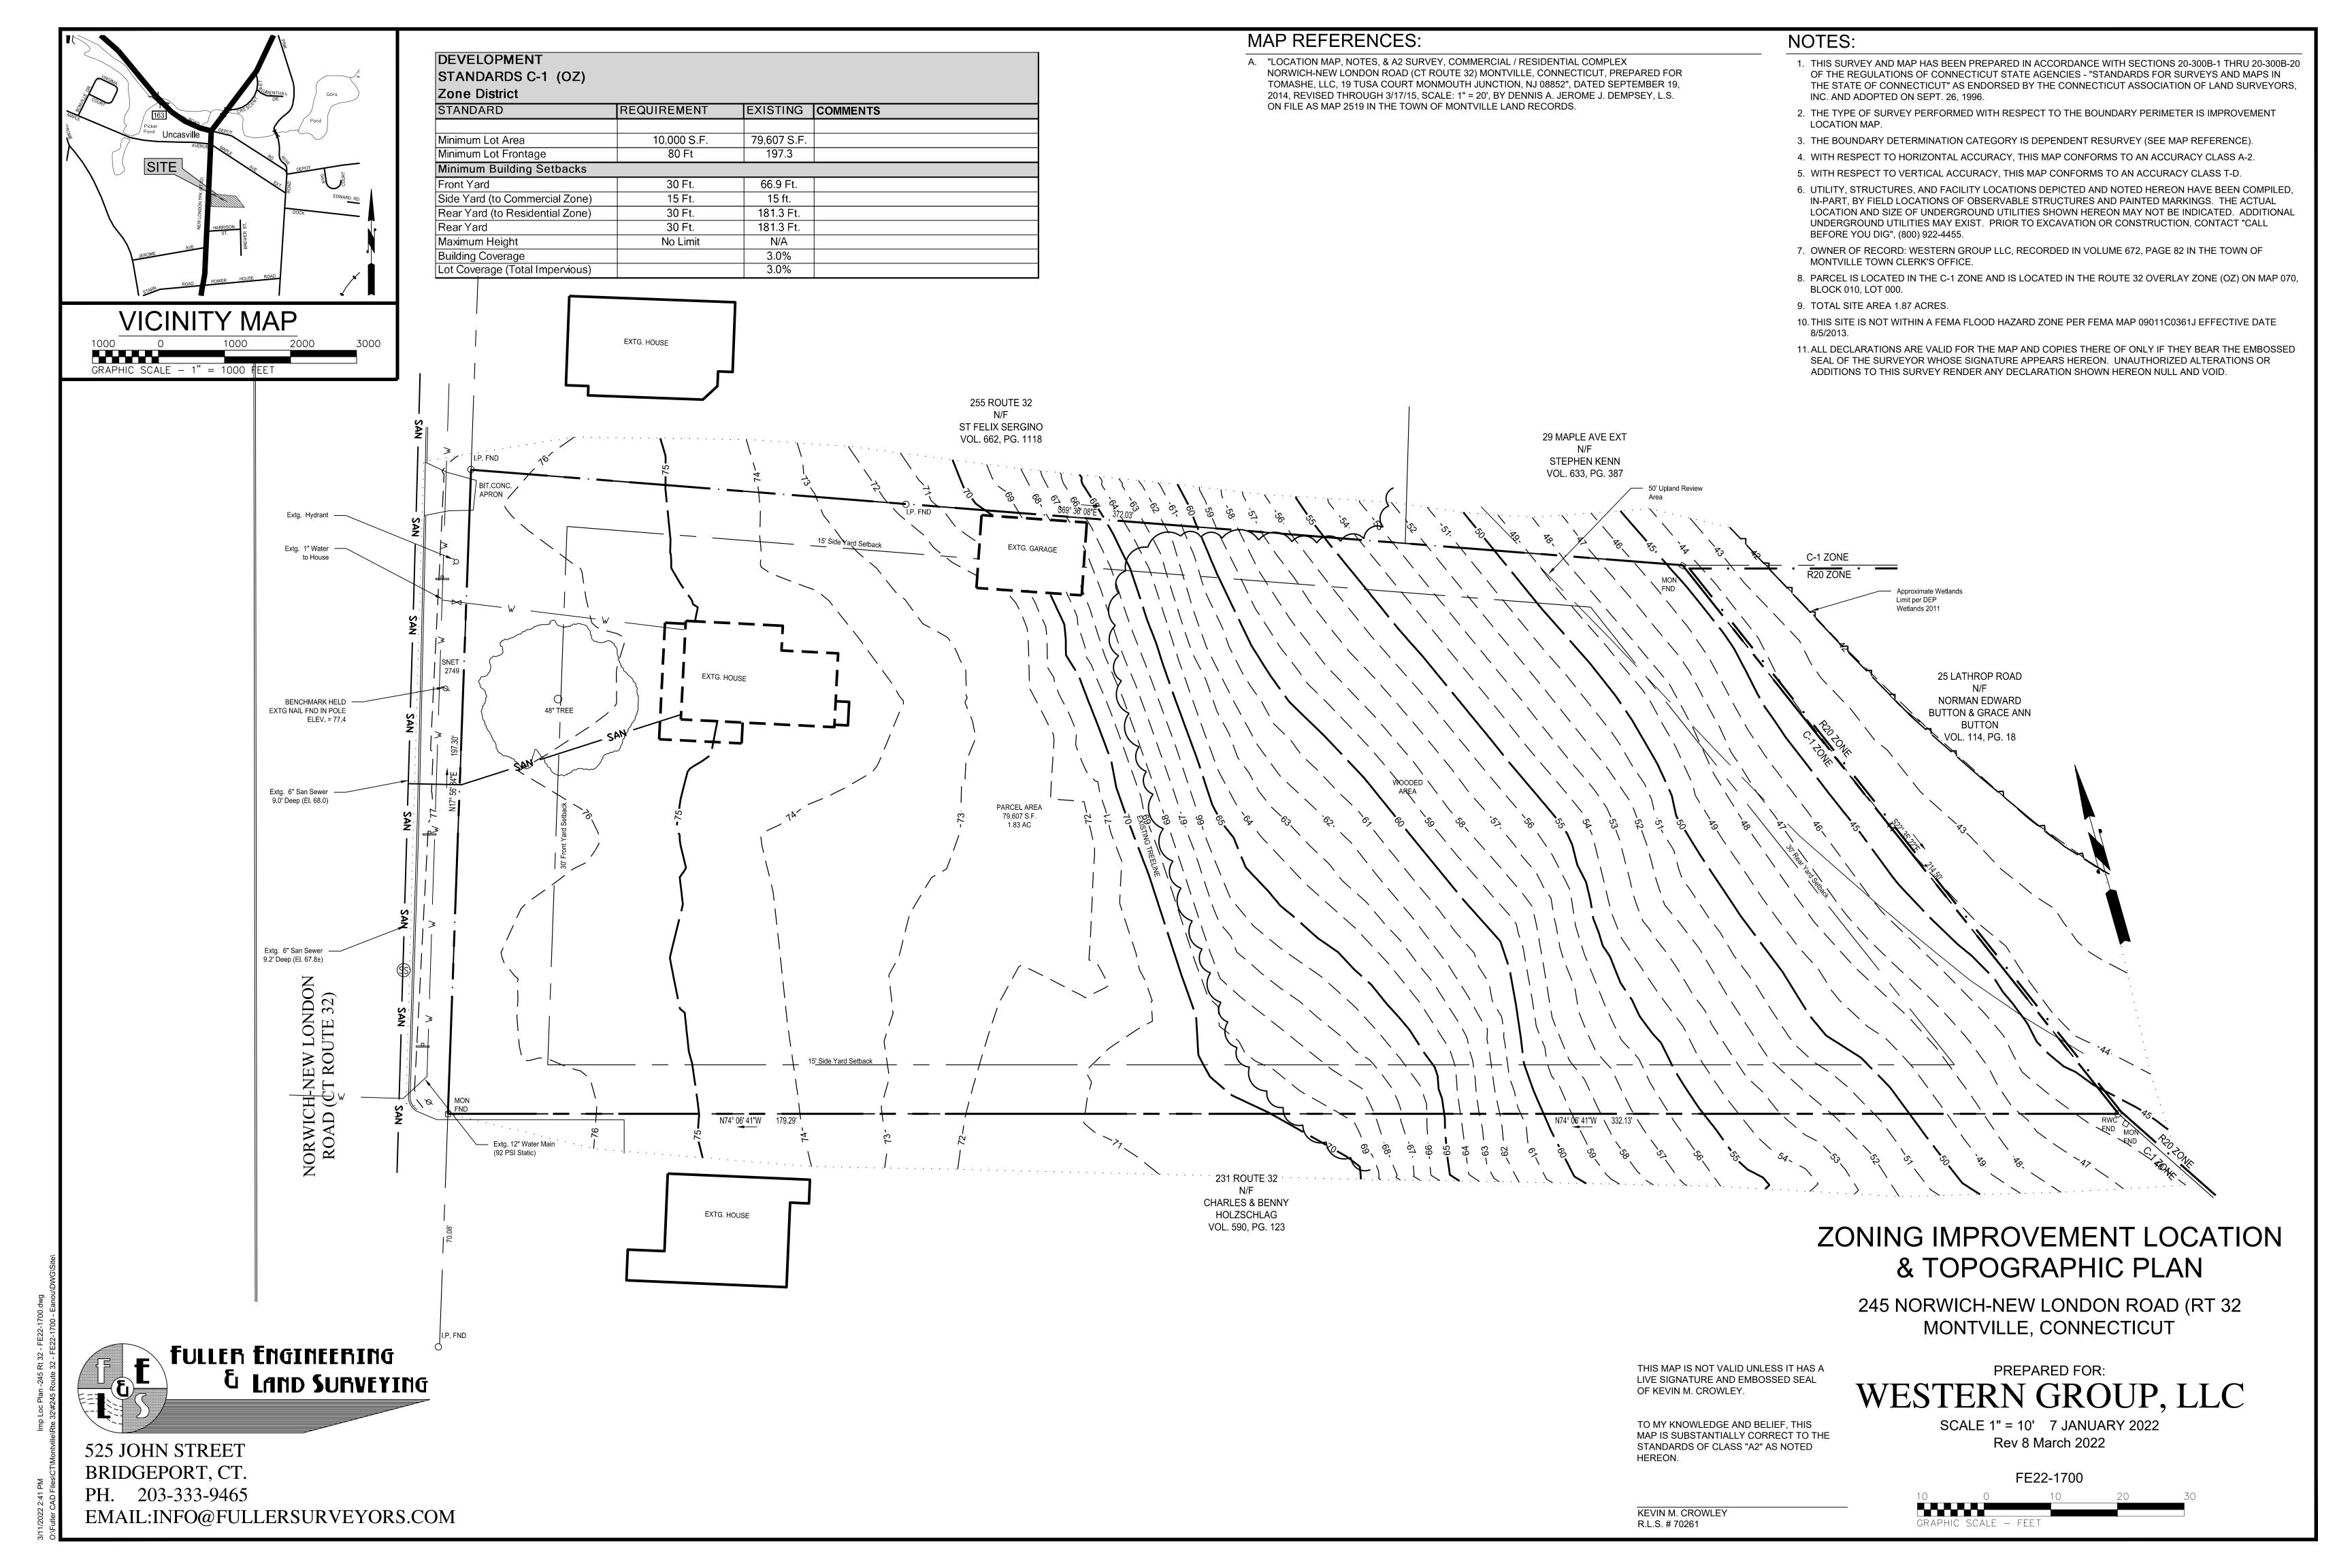

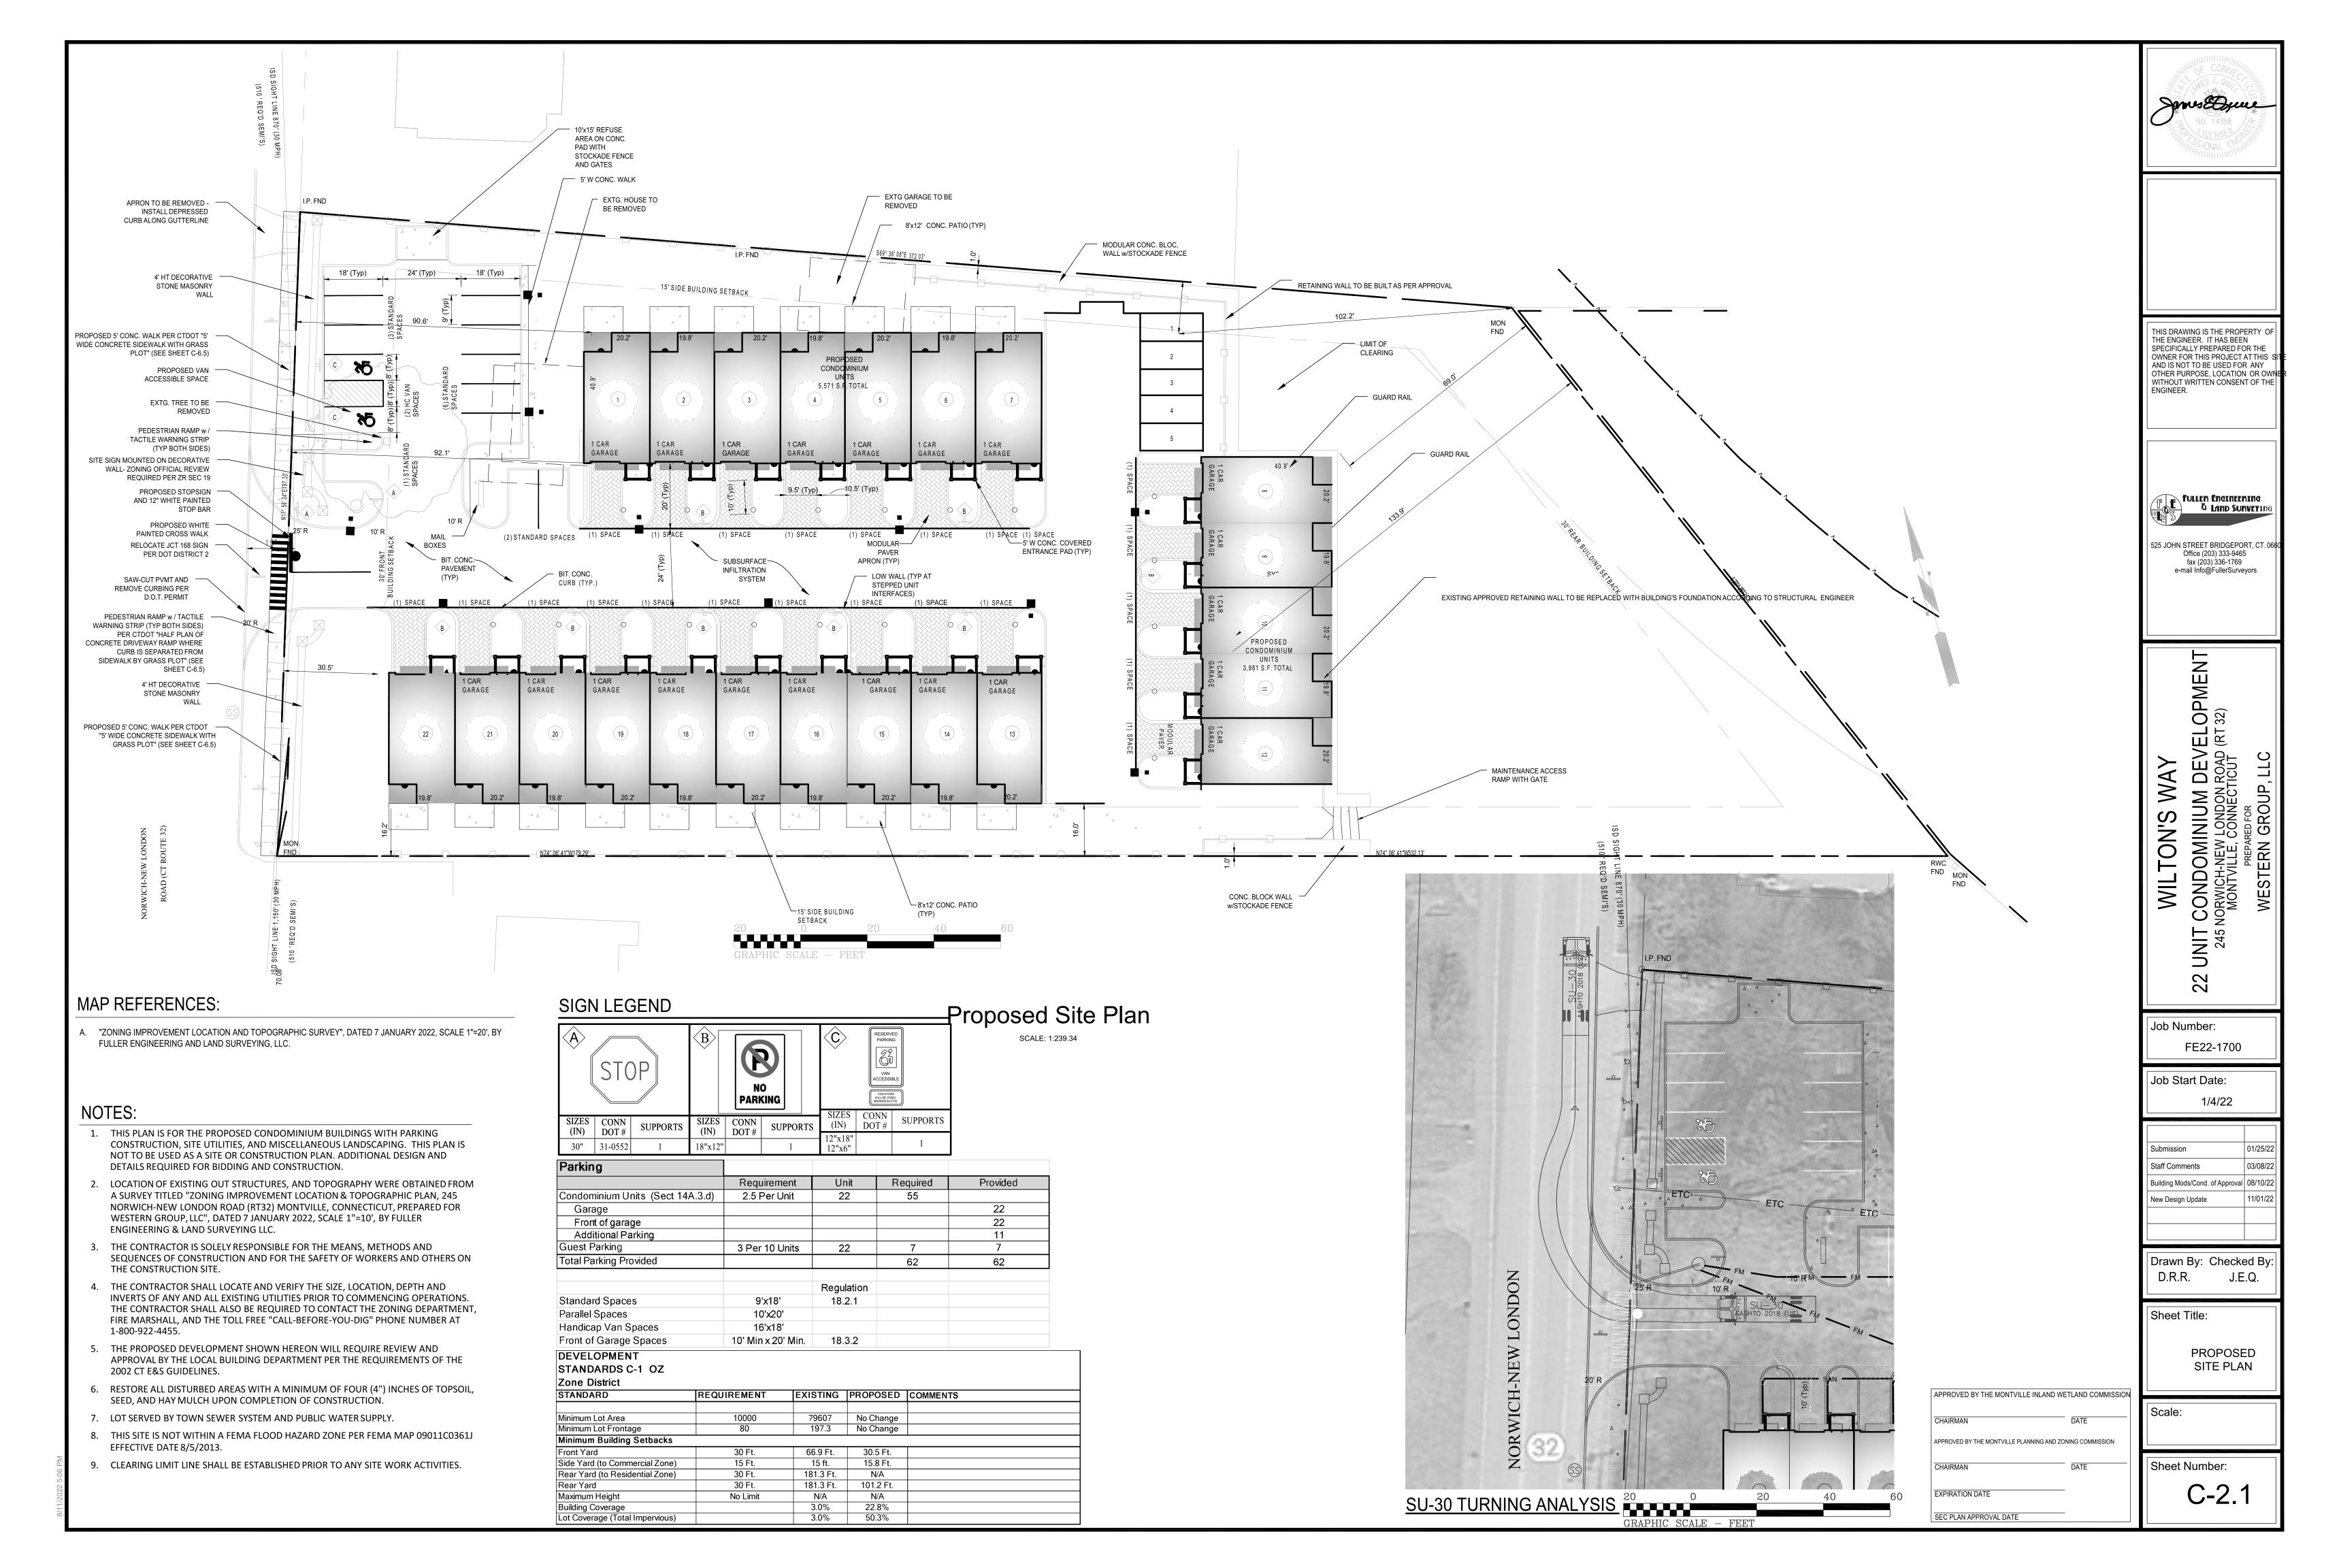

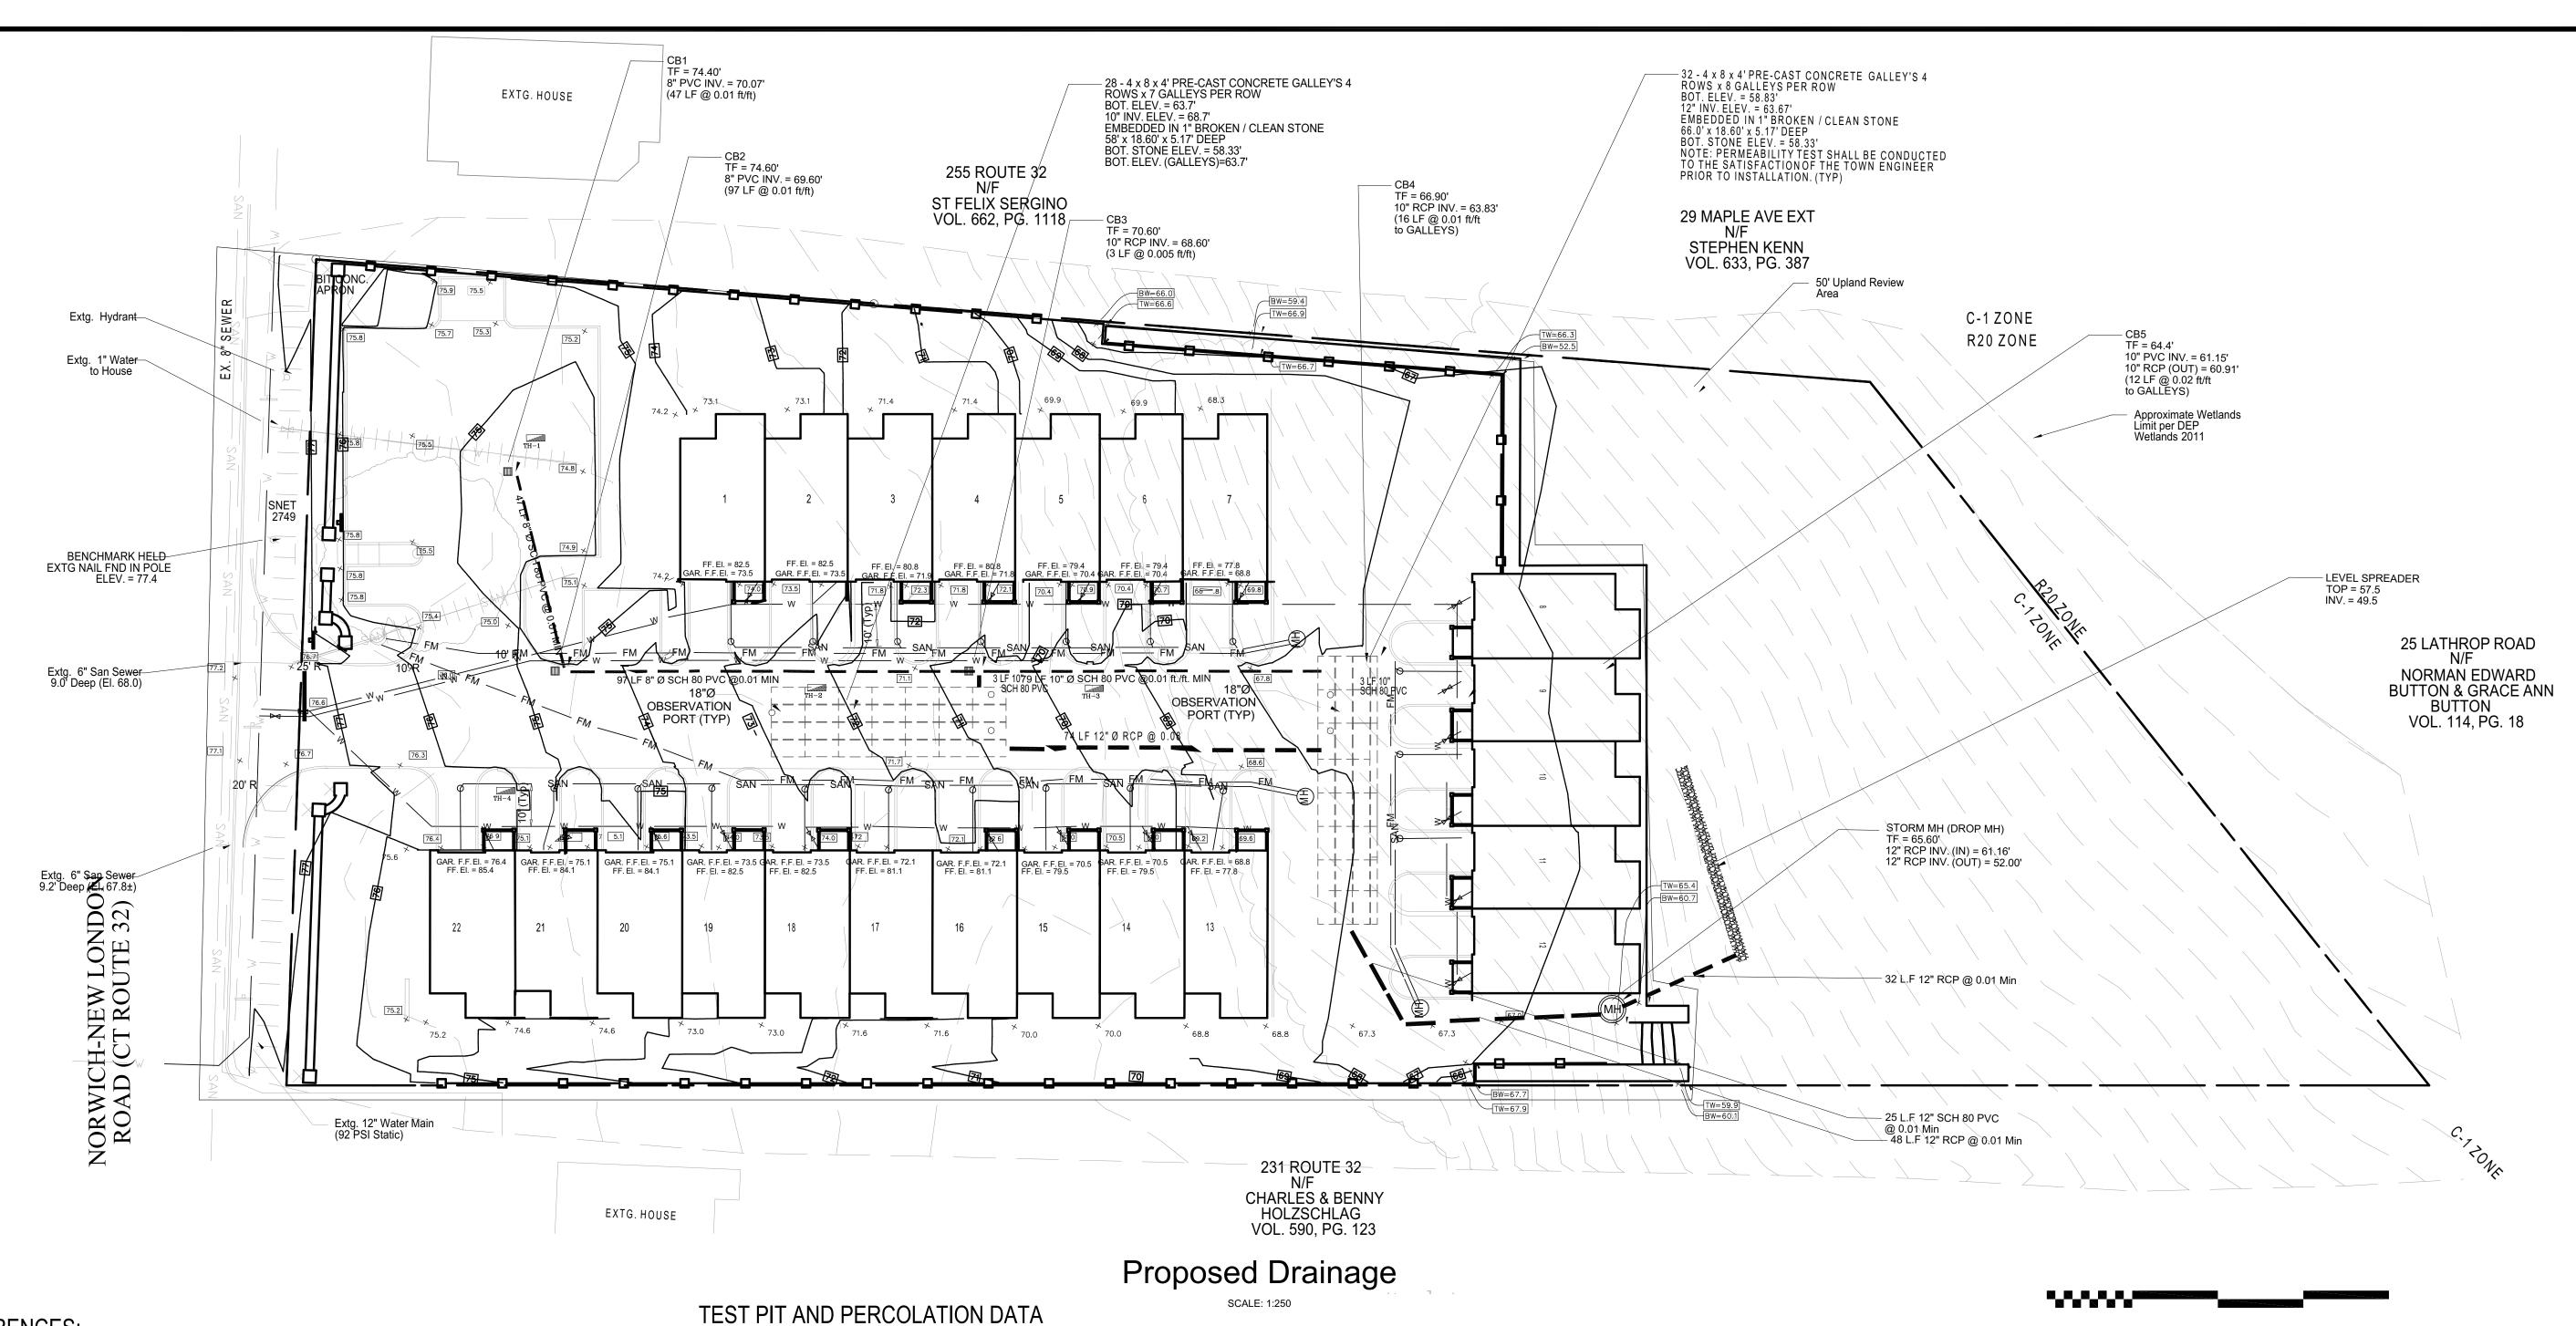

MAP REFERENCES:

A. "ZONING IMPROVEMENT LOCATION AND TOPOGRAPHIC SURVEY", DATED 7 JANUARY 2022, SCALE 1"=20', BY FULLER ENGINEERING AND LAND SURVEYING, LLC.

NOTES:

- 1. THIS PLAN IS FOR THE PROPOSED GRADING AND DRAINAGE FOR THE CONSTRUCTION OF A RESIDENTIAL DEVELOPMENT WITH PARKING, AND MISCELLANEOUS LANDSCAPING ALONG THE CT ROUTE 32. THIS PLAN IS NOT TO BE USED AS A SITE OR CONSTRUCTION PLAN. ADDITIONAL DESIGN AND DETAILS REQUIRED FOR BIDDING AND CONSTRUCTION.
- 2. THE CONTRACTOR IS SOLELY RESPONSIBLE FOR THE MEANS, METHODS AND SEQUENCES OF CONSTRUCTION AND FOR THE SAFETY OF WORKERS AND OTHERS ON THE CONSTRUCTION SITE.
- 3. THE CONTRACTOR SHALL LOCATE AND VERIFY THE SIZE, LOCATION, DEPTH AND INVERTS OF ANY AND ALL EXISTING UTILITIES PRIOR TO COMMENCING OPERATIONS. THE CONTRACTOR SHALL ALSO BE REQUIRED TO CONTACT THE TOLL FREE "CALL-BEFORE-YOU-DIG" PHONE NUMBER AT 1-800-922-4455.
- 4. THE PROPOSED DEVELOPMENT SHOWN HEREON WILL REQUIRE REVIEW AND APPROVAL BY THE MONTVILLE BUILDING DEPARTMENT, ZONING DEPARTMENT, AND FIRE MARSHAL'S OFFICE.
- 5. ALL WORK PERFORMED BY THE OWNER / DEVELOPER MUST INCLUDE IMPLEMENTATION OF AN APPROVED SOIL EROSION AND SEDIMENTATION PLAN IN ACCORDANCE WITH PUBLIC ACT No. 83-388 [PASSED BY THE CONNECTICUT GENERAL ASSEMBLY]. THE OWNER / DEVELOPER SHALL BE THOROUGHLY FAMILIAR WITH THE 2002 CONNECTICUT EROSION & SEDIMENTATION GUIDELINES.
- 6. RESTORE ALL DISTURBED AREAS WITH A MINIMUM OF FOUR (4") INCHES OF TOPSOIL, SEED, AND HAY MULCH UPON COMPLETION OF CONSTRUCTION.
- 7. LOT SERVED BY TOWN SEWER SYSTEM AND PUBLIC WATER SUPPLY.
- 8. ALL EXISTING UTILITY LINES THAT WILL BE DISCONNECTED MUST BE CAPPED OR TERMINATED ACCORDING TO THE TOWN OF MONTVILLE AND UTILITY COMPANY STANDARDS.
- 9. FINAL RETAINING WALL SYSTEM TO BE DESIGNED AND INSPECTED BY A CONNECTICUT LICENSED ENGINEER. STRUCTURAL DETAILS TO BE SUBMITTED TO THE SATISFACTION OF THE TOWN BUILDING INSPECTOR PRIOR TO ISSUANCE OF BUILDING PERMIT.
- 10. SEE APPENDIX "O" OF THE ENGINEERING REPORT FOR OPERATION AND MAINTENANCE PLAN.

PERFORMED 9/30/14, BY P. LAFAYETTE, P.E.

TH-1 0-12 TOPSOIL

12-47" TAN FINE-MED. SAND W/SOME SILT 47-130" MED.-COARSE SAND AND STONES

NO MOTTLING, NO WATER, NO LEDGE

TH=2 0-6" TOPSOIL

TAN FINE-MED. SAND W/SOME SILT 40-128" MED.-COARSE SAND AND STONES NO MOTTLING, NO WATER, NO LEDGE

<u>TH-3</u> 0-4"

4-32" ORANGE FINE SAND W/SOME SILT & STONES 32-125" MED.-COARSE SAND AND STONES

NO MOTTLING, NO WATER, NO LEDGE

TH-2 0-10

10-52" ORANGE FINE SAND W/SOME SILT & STONES 52-136" MED.-COARSE SAND AND STONES

NO MOTTLING, NO WATER, NO LEDGE

EARTHWORK

Cut/Fill Summary

Name	Cut Factor	Fill Factor	2d Area	Cut	Fill	Net
Earthwork	1.000	1.000	66340.66 Sq. Ft.	3325.99 Cu. Yd.	3645.68 Cu. Yd.	319.69 Cu. Yd. <fill></fill>
Totals			66340.66 Sq. Ft.	3325.99 Cu. Yd.	3645.68 Cu. Yd.	319.69 Cu. Yd. <fill></fill>

A. TOTAL AREA OF DISTURBANCE: 66,340 S.F. (1.5 A.C.±)

WET	LAND	AREAS
	_/ \ \ \ \	, ,, , — , ,,

AREA	AREA (S.F.)	AREA (AC.)	NOTES
WETLAND AREA ON SITE	0 S.F.	0 AC.	See note below.
UPLAND REVIEW AREA ON SITE	4,253 S.F.	0.1 AC.	
TOTAL WETLAND AREA DISTURBED	0 S.F.	0 AC.	
UPLAND REVIEW AREA DISTURBED	0 S.F.	0 AC.	
TOTAL WETLAND & UPLAND REVIEW AREA DISTURBED	0 S.F.	0 AC.	
		0 70.	
OFF-SITE WETLANDS FLAGGED BY ALEKSANDRA MOCH ON FEBRUARY 12	, 2022.		



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525 JOHN STREET BRIDGEPORT, CT. 066 Office (203) 333-9465 fax (203) 336-1769 e-mail Info@FullerSurveyors

IT CONDOMINIUM DEVELOPMENT
45 NORWICH-NEW LONDON ROAD (RT 32)
MONTVILLE, CONNECTICUT
PREPARED FOR
WESTERN GROUP, LLC **WILTON'S** UNIT 245 22

Job Number: FE22-1700

Job Start Date: 1/4/22

Γ.		
	Submission	01/25/2
	Staff Comments	03/08/2
	Building Mods/Cond. of Approval	08/10/2
	New Design Update	11/01/22

Drawn By: Checked By

Sheet Title: DRAINAGE **GRATING**

|Scale:

APPROVED BY THE MONTVILLE INLAND WETLAND COMMISSIO


APPROVED BY THE MONTVILLE PLANNING AND ZONING COMMISSION

EXPIRATION DATE

SEC PLAN APPROVAL DATE

Sheet Number:

C-3.

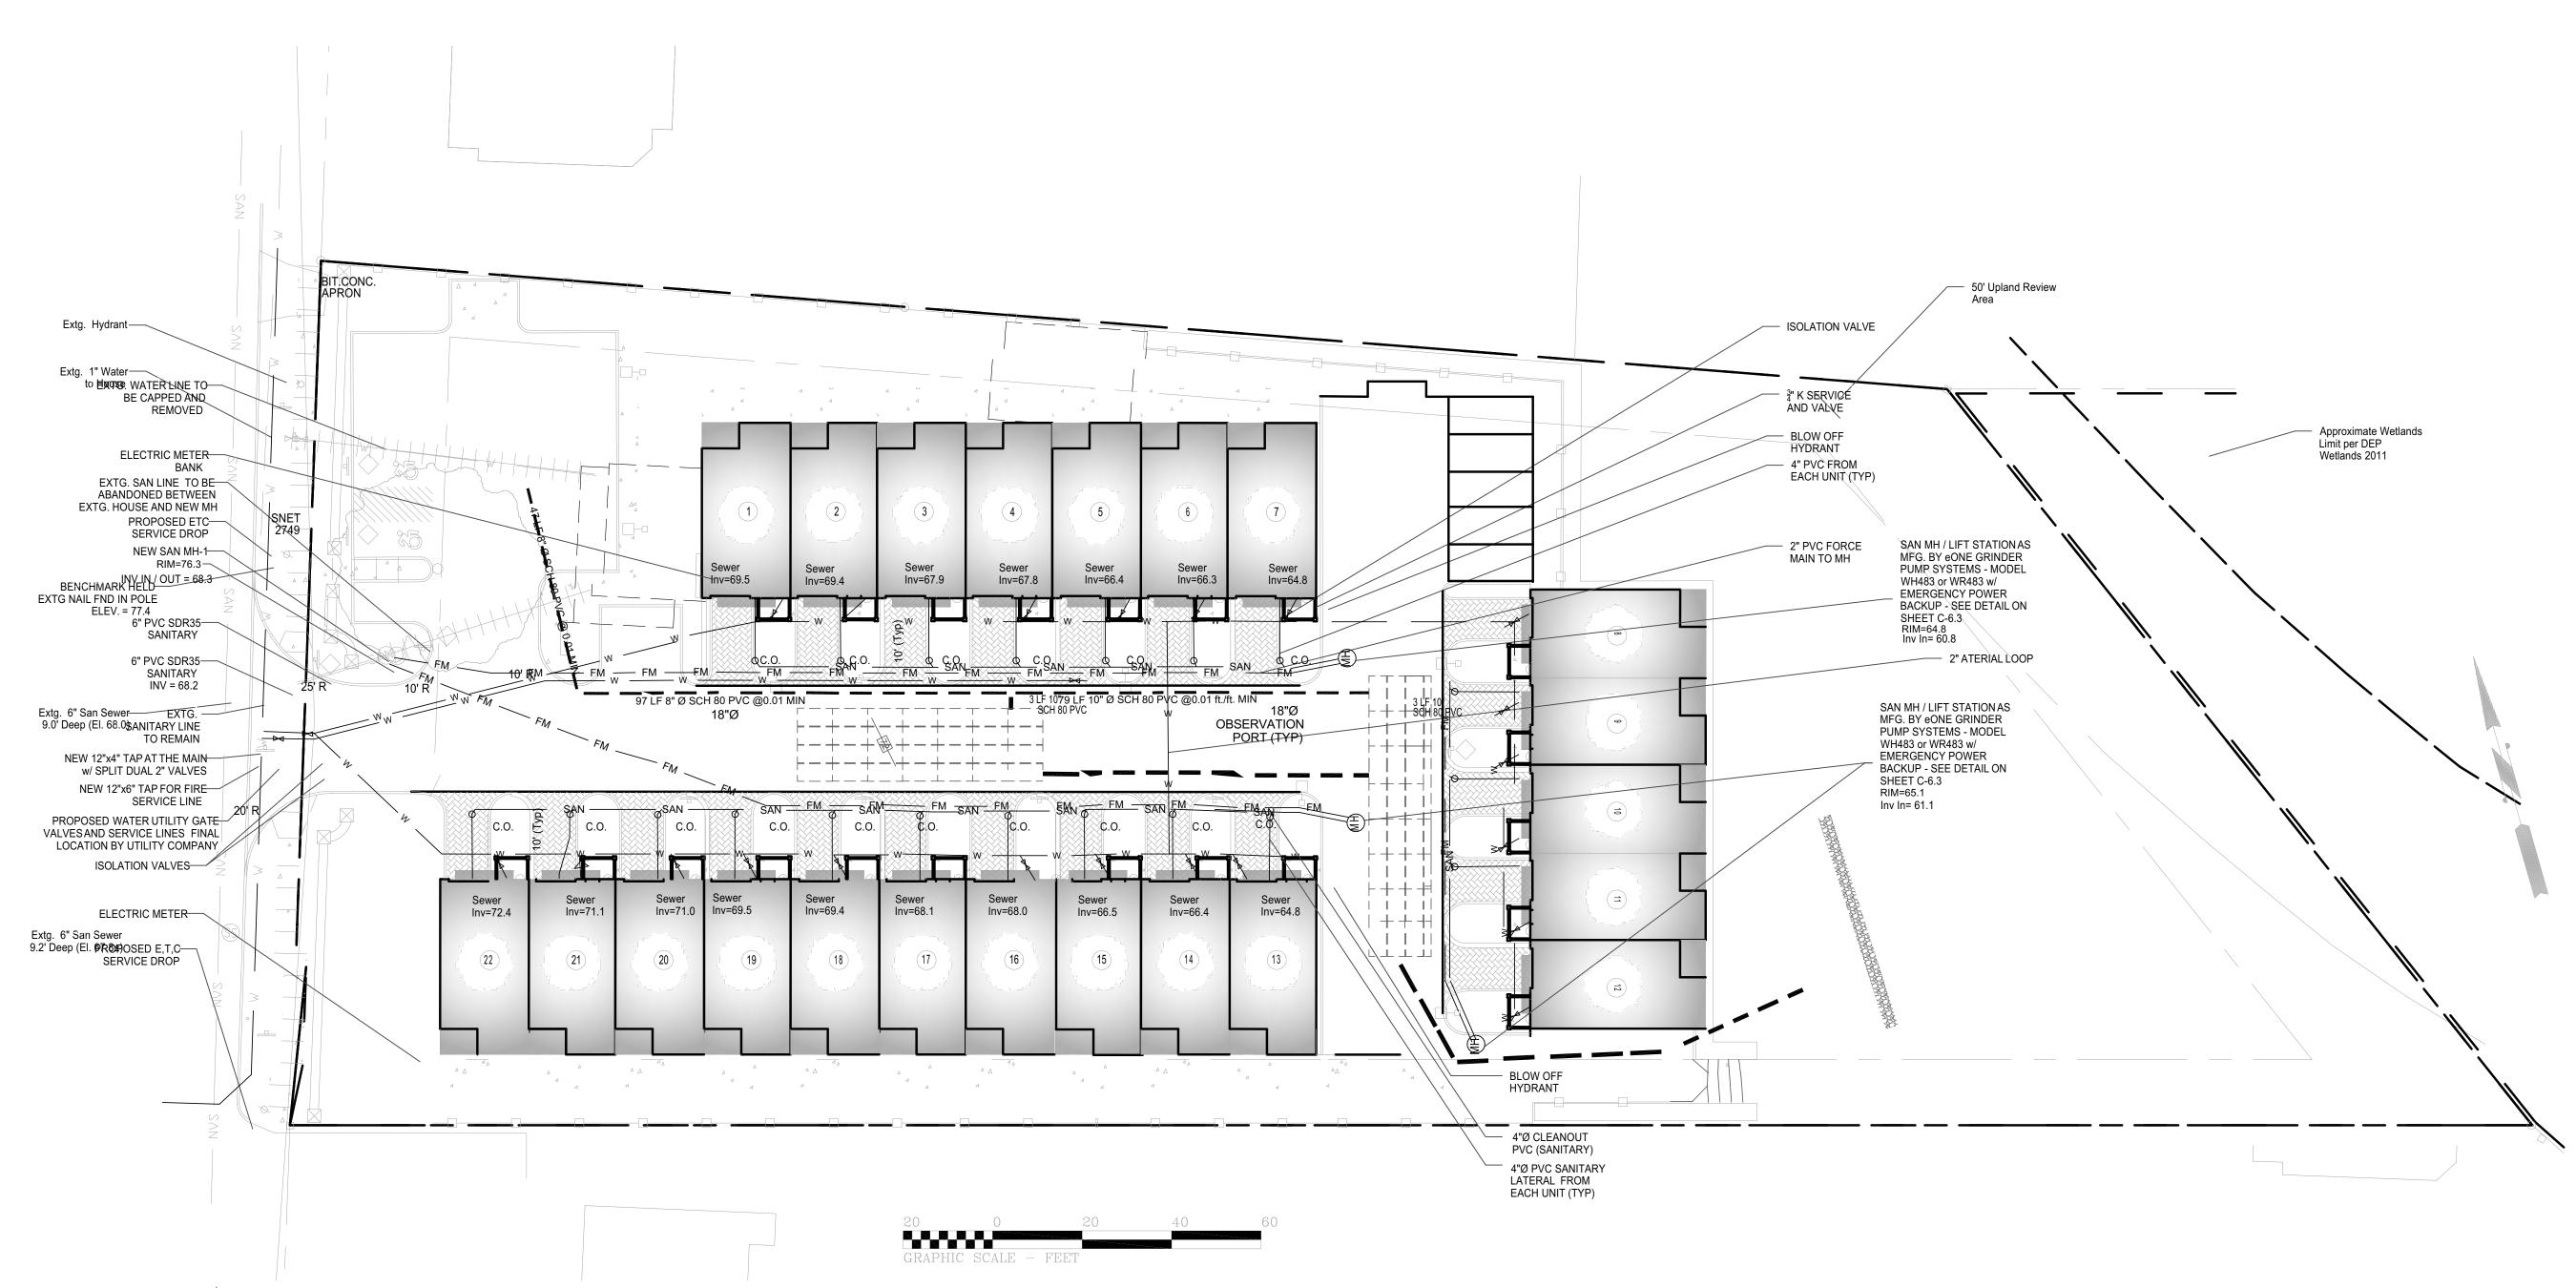

NOTES:

1. THIS PLAN IS FOR THE PROPOSED UTILITIES OF THE PROPOSED RESIDENTIAL DEVELOPMENT WITH PARKING CONSTRUCTION, AND MISCELLANEOUS LANDSCAPING. THIS PLAN IS NOT TO BE USED AS A SITE OR CONSTRUCTION PLAN. ADDITIONAL DESIGN AND DETAILS REQUIRED FOR BIDDING AND CONSTRUCTION.

- 2. THE CONTRACTOR IS SOLELY RESPONSIBLE FOR THE MEANS, METHODS AND SEQUENCES OF CONSTRUCTION AND FOR THE SAFETY OF WORKERS AND OTHERS ON THE CONSTRUCTION SITE.
- 3. THE CONTRACTOR SHALL LOCATE AND VERIFY THE SIZE, LOCATION, DEPTH AND INVERTS OF ANY AND ALL EXISTING UTILITIES PRIOR TO COMMENCING OPERATIONS. THE CONTRACTOR SHALL ALSO BE REQUIRED TO CONTACT THE TOLL FREE "CALL-BEFORE-YOU-DIG" PHONE NUMBER AT 1-800-922-4455.
- 4. THE PROPOSED DEVELOPMENT SHOWN HEREON WILL REQUIRE REVIEW AND APPROVAL BY THE LOCAL BUILDING DEPARTMENT, ZONING DEPARTMENT, AND FIRE MARSHAL'S OFFICE.
- 5. ALL WORK PERFORMED BY THE OWNER / DEVELOPER MUST INCLUDE IMPLEMENTATION OF AN APPROVED SOIL EROSION AND SEDIMENTATION PLAN IN ACCORDANCE THE MINIMUM STANDARDS AS THOSE OUTLINED IN THE "CONNECTICUT GUIDELINES FOR SOIL EROSION AND SEDIMENTATION CONTROL" 2002 EDITION AS AMENDED TO DATE. THOSE METHODS DEEMED MOST EFFECTIVE FOR THIS PROJECT ARE DESCRIBED HEREIN.
- 6. RESTORE ALL DISTURBED AREAS WITH A MINIMUM OF FOUR (4") INCHES OF TOPSOIL, SEED, AND HAY MULCH UPON COMPLETION OF CONSTRUCTION.
- 7. LOT SERVED BY TOWN SEWER SYSTEM AND PUBLIC WATER SUPPLY. APPLICATION WILL BE MADE TO THE WATER POLLUTION CONTROL AUTHORITY FOR A PERMIT TO CONSTRUCT AND CONNECT WATER AND SEWER LINES TO THE MONTVILLE SEWER SYSTEM.
- 8. EXISTING UNDERGROUND UTILITY LOCATION TAKEN FROM MAPS PROVIDED BY UTILITY COMPANY AND SEWER DEPARTMENT, PRIOR SURVEYS, AND FIELD MARKINGS.
- 9. ALL EXISTING UTILITY LINES THAT WILL BE DISCONNECTED MUST BE CAPPED OR TERMINATED ACCORDING TO THE TOWN OF MONTVILLE AND UTILITY COMPANY STANDARDS.
- 10. IF REQUIRED, ALL EXISTING SANITARY SEWER LINES SHALL BE CAPPED WITHIN 2 FEET OF THE EXISTING SEWER
- 11. ALL ROOF LEADERS SHALL BE PIPED AND CONNECTED TO THE SUBSURFACE DRAINAGE SYSTEM. PIPE ROUTING
- AND GUTTER CONNECTIONS SHALL BE DETERMINED BY CONTRACTOR.

 12. ALL UNITS ARE DESIGNED TO HAVE SANITARY CONNECTIONS IN EACH BASEMENT AND WILL PUMP UP TO THE MAIN LATERAL AT THE FRONT OF THE BUILDINGS. SANITARY LIFT SYSTEMS ARE REQUIRED TO FACILITATE ALL
- 13. ALL WORK SHALL COMPLY WITH THE FOLLOWING TOWN STANDARDS:

SEWAGE DISCHARGE TO THE TOWN SEWER SYSTEM IN THE STREET.

- 13.1. TOWN OF MONTVILLE SEWER USE RULES AND REGULATIONS.
- 13.2. TOWN OF MONTVILLE SAWER GOE ROLLS AND REGULATIONS.

 13.1. TOWN OF MONTVILLE SANITARY SEWER MATERIALS AND CONSTRUCTION STANDARDS.
- 13.3. TOWN OF MONTVILLE SPECIFICATIONS OF WATER MAINS AND APPURTENANCES.
- 14. SEWER PIPE TO BE PLASTIC PVC-SDR35.
- 15. WATER LINES TO BE TYPE K COPPER TUBING.

MAP REFERENCES:

SCALE: 1:250

A. "ZONING IMPROVEMENT LOCATION AND TOPOGRAPHIC SURVEY", DATED 7 JANUARY 2022, SCALE 1"=20', BY FULLER ENGINEERING AND LAND SURVEYING, LLC.

Utilities

NO. 14358

NO. 14358

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STONAL

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FULLEN ENGINEENING

LAND SURVEYING

525 JOHN STREET BRIDGEPORT, CT. 066 Office (203) 333-9465 fax (203) 336-1769 e-mail Info@FullerSurveyors

WILTON'S WAY

22 UNIT CONDOMINIUM DEVELOPMENT

245 NORWICH-NEW LONDON ROAD (RT 32)

MONTVILLE, CONNECTICUT

PREPARED FOR

WESTERN GROUP, LLC

Job Number: FE22-1700

Job Start Date: 1/4/22

Submission 01/25/22
Staff Comments 03/08/22
Building Mods/Cond. of Approval 08/10/22
New Design Update 11/01/22

Drawn By: Checked By: D.R.R. J.E.Q.

Sheet Title:

PROPOSED

UTILITIES

PLAN

Scale:

APPROVED BY THE MONTVILLE INLAND WETLAND COMMISSION


APPROVED BY THE MONTVILLE PLANNING AND ZONING COMMISSION

EXPIRATION DATE

SEC PLAN APPROVAL DATE

Sheet Number:

C-3.2

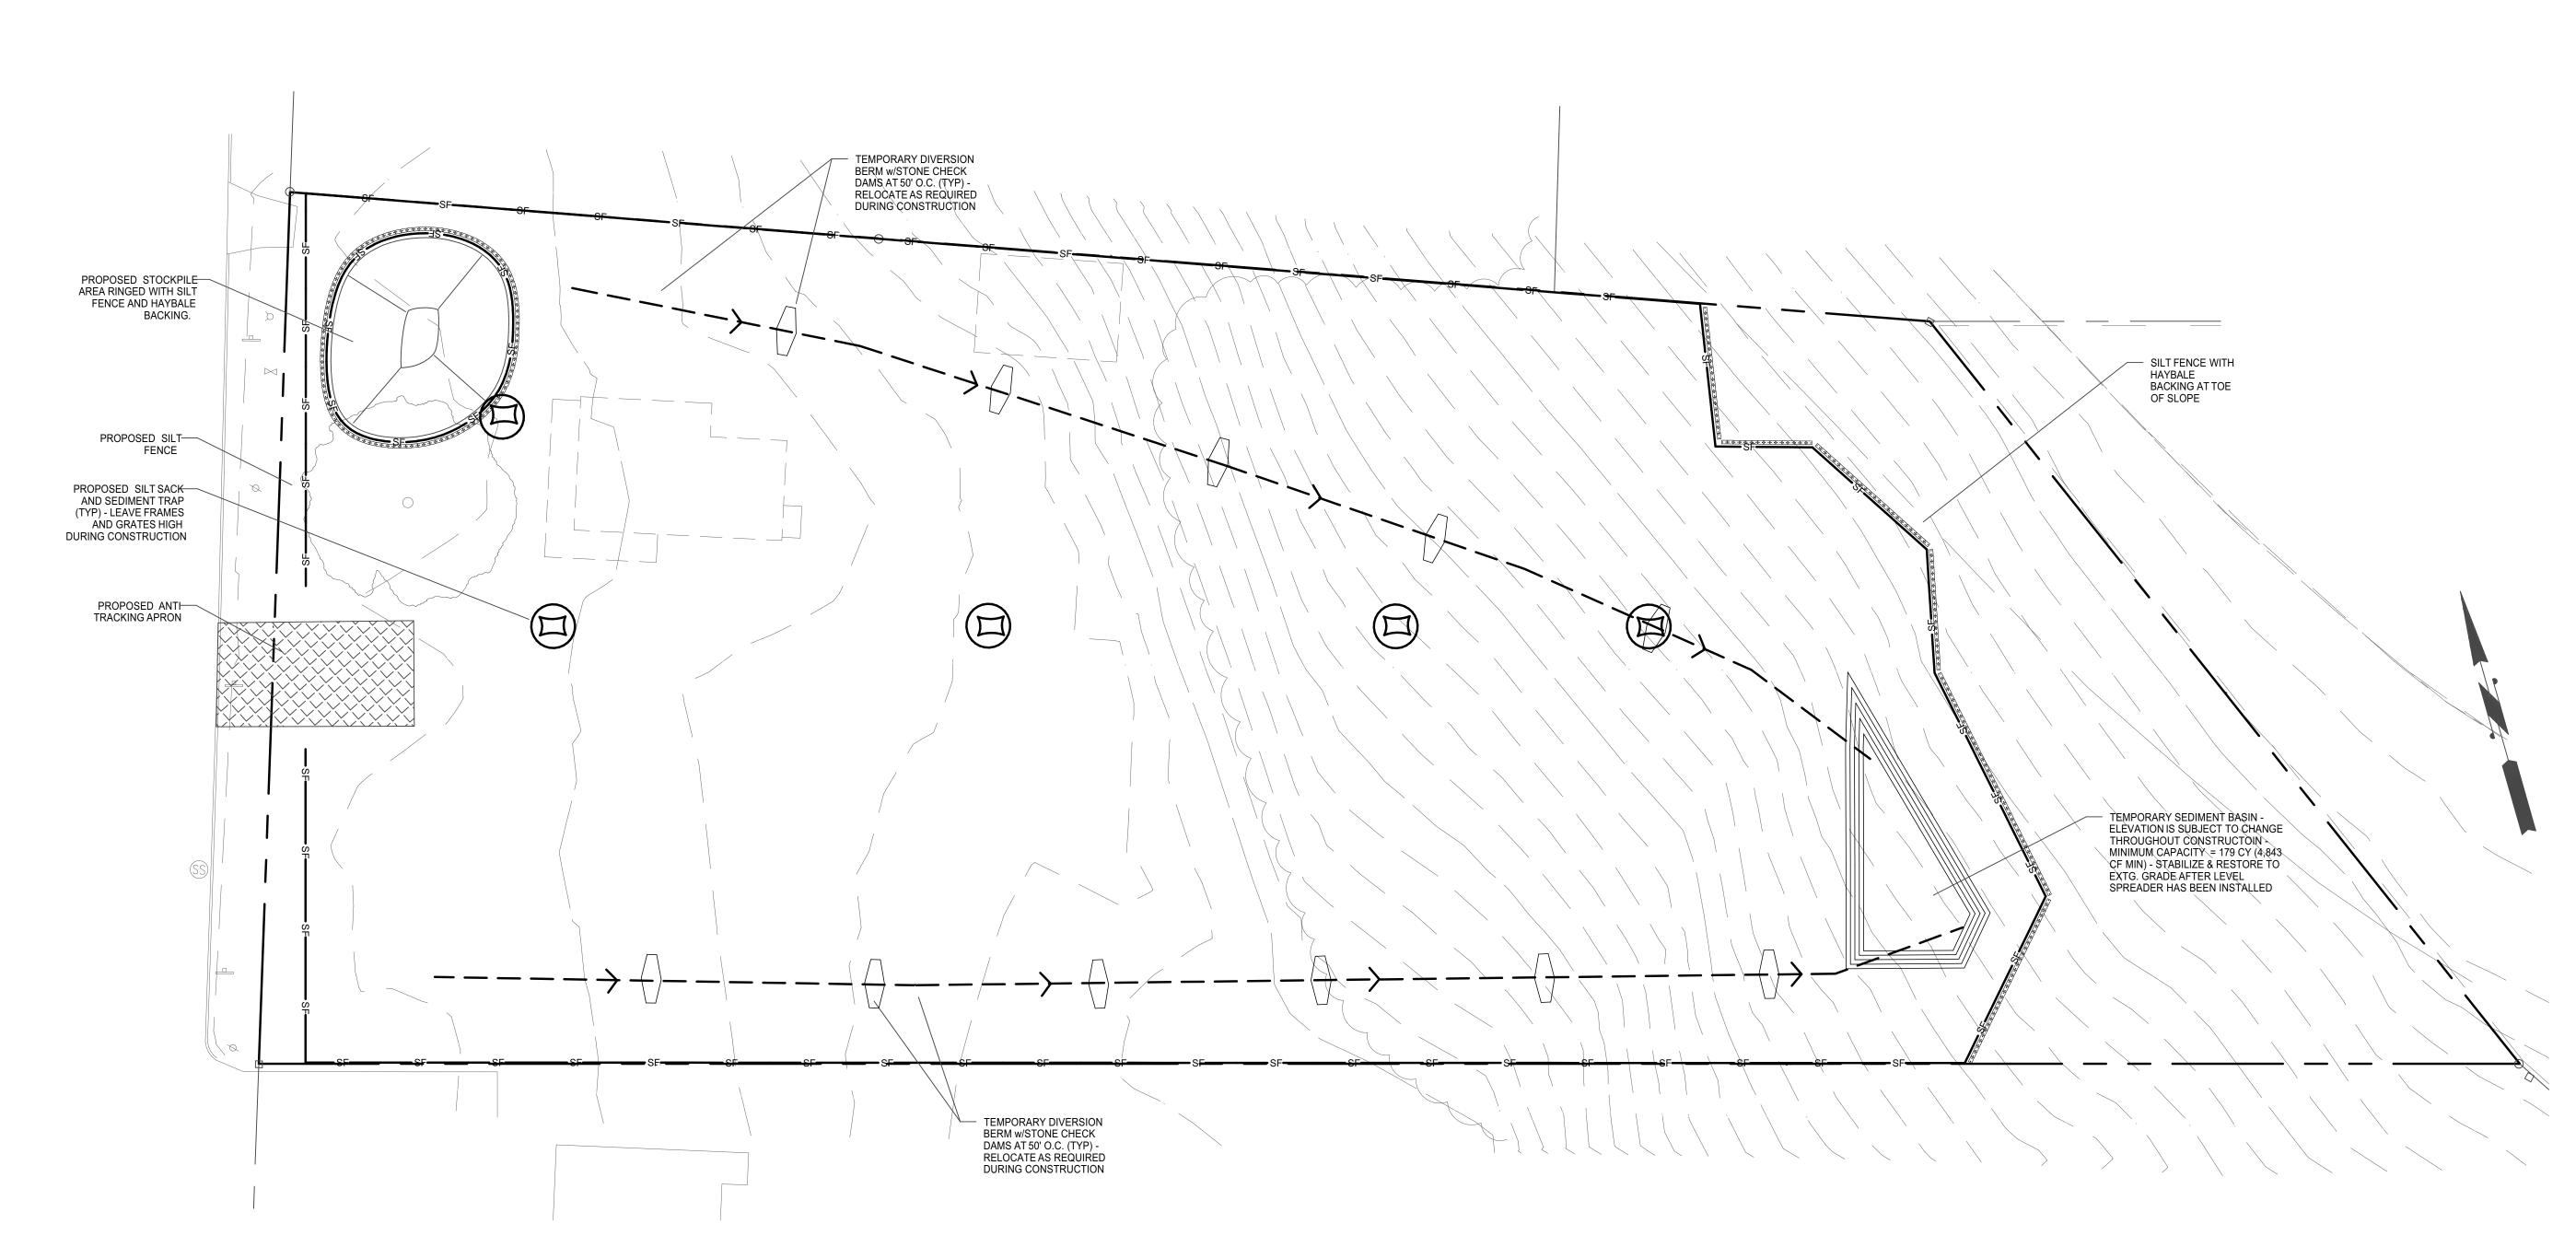

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NOTES

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 REQUIRED FOR BIDDING AND CONSTRUCTION.
- 2. THE CONTRACTOR IS SOLELY RESPONSIBLE FOR THE MEANS, METHODS AND SEQUENCES OF CONSTRUCTION AND FOR THE SAFETY OF WORKERS AND OTHERS ON THE CONSTRUCTION SITE.
- 3. THE PROPOSED DEVELOPMENT SHOWN HEREON HAS BEEN DESIGNED IN ACCORDANCE WITH SECTION 15.1 OF THE ZONING REGULATIONS.
- 4. ALL WORK PERFORMED BY THE OWNER / DEVELOPER MUST INCLUDE IMPLEMENTATION OF AN APPROVED SOIL EROSION AND SEDIMENTATION PLAN IN ACCORDANCE WITH PUBLIC ACT No. 83-388 [PASSED BY THE CONNECTICUT GENERAL ASSEMBLY]. THE OWNER / DEVELOPER SHALL BE THOROUGHLY FAMILIAR WITH THE CONNECTICUT GUIDELINES FOR EROSION 2002 AS AMENDED.
- 5. RESTORE ALL DISTURBED AREAS WITH A MINIMUM OF FOUR (4") INCHES OF TOPSOIL, SEED, AND HAY MULCH UPON COMPLETION OF CONSTRUCTION.
- 6. SEE SHEET C-4.2 FOR EROSION CONTROL NOTES AND DETAILS.
- 7. ANY FUTURE CONSTRUCTION STAGING AREAS (OFFICE TRAILER, LAYDOWN, ETC.) SHALL REQUIRE REVIEW AND APPROVAL BY THE ZONING OFFICIAL OR PLANNING DIRECTOR.

SEDIMENT TRAP CALCULATIONS

NOTE

TEMPORARY SEDIMENT TRAPS HAVE BEEN SIZED TO PROVIDE A MINIMUM STORAGE VOLUME OF 134 CUBIC YARDS PER ACRE OF DRAINAGE ARE PER THE 2002 CONNECTICUT GUIDELINES FOR SOIL EROSION AND SEDIMENT CONTROL

	CONTRIBUTING		CF
SEDIMENT TRAP	AREA	CY Required	Required
1	1.3 AC	179 CY	4,843 CF
TOTAL SEDIMENT			
TRAP STORAGE	4,843 CF		
CAPACITY			



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WILTON'S WAY

22 UNIT CONDOMINIUM DEVELOPMENT

245 NORWICH-NEW LONDON ROAD (RT 32)

MONTVILLE, CONNECTICUT

PREPARED FOR

WESTERN GROUP, LLC

Job Number: FE22-1700

Job Start Date: 1/4/22

Submission	01/25/2
Staff Comments	03/08/2
Building Mods/Cond. of Approval	08/10/2
New Design Update	11/01/2

Drawn By: Checked By: D.R.R. J.E.Q.

Sheet Title:
EROSION
AND
SETTLEMEN
T CONTROL

Scale:

Sheet Number:

APPROVED BY THE MONTVILLE INLAND WETLAND COMMISSION

CHAIRMAN

DATE


APPROVED BY THE MONTVILLE PLANNING AND ZONING COMMISSION

CHAIRMAN

DATE

EXPIRATION DATE

SEC PLAN APPROVAL DATE

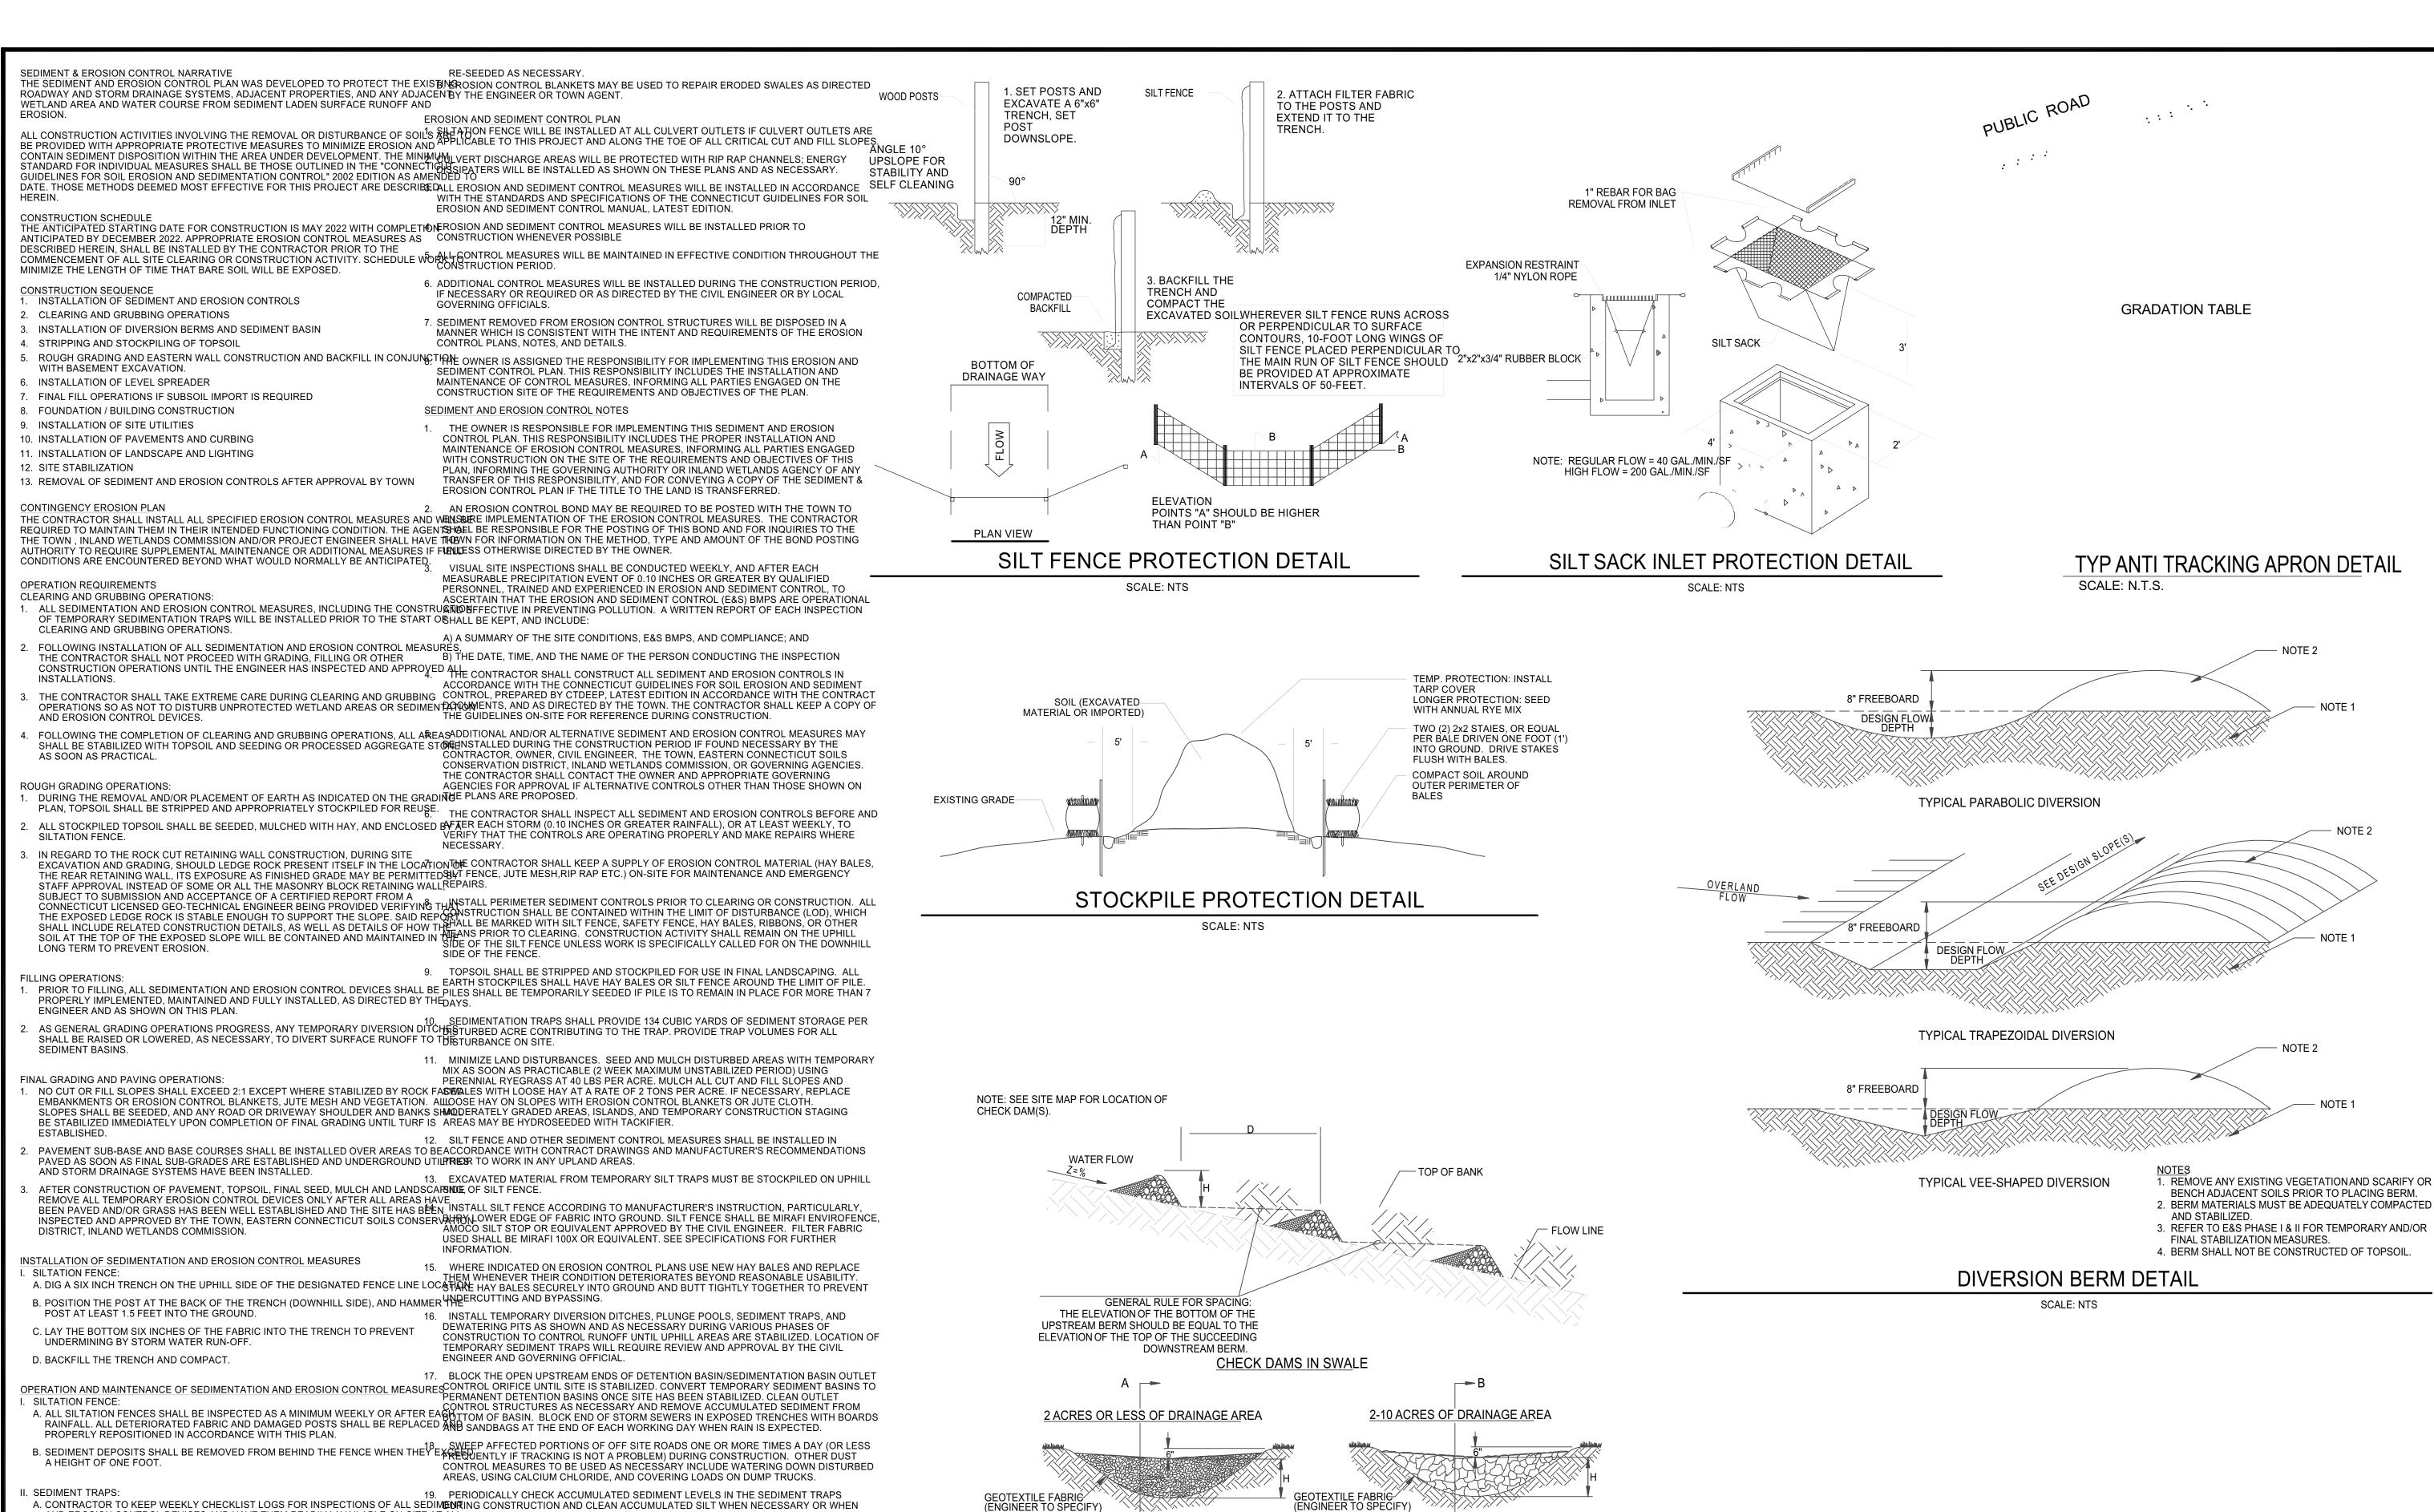

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525 JOHN STREET BRIDGEPORT, CT. 066

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NOTE 2

APPROVED BY THE MONTVILLE INLAND WETLAND COMMISSIO

APPROVED BY THE MONTVILLE PLANNING AND ZONING COMMISSION

EXPIRATION DATE

SEC PLAN APPROVAL DATE

Job Number: FE22-1700

2

Job Start Date:

1/4/22

Staff Comments 03/08/22 Building Mods/Cond. of Approval | 08/10/2 New Design Update

Drawn By: Checked By

Sheet Title: AND SETTLEMEN T CONTROL **DETAILS AND** NOTES

Scale:

Sheet Number:

(ENGINEER TO SPECIFY) AND EROSION CONTROL DEVICES AND HAVE THEM READILY AVAILABLE ON-SITE ATOME FOOT OF SEDIMENT HAS ACCUMULATED OR PER SPECIFIC CLEANOUT MARKER B. ALL SEDIMENT BASINS SHALL BE INSPECTED FOLLOWING EACH RAINFALL. REPAIR GEDIMENT LEGALLY EITHER ON OR OFF SITE.

USED FOLLOWING REPAIR OF SLOPE AS DIRECTED BY THE FRONTED BY THE FRONTE TIMES FOR INSPECTION BY CT DEEP, LOCAL AUTHORITIES OR ENGINEER. ELEVATION. REMOVE ACCUMULATED SEDIMENT FROM BEHIND SILT FENCE WHEN LEVEL (DOWNSTREAM VIEW) (DOWNSTREAM VIEW) USED FOLLOWING REPAIR OF SLOPE AS DIRECTED BY THE ENGINEER. 20. IMMEDIATELY UPON DISCOVERING UNFORESEEN CIRCUMSTANCES POSING THE C. SEDIMENT DEPOSITS SHALL BE REMOVED FROM SEDIMENT BASINS AND/OR SEDIMENT APPROPRIATE BEST MANAGEMENT PRACTICES (BMP) TO ELIMINATE THE TRAPS WHEN THEY EXCEED A HEIGHT OF ONE FOOT UNLESS OTHERWISE INDICATED OPENTIAL FOR ACCELERATED EROSION AND/OR SEDIMENT POLLUTION.

THE EPOSION CONTROL PLANS AND DETAILS TO BE AT A SPECIFIC ELEVATION PER THE EROSION CONTROL PLANS AND DETAILS TO BE AT A SPECIFIC ELEVATION PER 21. ALL EXCAVATED MATERIAL SHALL BE PLACED ON THE HIGH SIDE OF UTILITY AND STORM 2"-3" CLEAN STONE 2"-3" CLEAN STONE D. SEDIMENT SHALL BE DISPOSED OF ON-SITE OR AS DIRECTED BY THE ENGINEER AND THE TRENCHES SO AS TO ALLOW THE TRENCH TO INTERCEPT ALL SILT LADEN RUNOFF. LOCAL GOVERNING OFFICIALS. SEE SEDIMENT AND EROSION CONTROL NOTES DEFENAN AREA SHALL BE CONSIDERED TO HAVE ACHIEVED FINAL STABILIZATION WHEN IT HAS REGARDING DISPOSAL REQUIREMENTS FOR OFF SITE SPOIL DISPOSAL. A MINIMUM OF 70% UNIFORM PERENNIAL VEGETATIVE COVER OR OTHER PERMANENT NON-VEGETATIVE COVER WITH A DENSITY SUFFICIENT TO RESIST ACCELERATED SURFACE EROSION AND SUBSURFACE CHARACTERISTICS SUFFICIENT TO RESIST SLIDING OR OTHER A. ALL STONE CHECK DAMS SHALL BE INSPECTED FOLLOWING EACH RAINFALL. REPAIR OF
STONE CHECK DAMS SHALL BE PROMPTLY MADE AND ACCUMULATED SEDIMEN\$3. MAINTAIN ALL PERMANENT AND TEMPORARY SEDIMENT CONTROL DEVICES IN EFFECTIVE CONDITION THROUGHOUT THE CONSTRUCTION PERIOD. UPON COMPLETION OF WORK **ELEVATION A ELEVATION B** SWEEP PARKING LOT AND REMOVE ALL TEMPORARY SEDIMENT CONTROLS WHEN AUTHORIZED BY LOCAL GOVERNING AUTHORITY. FILE NOT (NOTICE OF TERMINATION) WITH A. SWALES SHALL BE INSPECTED FOLLOWING EACH RAINFALL. REPAIR OF ANY WASHEROM CONSTRUCTION ACTIVITIES PER NPDES.


OUT OR ERODED SLOPES SHALL BE MADE PROMPTLY AND THE AREA SHALL BE STONE CHECK DAM DETAIL SCALE: NTS

I. CHECK DAMS:

REMOVED WHEN IT REACHES ONE HALF OF THE HEIGHT OF THE CHECK DAM.

TEMPORARY/PERMANENT DRAINAGE SWALES:

OUT OR ERODED SLOPES SHALL BE MADE PROMPTLY AND THE AREA SHALL BE

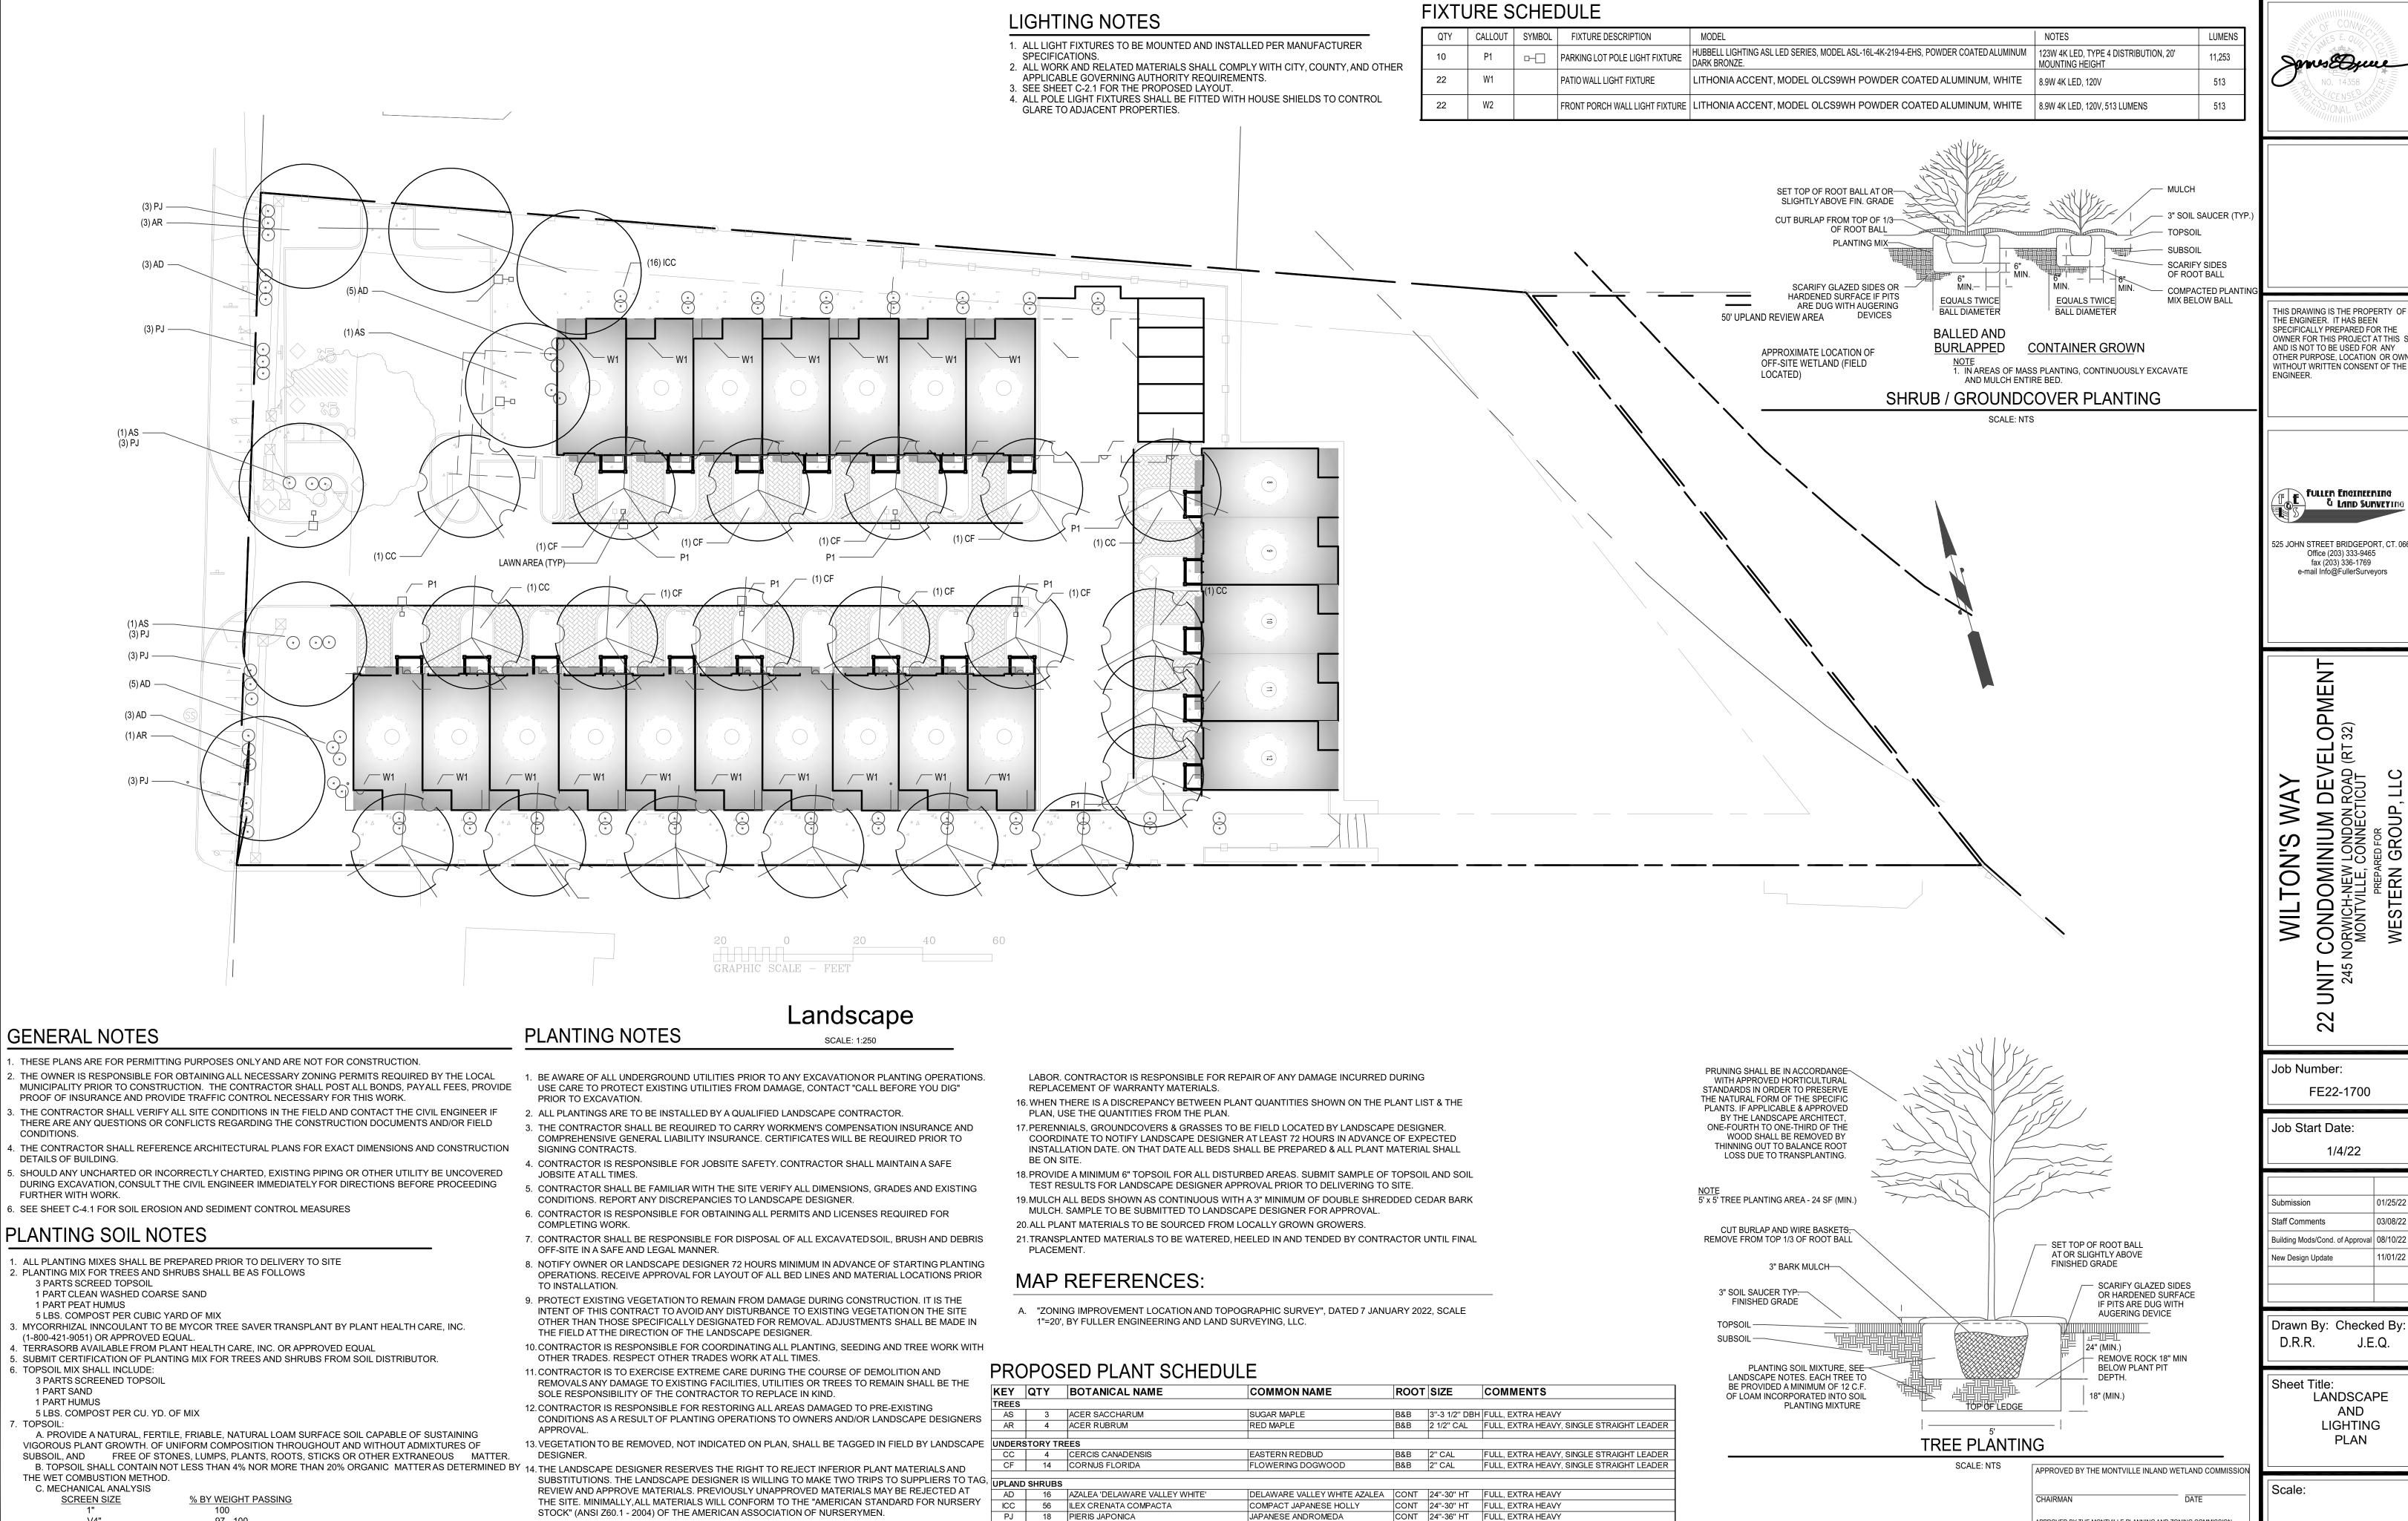

97 - 100

PH, AND MINERAL AND PLANT - NUTRIENT CONTENT OF TOPSOIL.

SOIL AMENDMENTS TO BE ADDED TO PRODUCE A SATISFACTORY TOPSOIL.

CONTRACTORS SHALL BE RESPONSIBLE FOR ALL TESTING AND ANALYSIS OF EXISTING AND IMPORTED

SOILS. FURNISH A SOIL ANALYSIS MADE BY A QUALIFIED INDEPENDENT SOIL - TESTING AGENCY STATING

PERCENTAGES OF ORGANIC MATTER, INORGANIC MATTER (SILT, CLAY, AND SAND), DELETERIOUS MATERIAL

REPORT SUITABILITY OF TOPSOIL FOR LAWN AND SHRUB PLANTING GROWTH. RECOMMEND QUANTITIES

OF NITROGEN, PHOSPHORUS. AND POTASH NUTRIENT AND ANY LIMESTONE, ALUMINUM SULFATE, OR OTHER

NO. 200

15. ALL PLANT MATERIAL SHALL BE GUARANTEED BY THE CONTRACTOR TO BE IN GOOD, HEALTHY AND

CONTRACTOR SHALL REPLACE, AS SOON AS WEATHER AND SEASONAL CONDITIONS PERMIT, ALL

DEAD PLANTS AND ALL PLANTS NOT IN A VIGOROUS, THRIVING CONDITION, AS DETERMINED BY THE NEW ENGLAND CONSERVATION / WILDLIFE MIX

APPLICATION RATE: 1 LB/1,450 S.F.

APPLICATION RATE: 35 LB/ACRE

NEW ENGLAND EROSION CONTROL/RESTORATION MIX

FLOURISHING CONDITION FOR A PERIOD OF ONE YEAR FROM THE DATE OF ACCEPTANCE. THE

LANDSCAPE DESIGNER DURING, AND AT THE END OF THE GUARANTEE PERIOD. WARRANTY

REPLACEMENT WILL BE PROVIDED AT NO COST TO THE OWNER AND INCLUDE MATERIALS AND

APPROVED BY THE MONTVILLE PLANNING AND ZONING COMMISSION

EXPIRATION DATE

SEC PLAN APPROVAL DATE

Sheet Number: