PROJECT TITLE:

New Animal Facility at: **Montville Animal Shelter** 225 Maple Ave. Parcel ID: 077-041-000 Montville, CT



SILVER PETRUCELLI + ASSOCIATES

3190 WHITNEY AVENUE HAMDEN CT 06518311 STATE STREET NEW LONDON CT 06320203 230 9007silverpetrucelli.com

ISSUED FOR BID

09/27/2024

ARCHITECT SILVER PETRUCELLI & ASSOC. 3190 WHITNEY AVENUE, HAMDEN 311 STATE STREET NEW LONDO PHONE 203 230 9007 silverpetru		
M/E/P/FP SILVER PETRUCELLI & ASSOC. 3190 WHITNEY AVENUE, HAMDEN 311 STATE STREET NEW LONDO PHONE 203 230 9007 silverpetru		
STRUCTURAL E2 ENGINEERS 488 MONTAUK AVENUE, NEW LOI 2250 MAIN STREET, CONCORD, M NEW LONDON PHONE 860 437 32 CONCORD PHONE 978 294 8806		
CIVIL DONALD W. SMITH, JR. P.E. 56 GREENWOOD CIRCLE, SEYMO PHONE 203 888 4804		

EN CT 06518 DN, CT 06320 ucelli.com

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ONDON, CT 06320 MA 01742 259 e2engineers.com

10UR, CT 06483

ABBREVIATIONS	S.O.G. SLAB ON GRADE SPEC. SPECIFICATIONS	SYMBOL LEGEND	LIST OF DRAWINGS
DDIACU VIETIONS A.D.L. ADUISTABLE A.L. ADUISTABLE ALLM. ALLMINUM A.B. ARCHOR BOLT APRECOMMETAL APRECOMMETAL A.C.P. ASPERTORS CEMENT PIPE ASPER ASPERTORS CEMENT PIPE ASPERTORS BASEMENT BIRG. BESENDER BIRG. BERNE BIRG. CAST IN PLACE CONCRETE C.B. CONT. CONT. CONTINUOUS.CONTINUE CONT. CONTINUOUS.CONTINUE CONT. CONTINUOUS	SPEC. SPECIFICATIONS SQ.FT. SQUARE FEET SQ.FT. SQUARE FEET SQ.FT. STEPPOPTING STEPPOPTING STEPPOPTING STEPPOPTING STEPPOPTING STEPPOPTING STEPPOPTING STEPPOPTING TECHNOLOGY TECHNOLOGY TECHNOLOGY TO POPTING TO	Image: Construction number Image: Constructinton number	LIST OF DRAWINGUS VOLUME 1 GOO DRAWING UST GOO DRAWING UST GOO DRAWING UST GOO DRAWING UST GOO STEP PLAN GOO STEP PLAN GOO STEP PLAN GOO STEP PLAN GOO DETAILS SOO STEP CONDITIONS & DEMC GOO STEP CONTRAL DETAILS SOO STRUCTURAL NOTES SOO STRUCTURAL DETAILS SOO PANTIANA AOO PARTINON TOPPE, DOOR SOR AOO PARTINON PULMBING COVINGS SECTIONS AOO PARTINON PULMBING COVINGS SECTIONS AOO PARTINON TOPPE, DOOR SOR AOO PARTINON PULMBING COVINGS SECTIONS AOO PLANBING COVINGS SECTIONS AND PLUMBING COVINGS SECTIONS AND
Project Title: NEW ANIMAL FACILTY AT: MONTVILLE ANIMAL SHELTER 225 Maple Ave. Parcel ID: 077-041-00 Montville, CT	ARCHITECT TO REQUEST MISSING INFORMAT AND STEEL SUBCONTRACTOR SHALL REVIEW DRAWINGS PRIOR TO BIDDING. 11. ALL CONTRACTORS SHALL REVIEW DRAWING DISCREPANCY BETWEEN THE TWO OR ANY O VALUE (IN DOLLARS) SHALL PREVAIL AS THE OTHERWISE DIRECTED IN WRITING BY THE A	TION. THESE ITEMS SHALL BE PART OF THE BASE BID W STRUCTURAL AS WELL AS ARCHITECTURAL GS AND PROJECT MANUAL. IF THERE IS A DTHER PARTS OF THE DOCUMENTS, THE HIGHER SCOPE OF WORK THAT WILL BE PRICED UNLESS	

	SYMBOL LEGEND		F DRAWINGS				
	- DOOR NUMBER	VOLUN	I <u>E 1</u>				
SION	? - WINDOW TYPE ? - ROOM NAME		GENERAL DRAWINGS				
	- ROOM NUMBER	G000 G001 G V1	DRAWING LIST BUILDING CODE PLANS & INFORMATION COVER SHEET				
	- PARTITION TYPE - CONSTRUCTION NOTE		CIVIL DRAWINGS				
	- GLAZING TYPE	C100 C200	SITE PLAN EXISTING CONDITIONS & DEMOLITON PLAN				
NOTED	2 - EXTERIOR ELEVATION NUMBER	C300 C400	GRADING, EROSION CONTROL & UTILITY PLAN DETAILS				
	(A101) - SHEET NUMBER	5000	STRUCTURAL DRAWINGS				
E	2 - INTERIOR ELEVATION NUMBER	S000 S001 S002	ISOMETRIC VIEWS STRUCTURAL NOTES STRUCTURAL NOTES				
;	A101 - SHEET NUMBER	S100 S101 S200	FOUNDATION PLAN ROOF FRAMING PLAN STRUCTURAL SECTIONS				
		S200 S300 S301	STRUCTURAL DETAILS STRUCTURAL DETAILS				
	2 - BUILDING SECTION NUMBER - SHEET NUMBER		ARCHITECTURAL DRAWINGS				
	- WALL SECTION NUMBER - SHEET NUMBER	A110 A120	FLOOR PLANS ATTIC PLAN				
		A130 A210 A300	ROOF PLAN REFLECTED CEILING PLAN EXTERIOR ELEVATIONS				
	- REFERENCE POINT	A400 A420 A500	BUILDING SECTIONS WALL SECTIONS SECTION DETAILS				
	X - REVISION MARK	A510 A600	ROOF DETAILS WINDOW ELEVATIONS & DETAILS				
		A700 A900 A910	ENLARGED TOILET PLANS AND INTERIOR ELEVATIONS PARTITION TYPES, DOOR SCHEDULE & DETAILS SIGNAGE DETAILS, FINISH SCHEDULE & CASEWORK DETAILS				
			PLUMBING DRAWINGS				
		P000 P110	PLUMBING COVER SHEET PLUMBING DRAINAGE FLOOR PLAN				
)		P111 P120 P200	PLUMBING SUPPLY FLOOR PLAN PLUMBING ATTIC PLAN PLUMBING RISER DIAGRAMS				
	- NEW SINGLE DOOR	P200 P300 P301	PLUMBING DETAILS PLUMBING DETAILS PLUMBING DETAILS				
		P400	PLUMBING SCHEDULES MECHANICAL DRAWINGS				
SONRY UNITS		M000 M101	NOTES, LEGEND AND ABBREVIATIONS MAIN LEVEL PLAN				
	- NEW DOUBLE DOOR	M101 M102 M103	ATTIC PLAN ROOF PLAN				
		M401 M601 M701	SECTIONS ISOMETRIC VIEWS SCHEMATIC FLOW DIAGRAM AND VRF DIAGRAM				
	- EXISTING DOOR TO REMAIN	M701 M801 M901	MECHANICAL SCHEDULE				
			ELECTRICAL DRAWINGS				
GRAVEL	〒	E001 E100 E101	ELECTRICAL GENERAL NOTES AND LEGEND ELECTRICAL MAIN LEVEL LIGHTING PLAN				
	II \ - REMOVE EXISTING DOOR II \ U I	E101 E200 E201	ELECTRICAL ATTIC LIGHTING PLAN ELECTRICAL MAIN LEVEL POWER PLAN ELECTRICAL ATTIC POWER PLAN				
		E500 E600	ELECTRICAL SCHEDULES ELECTRICAL RISER DIAGRAM				
		E601 E602 ES100	ELECTRICAL DETAILS ELECTRICAL LIGHTING DETAILS ELECTRICAL SITE PLAN				
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VERIFY ALL EXISTING	G CONDITIONS & DIMENSIONS PRIOR TO						
AND INSTALLATION C	TO BE PROVIDED BY CONTRACTOR UNLESS						
QUIPMENT LOCATION	IS ARE APPROXIMATE - CONTRACTOR SHALL						
RDINATE EXACT LOC	ATIONS. URING CONSTRUCTION TO PROTECT MATERIALS						
IAL COST TO THE OW							
ATED ON THE DOOR S							
	ALL HAVE TACTILE WARNING. ALL HAVE PANIC EXIT DEVICES.						
E DOOR HARDWARE S E CODES.	SHALL BE PROVIDED TO COMPLY WITH ADA, ANSI						
DECKING, BEAMS, CO	OLUMNS, JOISTS AND OTHER STRUCTURAL ERWISE NOTED.						
F MEMBER(S) IS NOT	INGS READING - "SEE STRUCTURAL DRAWINGS" - FOUND, THE CONTRACTOR SHALL CONTACT THE N. THESE ITEMS SHALL BE PART OF THE BASE BID						
	RUCTURAL AS WELL AS ARCHITECTURAL						
HE TWO OR ANY OTH PREVAIL AS THE SCO	AND PROJECT MANUAL. IF THERE IS A ER PARTS OF THE DOCUMENTS, THE HIGHER OPE OF WORK THAT WILL BE PRICED UNLESS						
RITING BY THE ARCH	HITECT DURING THE BIDDING PERIOD.						
					vision: Description:	Date: Revised By:	
			SILVER PETRUCEI	$LI + ASSUCIATES _$	ISSUED FOR BID	09/27/2024	



 3190 WHITNEY AVENUE HAMDEN CT 06518

 311 STATE STREET NEW LONDON CT 06320

 203 230 9007

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Date: Revised By: 09/27/2024		Drawing Title: DRAWING LIST	Date: 09/27/202 Scale:
			<u>12" = 1</u> Drawn By: MES
			Project Nur 22.130

9/27/2024

<u>12" = 1'-0"</u> Drawn By: MES Project Number: Drawing Number:

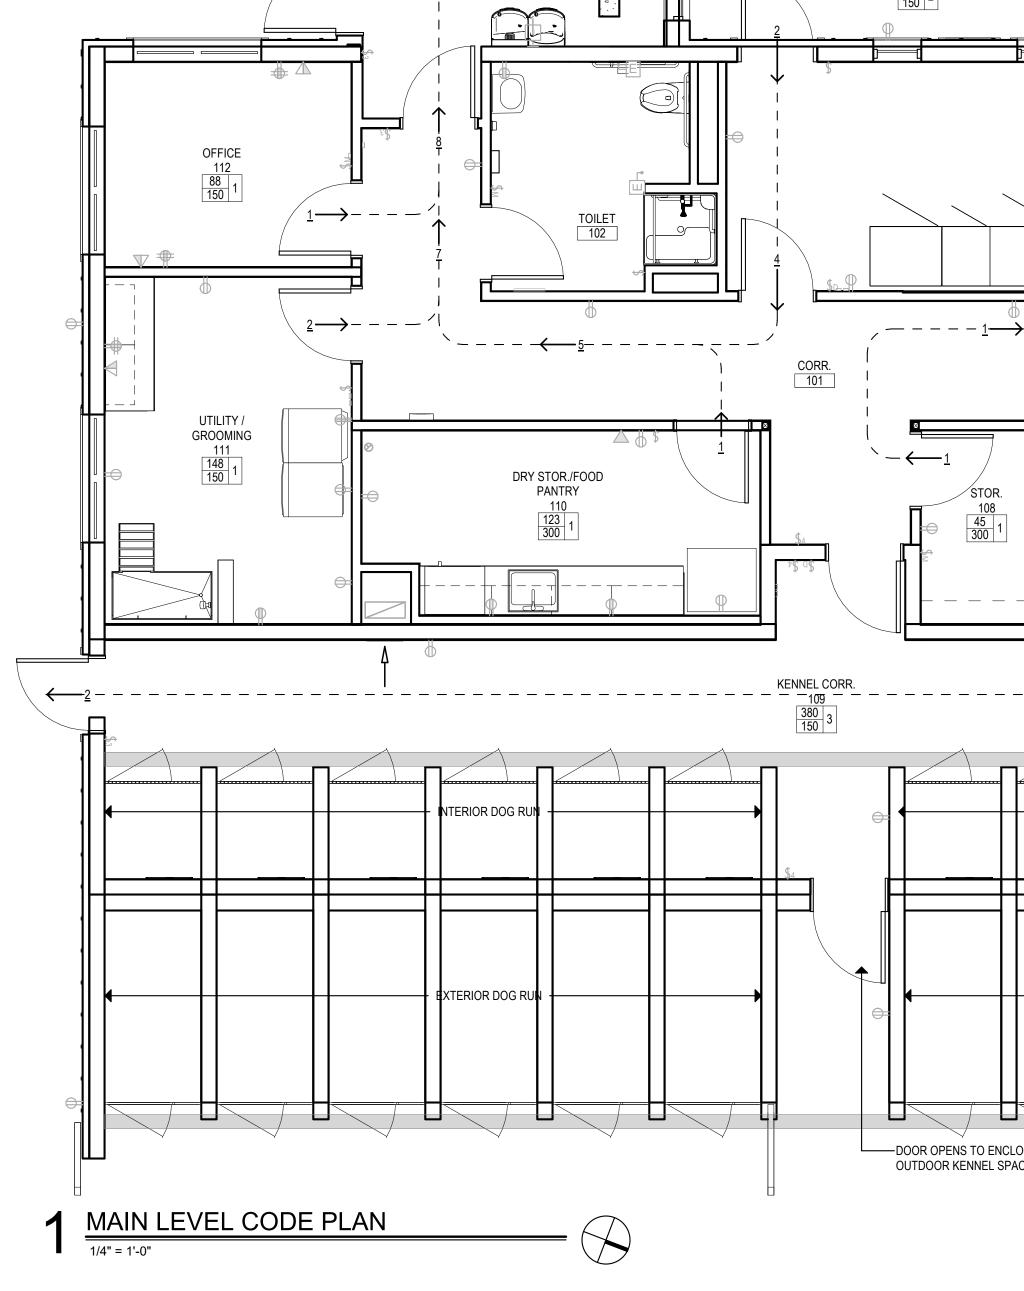




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Revision: Description: ISSUED FOR BID

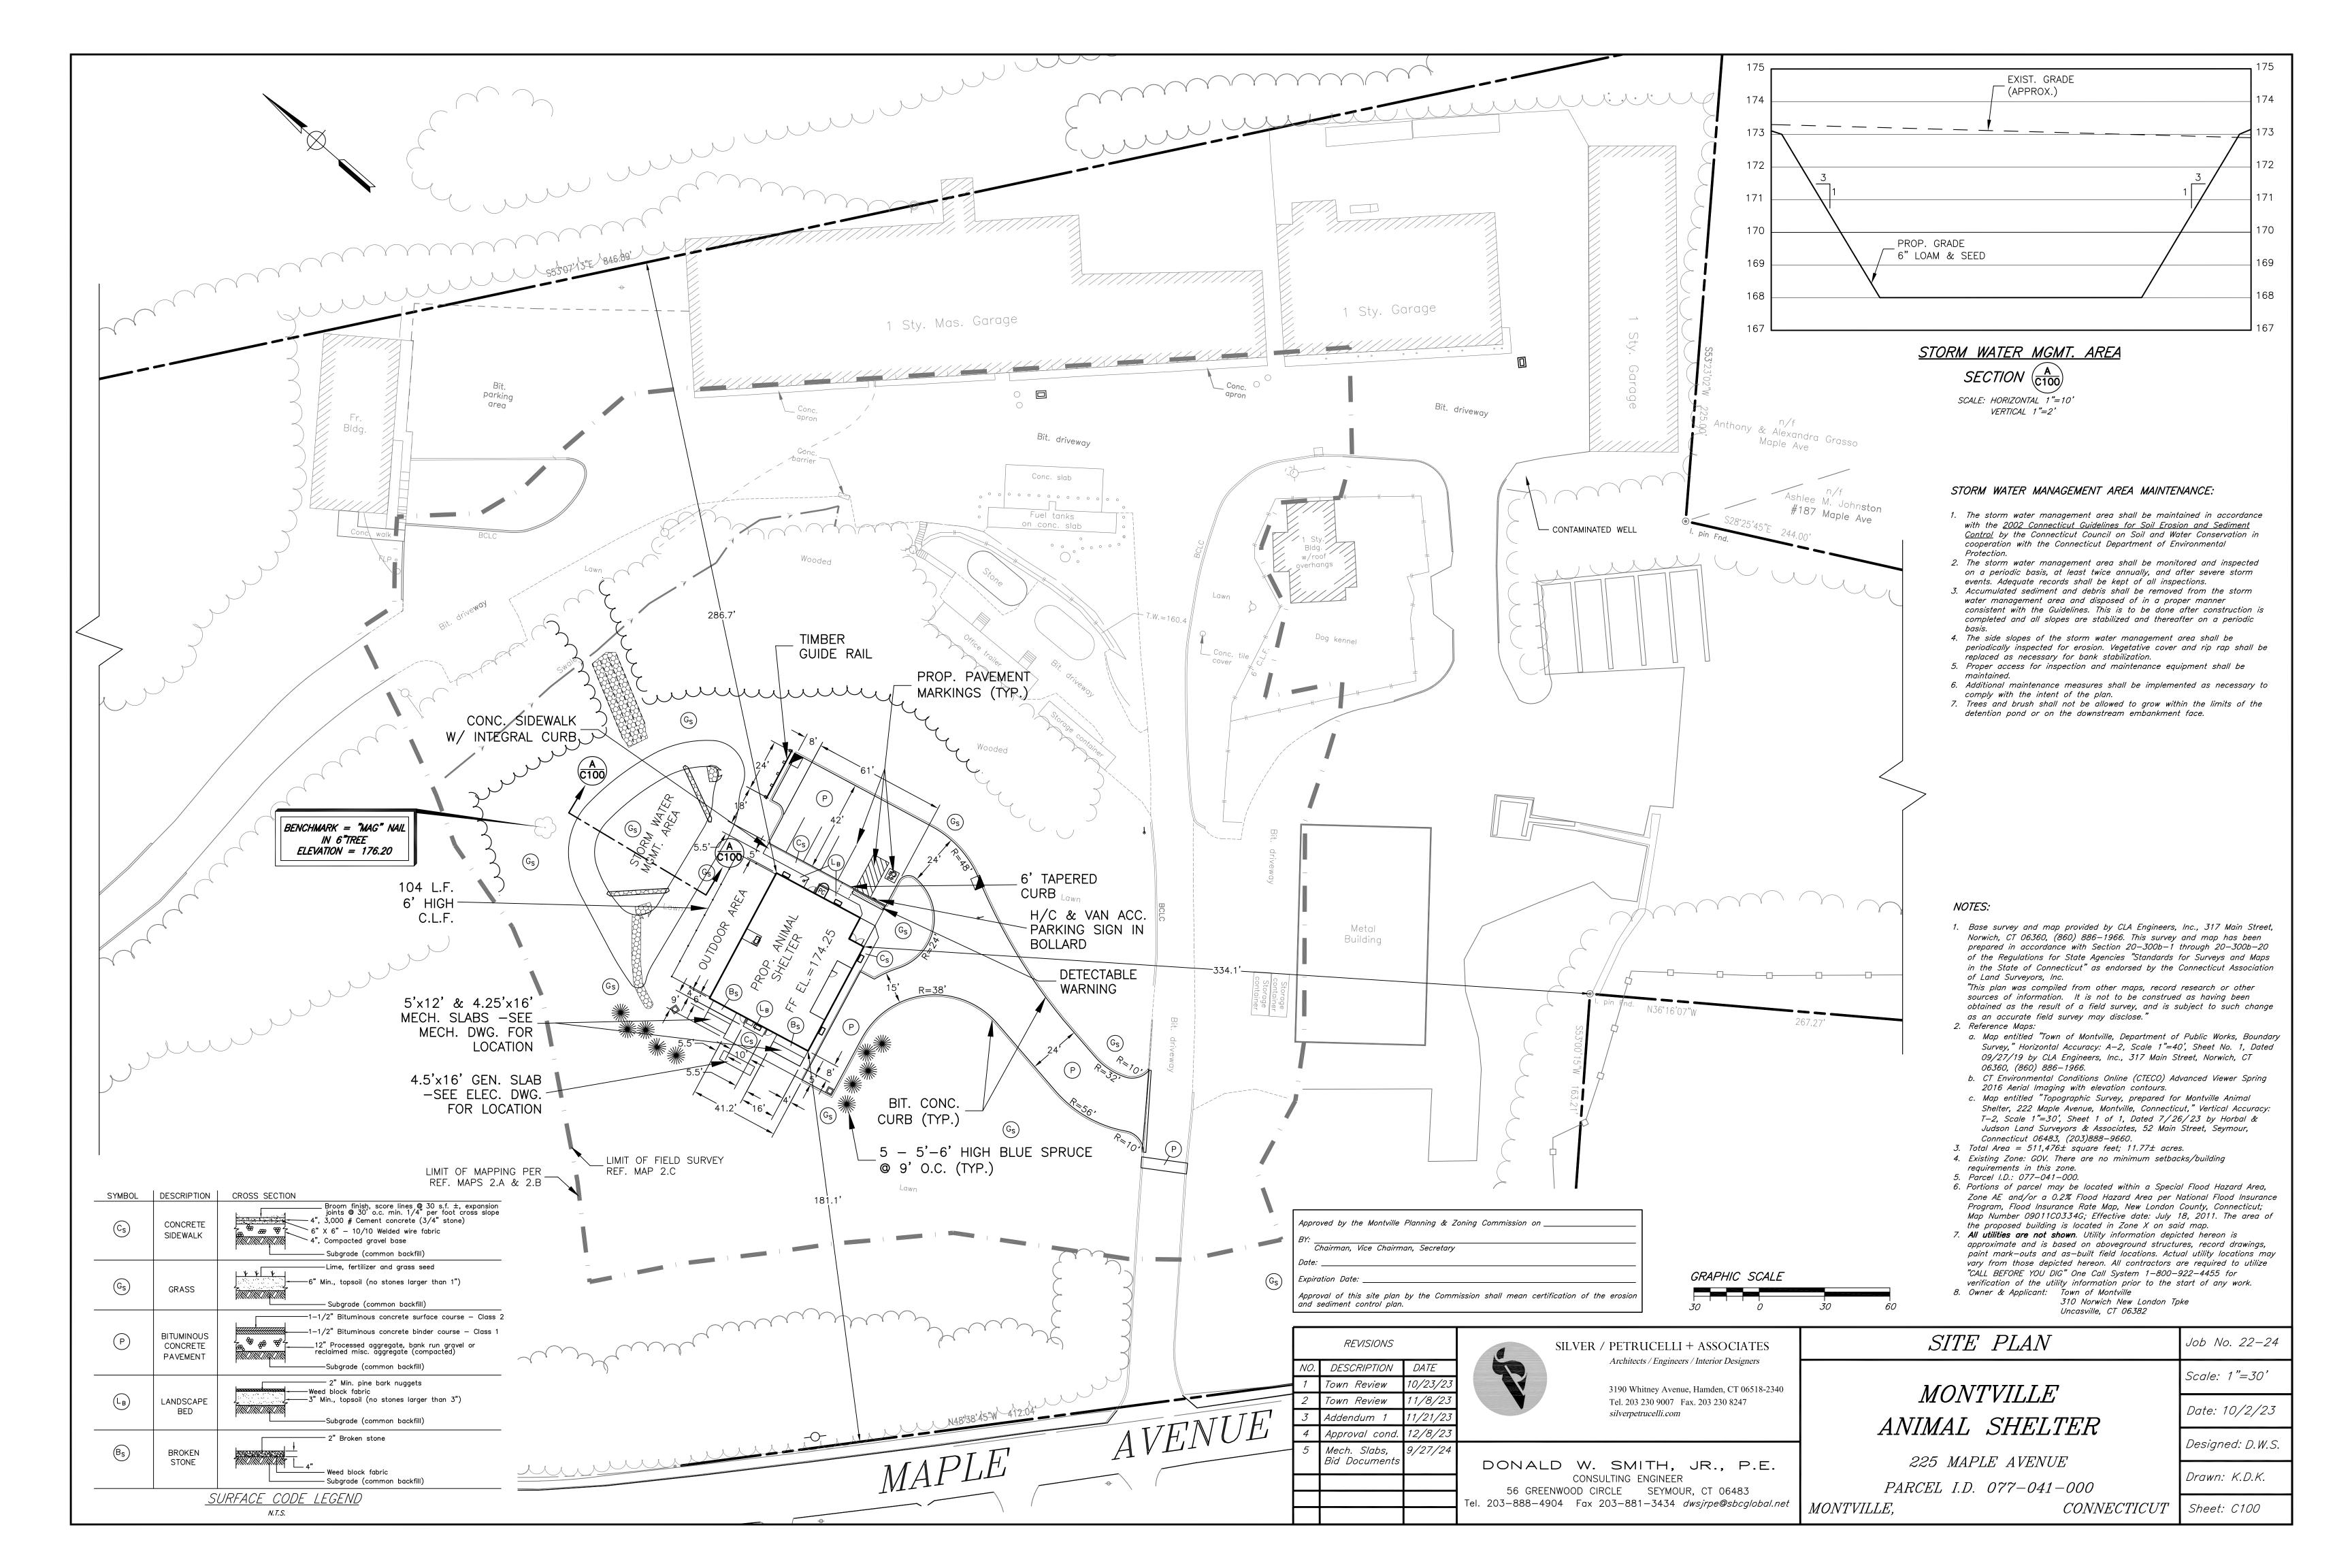
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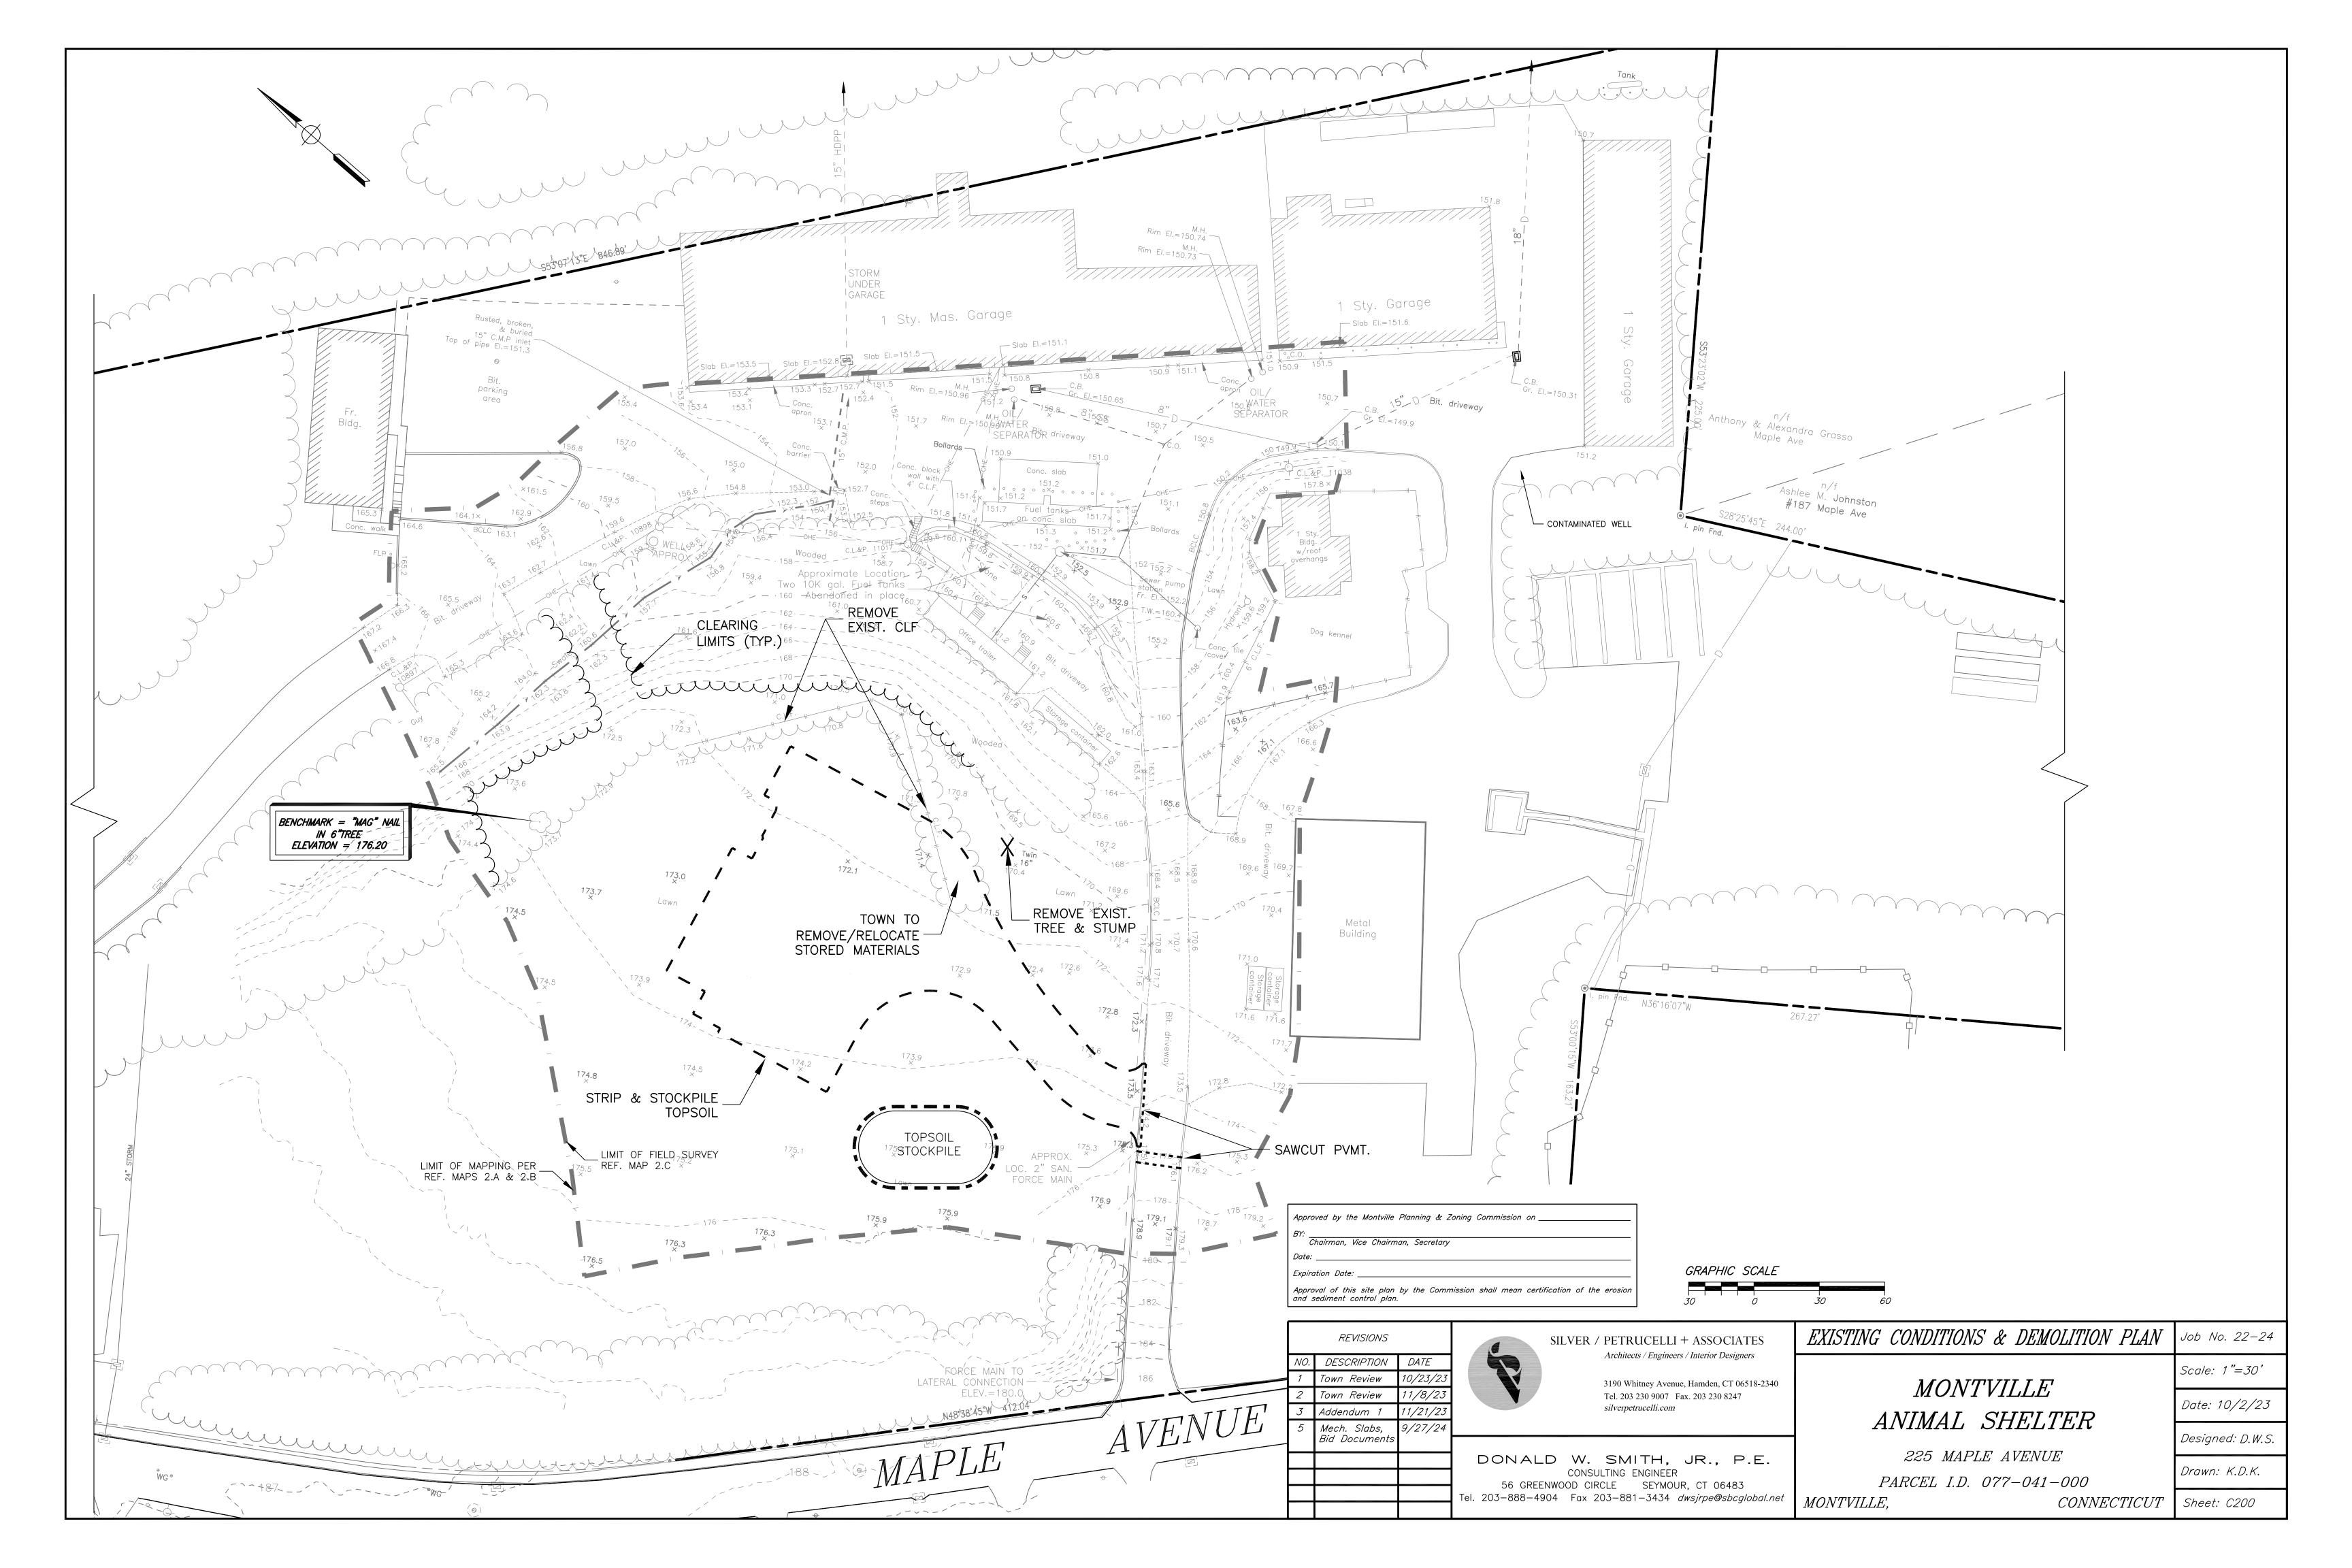


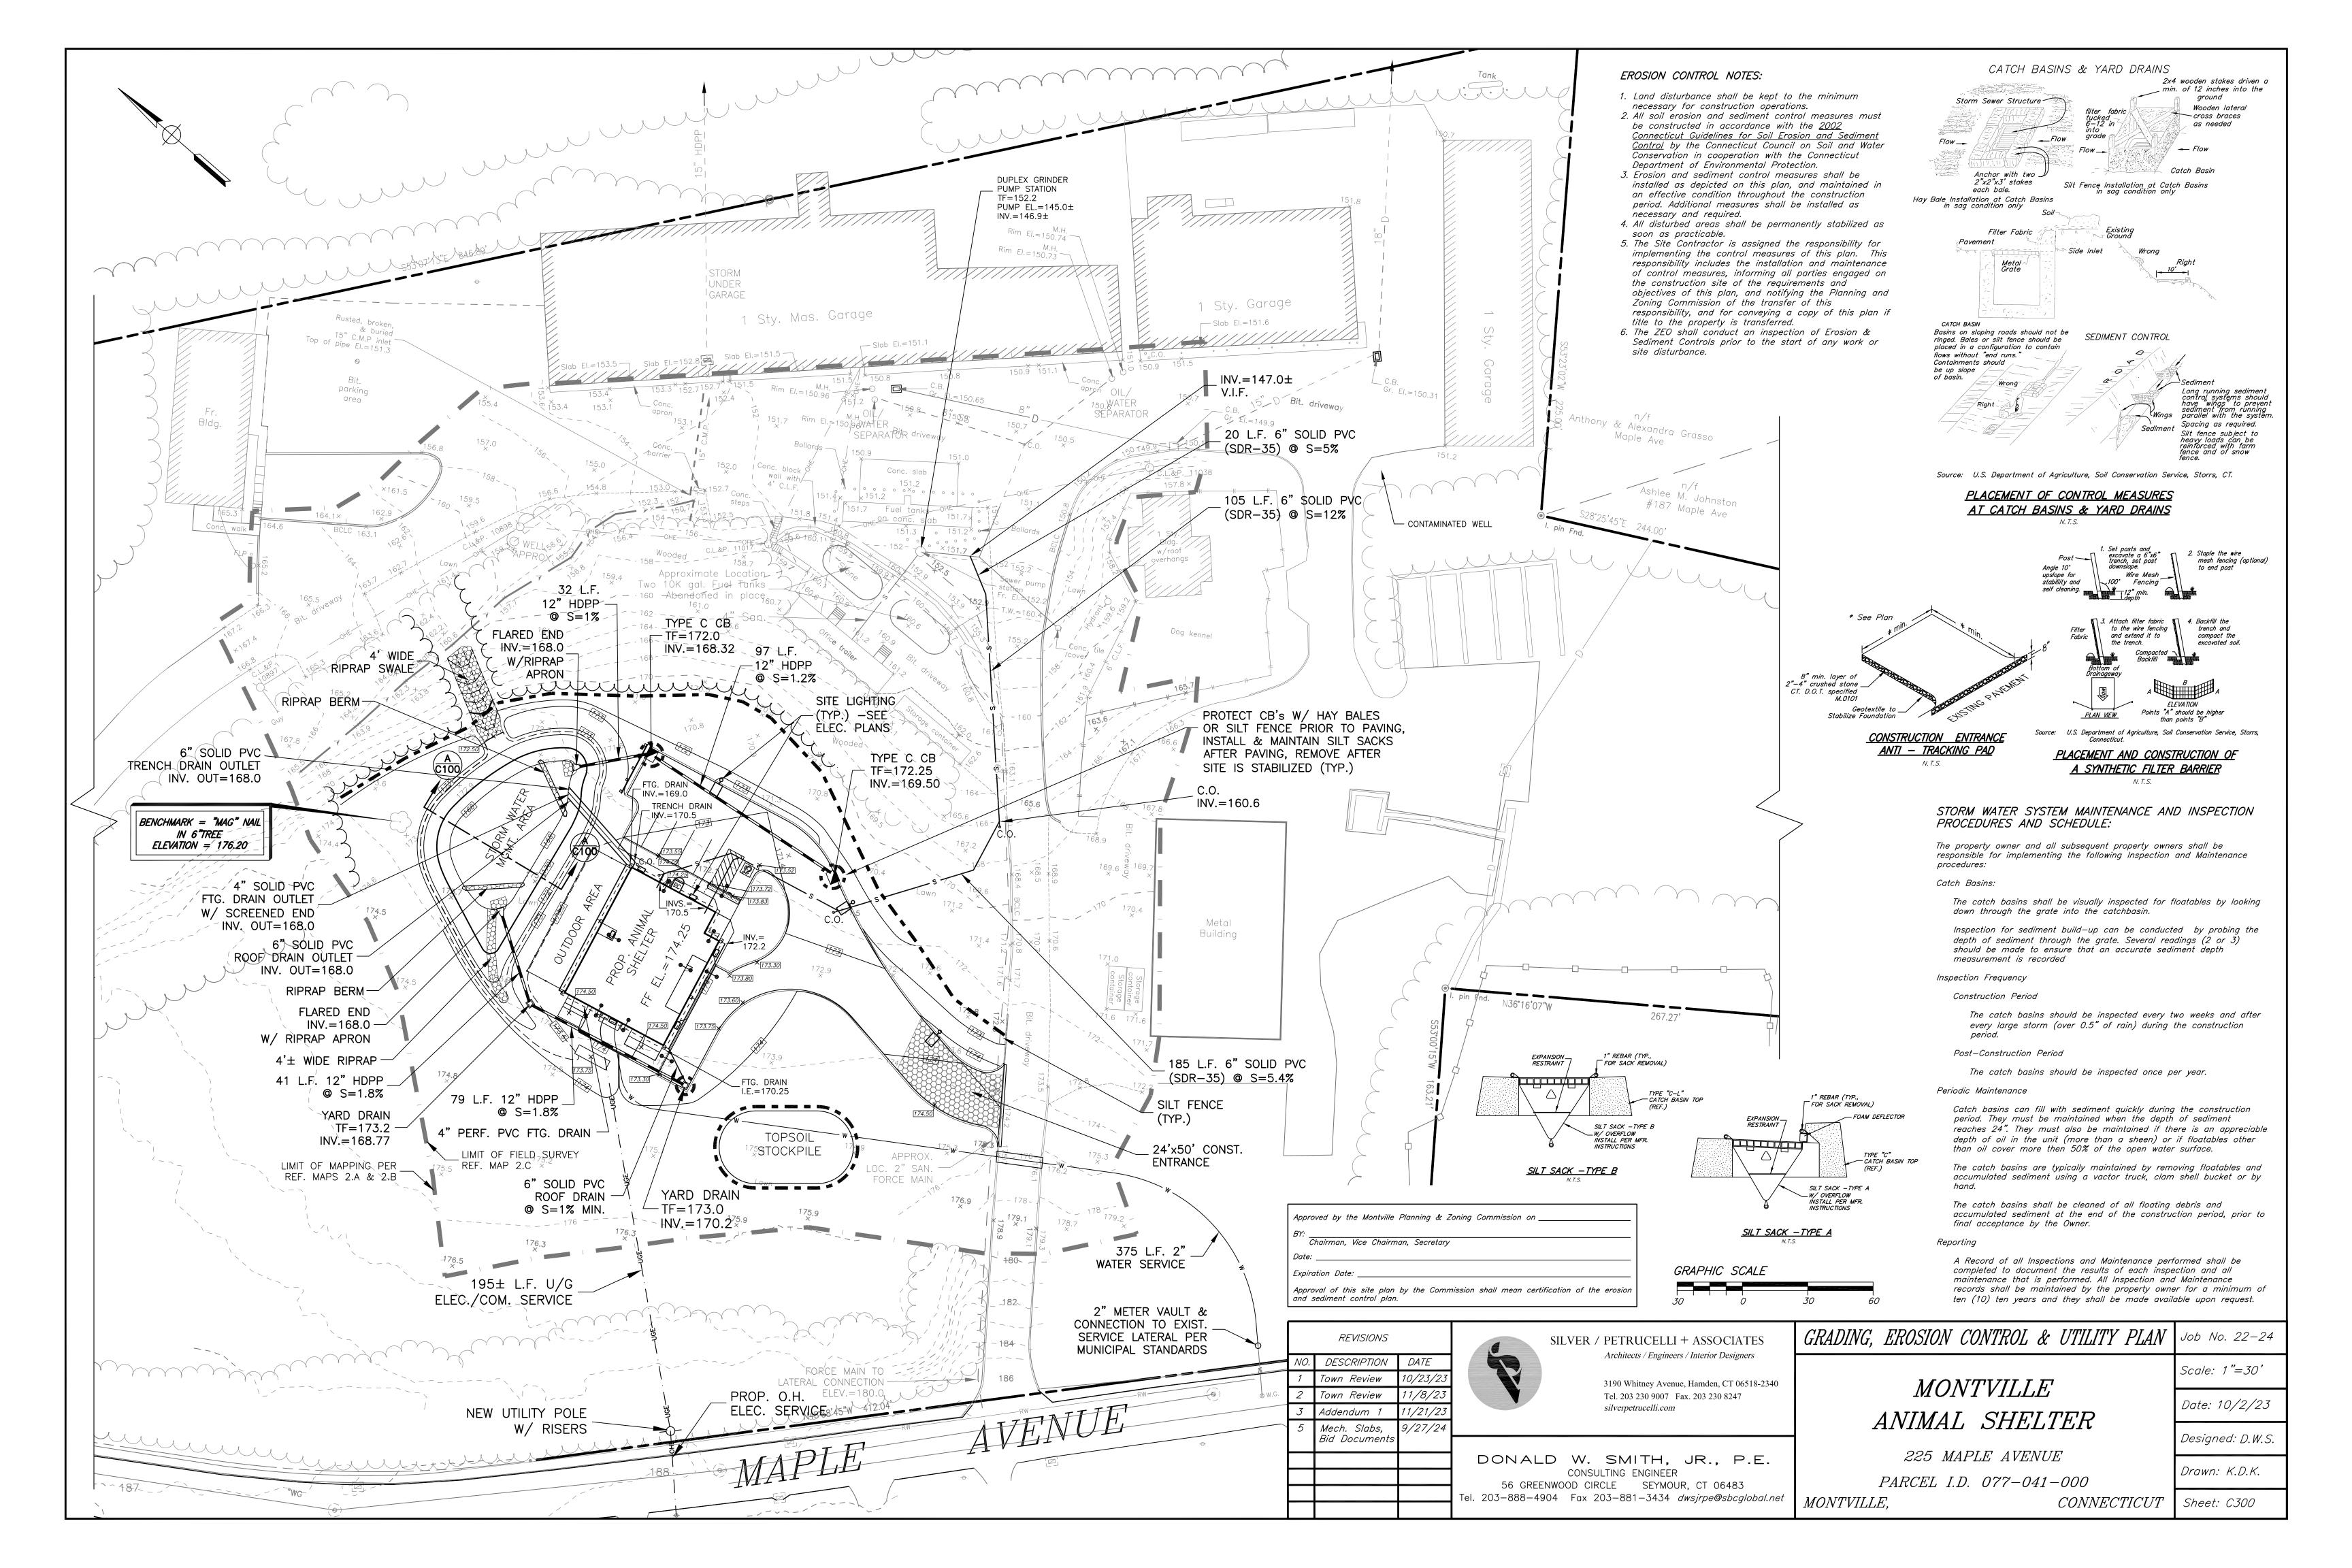
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CODE LEGE	ND	CODE INFORMATION	
	AREA IN SF 840 42 ROOM OCCUPANCY LOAD	DATE OF CONSTRUCTION 1. GROUP CLASSIFICATION (Chapter 3)	2023
MA	ACTUAL EGRESS OCC. OF DOOR 42 X. ALLOWABLE EGRESS OCC. OF DOOR 168 EXIT CAPACITY	(Primary)	B (BUSINESS)
C216	ROOM NUMBER	2. CONSTRUCTION TYPE (Chapter 6) Minimum Type Required	5B
<u>1227</u>	→ DIRECTION OF TRAVEL W/ ACCUMULATED OCC. LOAD ●	3. BUILDING HEIGHT (Chapter 5) Allowable Height (story/feet)	2/40'-0"
<u>TD 145'</u>	- ightarrow maximum travel distance from furthest point	Actual Height (story/feet) (Stories Above Grade)	1/25'-7" 1
<u> 198' </u>	─ → COMMON PATH OF TRAVEL	4. BUILDING AREA (Chapter 5)1) Building Area (Grade Level)	
	1 HOUR FIRE RATED WALL AND SMOKE BARRIER	Building Floor Area (Net) 5. AREA MODIFICATIONS TO TABLE 506.2	2,260 sq.ft.
	2 HOUR FIRE WALL 2 HOUR FIRE RATED WALL AND SMOKE	Total Perimeter = $\frac{51.33}{51.33}$ ft. $\frac{64.67}{51.31}$ ft.	
	BARRIER LOT LINE	Open Perimeter = $\frac{51.33}{N}$ ft. $\frac{64.67}{E}$ ft	W S
00	DENOTES ACCESSIBLE THRESHOLD 1/2" MAX STEP	C ()	rimeter (P)ft. erimeter of the entire building)
	W/BEVELED THRESHOLD OR 1/2" STEP W/OUT BEVELED THRESHOLD	Width of open space (W) = >30'	
60.66'	- DIMENSION OF OPEN PERIMETER ALONG ENTIRE LONGITUDINAL FACE	100[<u>167.33 / 2</u> 32 - 0.25] <u>30/3</u> 0= <u>47</u>	
(60.66')	- DIMENSION OF NON-OPEN PERIMETER ALONG ENTIRE LONGITUDINAL FACE	BUSINESS: Aa = At + (NS x If)	
		At = 9,000 NS = 9,000	
		Aa = 9,000 + (9,000 x .47) Aa = 13,230 sq. ft. (Max allowable area)	
		6. CASE 1 - NONSEPARATED OCCUPANCIES (508.	3)
		(NOT USED) 7. CASE 2 - SEPARATED OCCUPANCIES (508.4)	
		B ACTUAL FLOOR AREA2,260 soB ALLOWABLE FLOOR AREA13,230 so= 0.171	<u>q.</u> ft.
	П	0.171 < 1.0 8. FIRE-RESISTANCE RATED REQUIREMENTS FOR (Table 601, See Code Plans for specific design	BUILDING ELEMENTS
		1 Structural frame: including columns, girders, trusses	0 Hr(s)
		2 Bearing walls: Exterior (Table 602) Interior	0 Hr(s) 0 Hr(s)
		3 Nonbearing walls & partitions Exterior (Table 602)	0 Hr(s)
		4 Nonbearing walls & partitions Interior	0 Hr(s)
		 5 Floor Construction (including supporting beams & joists) 6 Roof Construction (including supporting beams & joists) 	0 Hr(s) 0 Hr(s)
	-14	9. OCCUPANCY LOAD Design Total for the Building	322
		Total Exit Capacity for the Building	3,528Not
		M-XXX-XXX /(IBC 506.2)	Approved Approved
CATTERY 103		(Allowable Area Increase) N/A	
QUARANTINE CORR.		N/A	
		11. ACCESSIBLE BUILDING	X Designated Non Designated
\rightarrow		12. MINIMUM PLUMBING FIXTURE COUNT (I.P.C.	-
	ک ۱	For each type of occupancy per entire facility <u>EDUCATIONAL (E) Group occupancy:</u>	
		TOTAL Occupancy Load (Use E) : (Design Load Required	
MECH IT/ELEC. 106		W/C 0.60 Lavs 0.36	
		D/F 0 Service Sink 0	
		TOTAL REQUIRED AND PROVIDED QUANTIT	
		Use of unisex toilets and lavs within classroo female count as approved by modification re	quest no. M-xxx
	$\underline{1} \longrightarrow$	Required W/C 0.60 (1) Lavs 0.38 (1)	Provided 1 1
		Lavs 0.38 (1) D/F 1 Service Sink 0	
		-Service sinks are not required as per IBC 2902.1 note -Separate facilies are note required as per IBC 2902.2 e	E
		13. ENTIRE BUILDING SPRINKLERED	Yes No X
		14. THRESHOLD BUILDING CONDITIONS	Yes No X
		15. CODES TO WHICH THIS PROJECT WAS DESIG	
EXTERIOR DOG RUN			021 IBC / 2022 CT 021 IEBC / 2022 CT
		State Fire Code w/ CT Amendments 20)21 IFC / 2022 CT)21 IBC / 2022 CT
		State Mechanical Code w/ CT Amendments 20)21 IMC / 2022 CT)21 IPC / 2022 CT
		State Energy Conservation Code w/ CT Amendments 20	021 IECC / 2022 CT 017 NFPA 70/2018 CT Amend.
		State Health Code m	ost current
		Section 504 cu	Irrent 110 ADA
		ANSI 117.1 20	009 ICC A117.1
Date: Revised By: 09/27/2024	Drawing Title: BUILDING CODE PLANS &	Date: 09/27/2024	Drawing Number:
	INFORMATION	Scale: As indicated	— G001
		Drawn By: MES	
		Project Number: 22.130	







GENERAL CONSTRUCTION SEQUENCE:

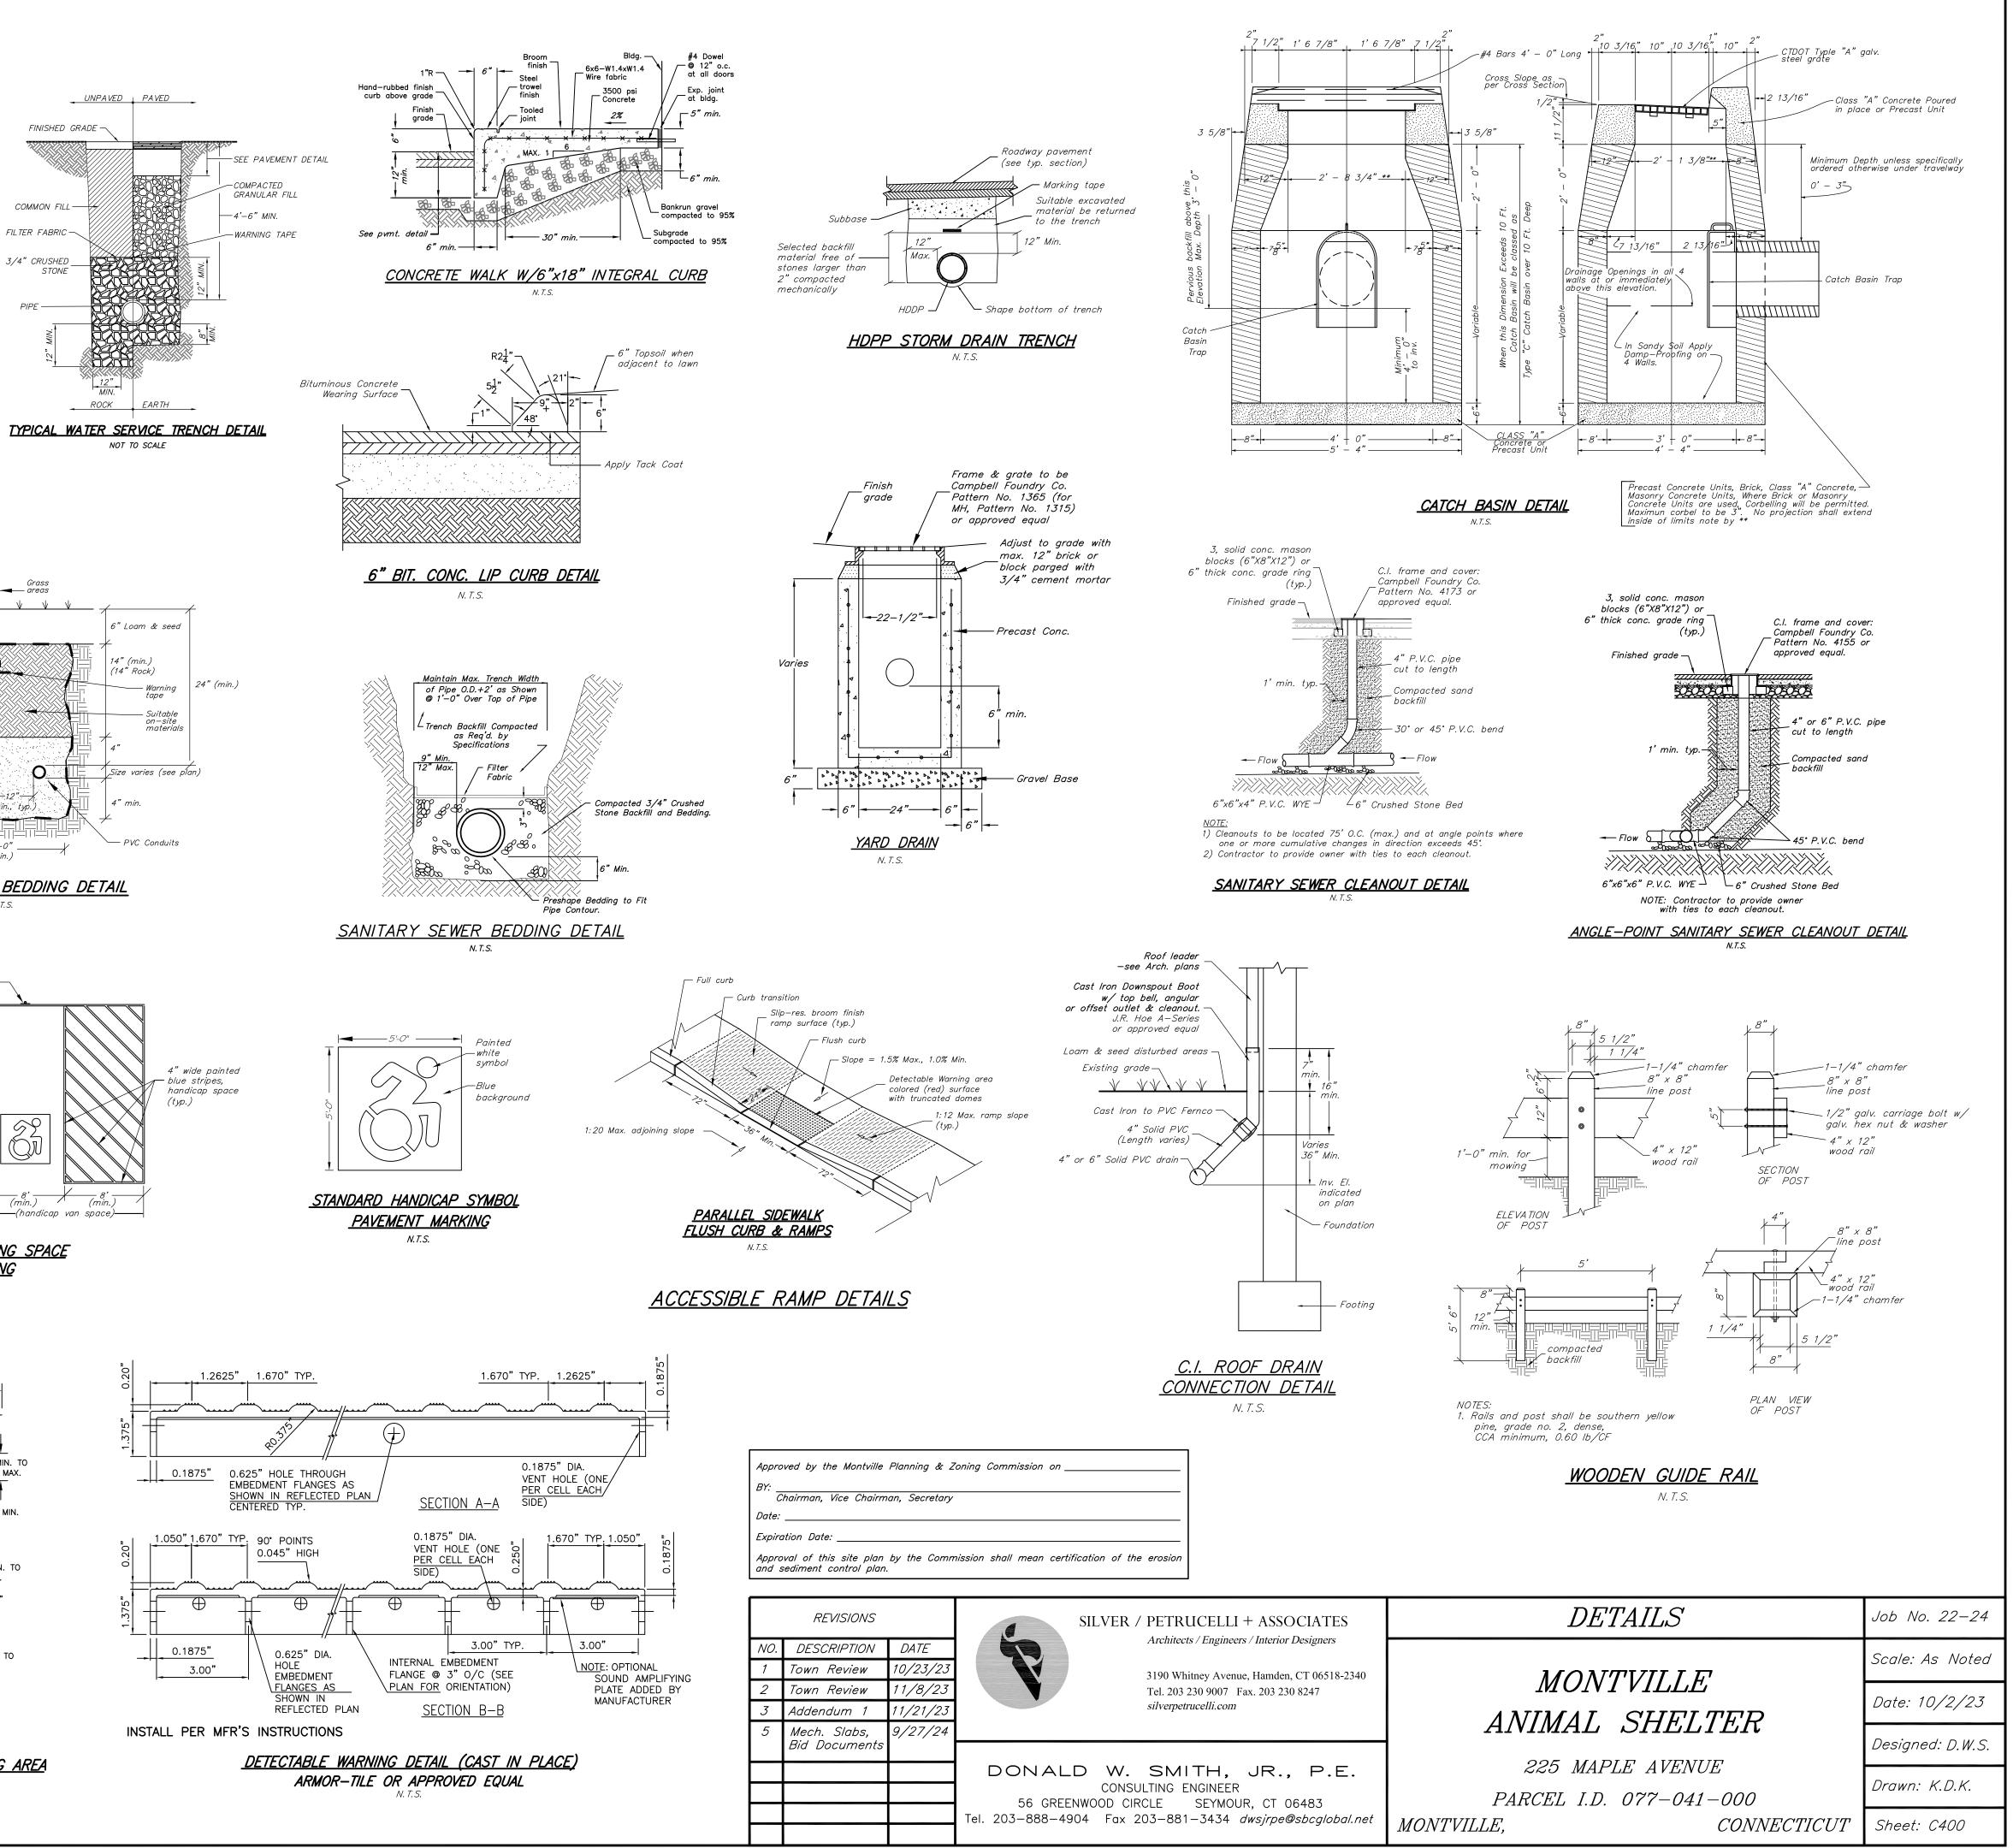
The anticipated time of completion for all aspects of construction is ten (10) months from the initial start date.

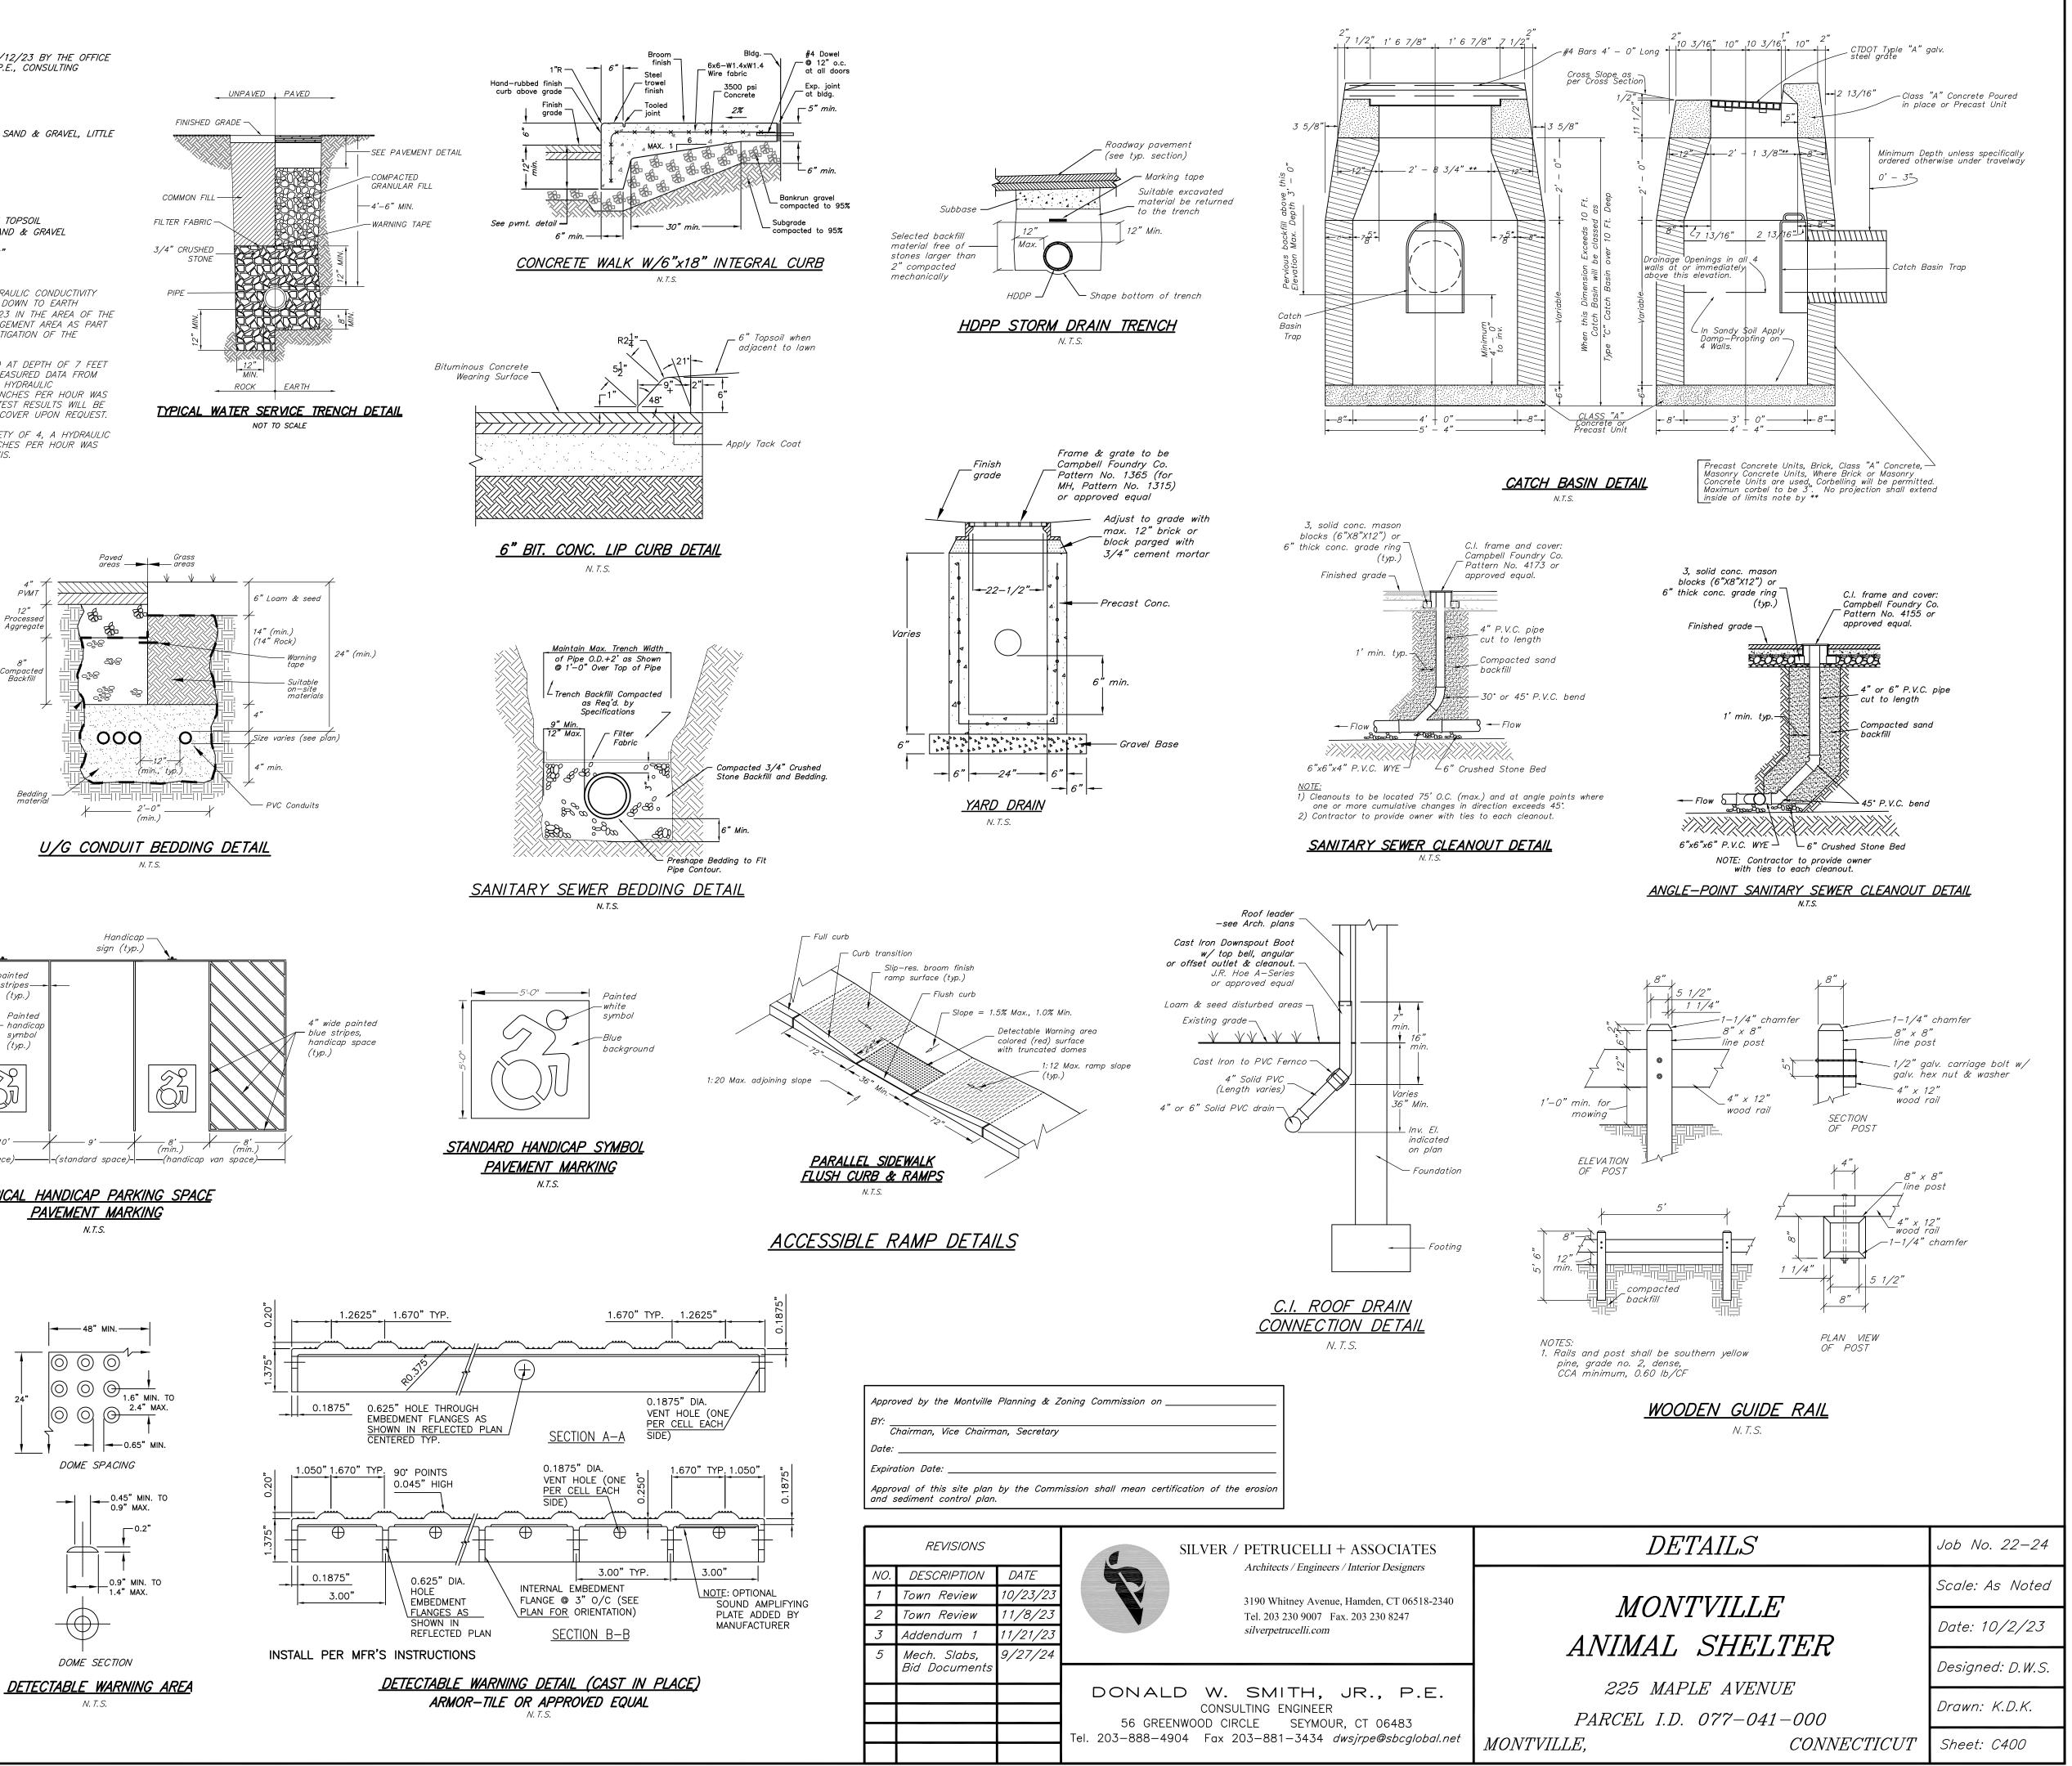
holding a pre-construction meeting with the design team and appropriate Town of Montville officials and for notifying "Call Before You Dig" (1-800-922-4455) of the proposed project. (Estimated Time: 3 days)

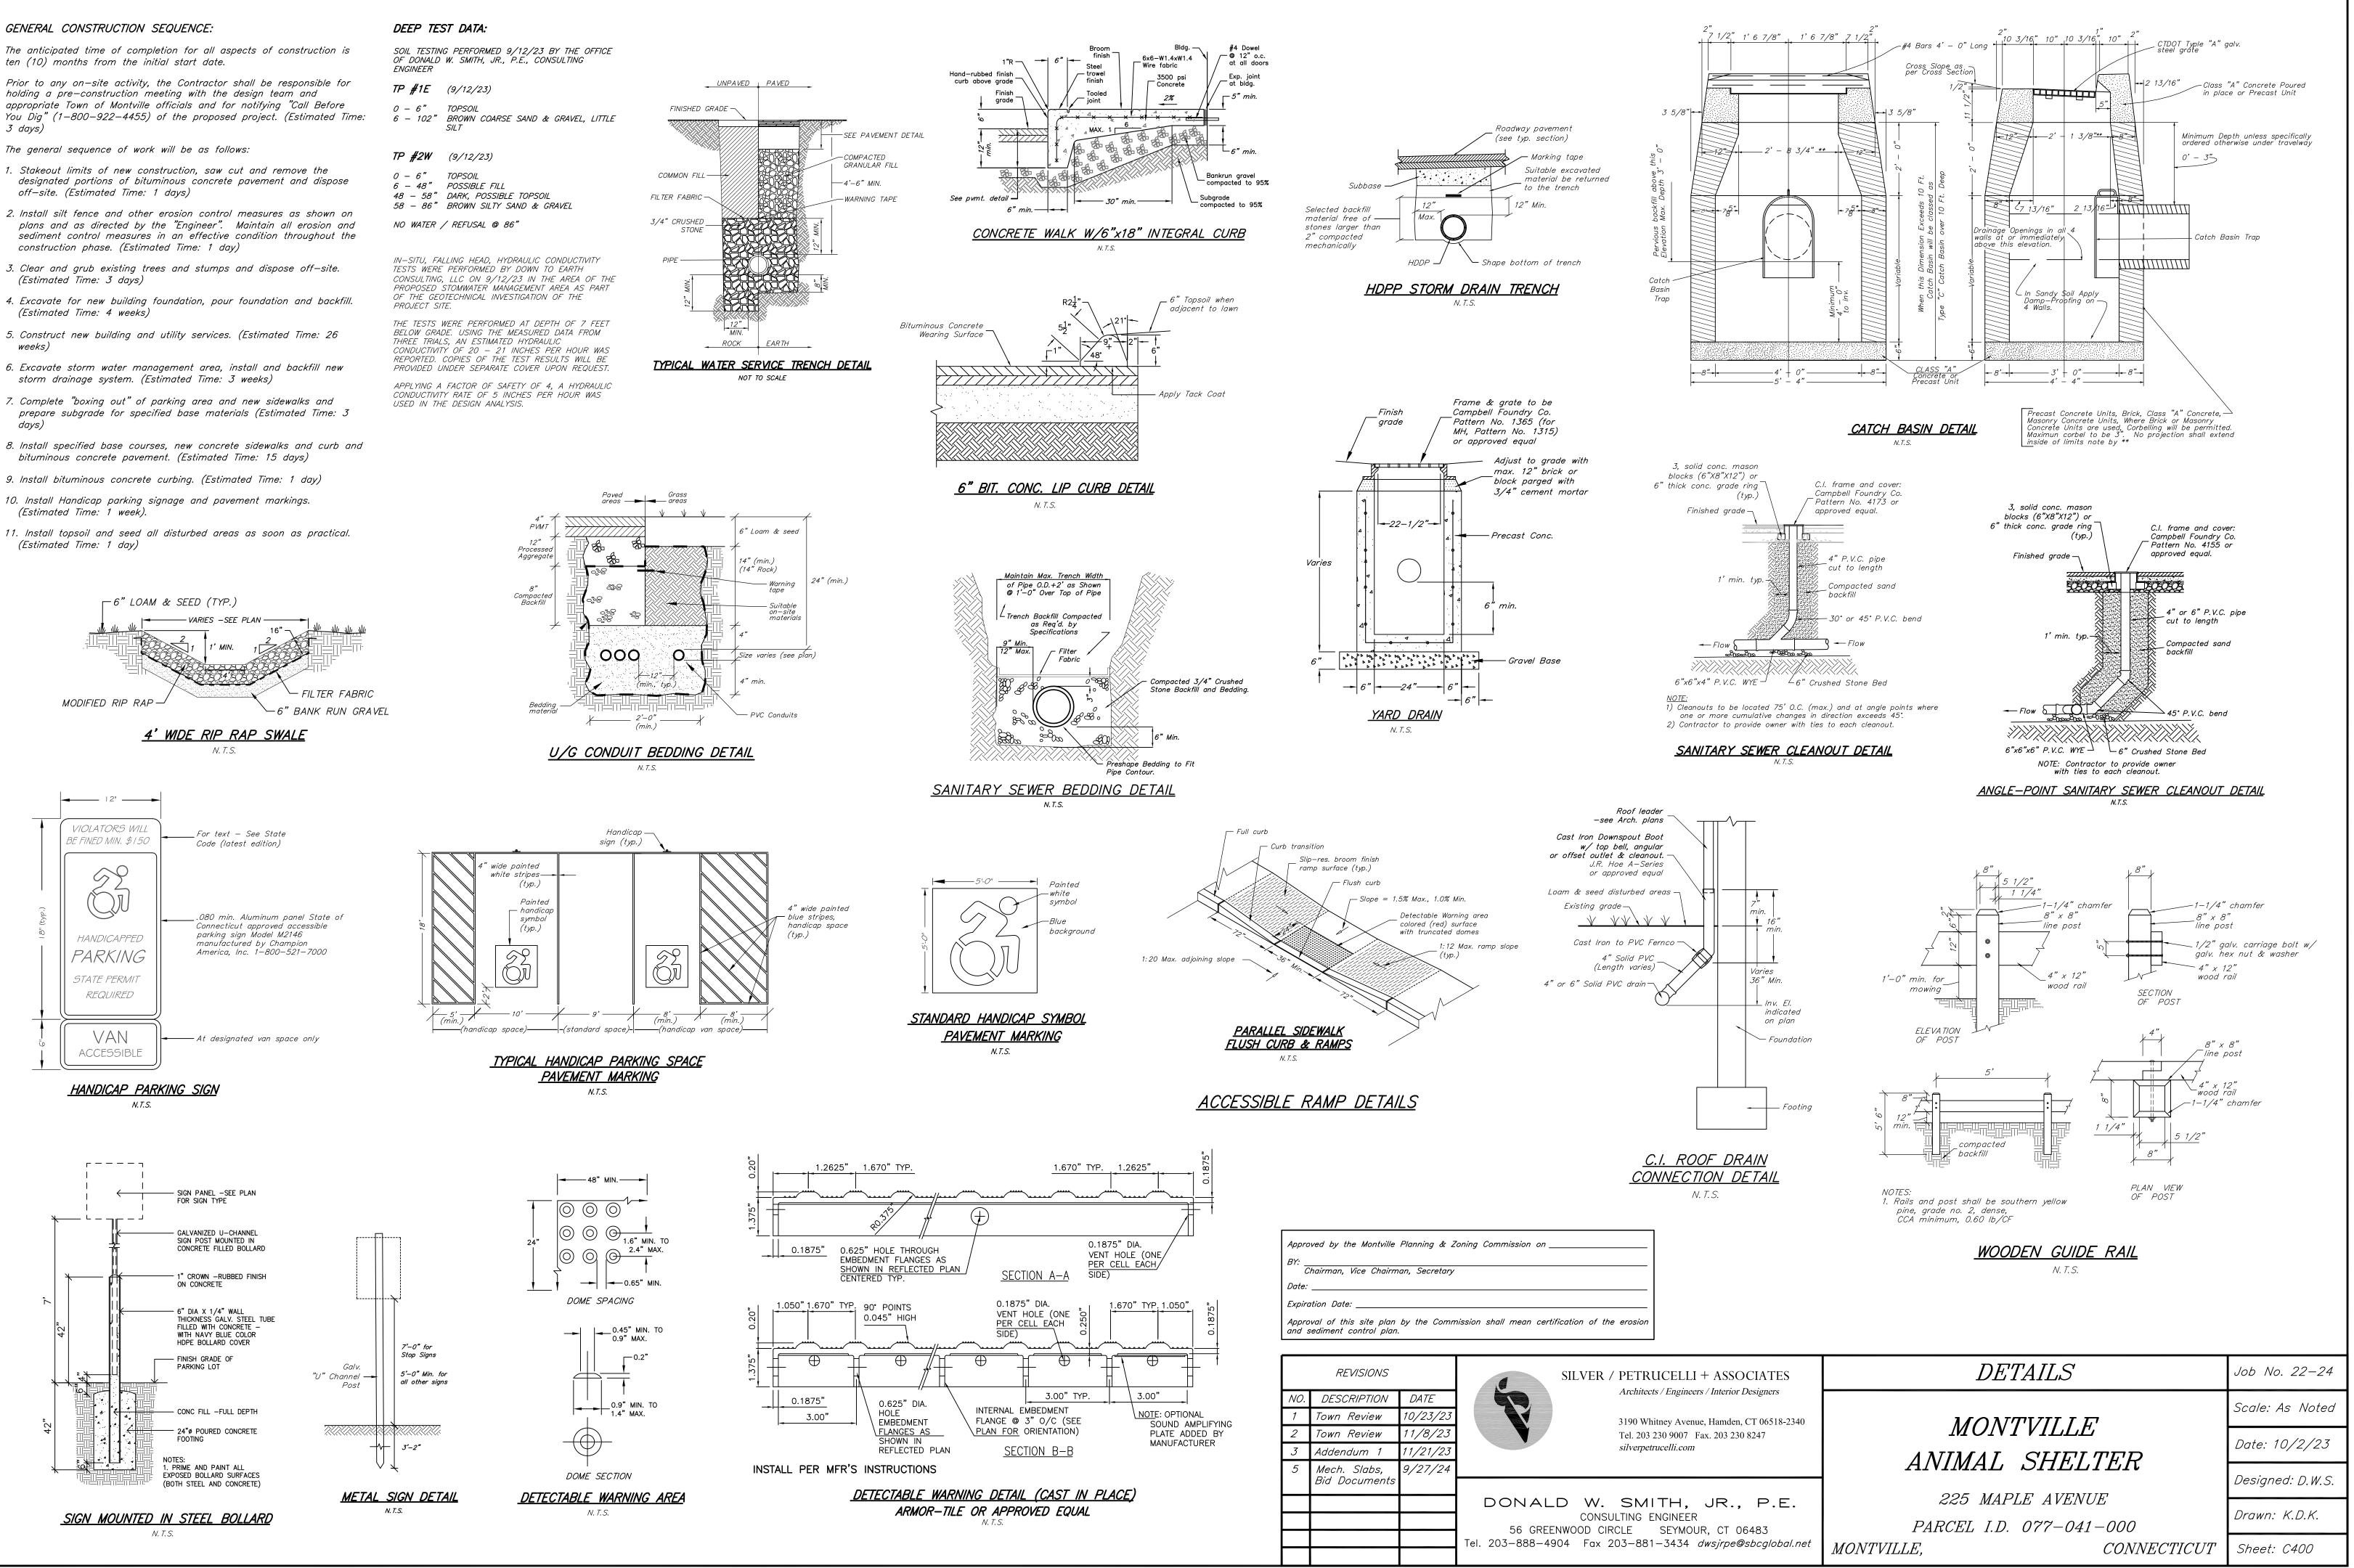
The general sequence of work will be as follows:

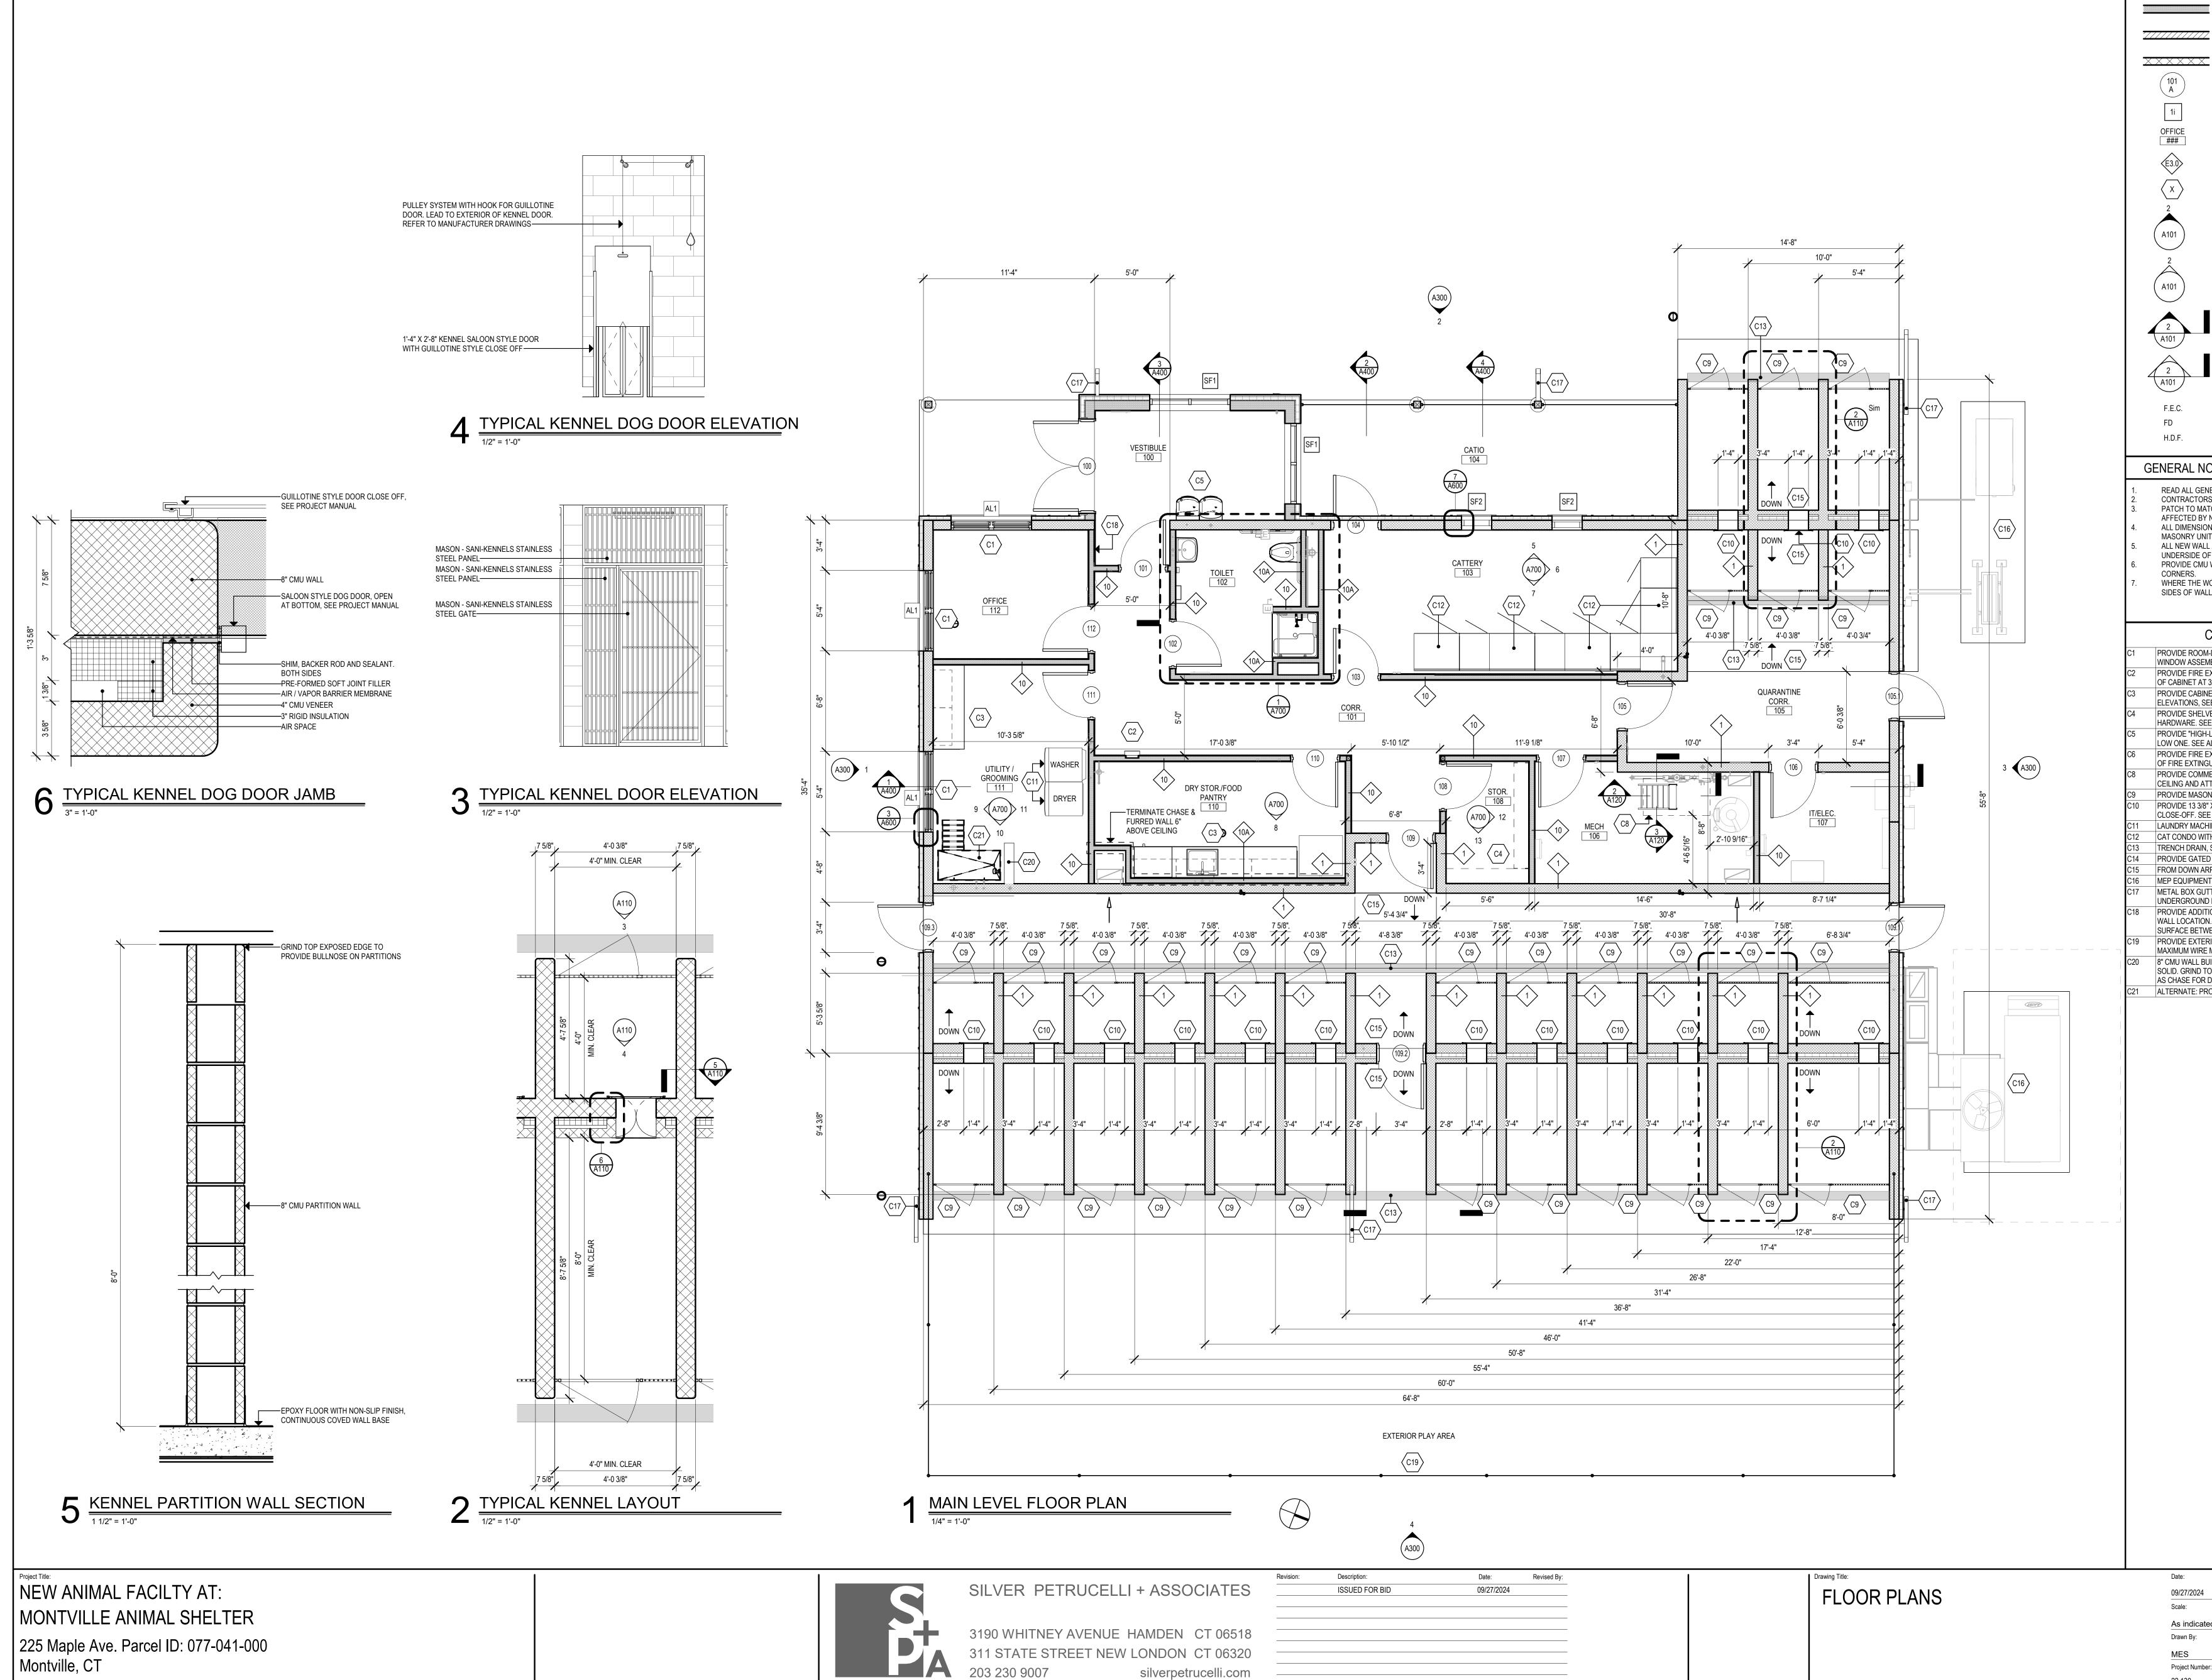
- designated portions of bituminous concrete pavement and dispose
- 2. Install silt fence and other erosion control measures as shown on sediment control measures in an effective condition throughout the construction phase. (Estimated Time: 1 day)
- 3. Clear and grub existing trees and stumps and dispose off-site. (Estimated Time: 3 days)
- 4. Excavate for new building foundation, pour foundation and backfill. (Estimated Time: 4 weeks)
- weeks)
- storm drainage system. (Estimated Time: 3 weeks)
- 8. Install specified base courses, new concrete sidewalks and curb and
- 9. Install bituminous concrete curbing. (Estimated Time: 1 day)
- 10. Install Handicap parking signage and pavement markings.
- 11. Install topsoil and seed all disturbed areas as soon as practical.

PROPOSED STOMWATER MANAGEMENT AREA AS PART OF THE GEOTECHNICAL INVESTIGATION OF THE









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Sì	MBOL LEGEN	D
		- NEW METAL STUD PARTITIONS
77	///////////////////////////////////////	- NEW MASONRY WALL
X	XXXXX	- NEW CMU WALL
	(101 A)	- DOOR NUMBER
	1i	- WINDOW TYPE
	OFFICE ###	- ROOM NAME - ROOM NUMBER
	E3.0	- PARTITION TYPE
	$\langle x \rangle$	- CONSTRUCTION NOTE
	2	- EXTERIOR ELEVATION NUMBER
(A101	- SHEET NUMBER
	2	
	\bigwedge	- INTERIOR ELEVATION NUMBER
(A101	- SHEET NUMBER
	2 A101	- BUILDING SECTION NUMBER - SHEET NUMBER
4	2 A101	- WALL SECTION NUMBER - SHEET NUMBER
	F.E.C.	- FIRE EXTINGUISHER CABINET
	FD	- FLOOR DRAIN - SLOPE TO DRAIN
	H.D.F.	- HANDICAPPED DRINKING FOUNTAIN
G	ENERAL NOTE	S
. 2. 3. 5. 5. 7.	CONTRACTORS SHA PATCH TO MATCH AL AFFECTED BY NEW V ALL DIMENSIONS ARI MASONRY UNITS ANI ALL NEW WALL AND I UNDERSIDE OF DECH PROVIDE CMU WITH CORNERS.	NOTES ON DRAWING G000. LL FIELD VERIFY ALL CONDITIONS AND DIMENSIONS. L EXISTING WALLS AND CEILINGS TO REMAIN VORK. E TO OUTSIDE FACE OF BRICK, CONCRETE D FINISH FACE OF WALL OTHERWISE NOTED. PARTITION ASSEMBLIES SHALL EXTEND TO & UNLESS OTHERWISE NOTED. PRE-MANUFACTURED BULLNOSE AT <u>ALL</u> EXPOSED ALIGN" IS INDICATED IT SHALL MEAN TO ALIGN BOTH
	CON	STRUCTION NOTES
1	PROVIDE ROOM-DARK WINDOW ASSEMBLY. S	ENING HORIZONTAL BLIND SYSTEM FOR EACH HALF OF
2	PROVIDE FIRE EXTING	UISHER AND SEMI-RECESSED CABINET. SET BOTTOM .F. SEE PROJECT MANUAL.
}		ASEWORK, COUNTERS AND FIXTURES. SEE INTERIOR
1		TH REQUIRED BRACKETS AND ASSOCIATED RIOR ELEVATIONS, SEE ALSO PROJECT MANUAL.
5		DOUBLE WATER COOLER UNIT WITH BOTTLE FILLER AT
6	PROVIDE FIRE EXTUN	GUISHER SURFACE MOUNTED TO STUD. SET BOTTOM R 32" A.F.F. SEE PROJECT MANUAL
3	PROVIDE COMMERIAL	ATTIC LADDER WITH BOX ENCLOSURE BETWEEN ATFORM. SEE PROJECT MANUAL.
9	PROVIDE MASON - SAM	NI-KENNEL STAINLESS STEER GATE AND PANELS

PROVIDE 13 3/8" X 31 3/8" SALOON STYLE DOG DOOR WITH GUILLOTINE STYLE CLOSE-OFF. SEE PROJECT MANUAL. LAUNDRY MACHINE AND DRYER, PROVIDED BY OWNER.

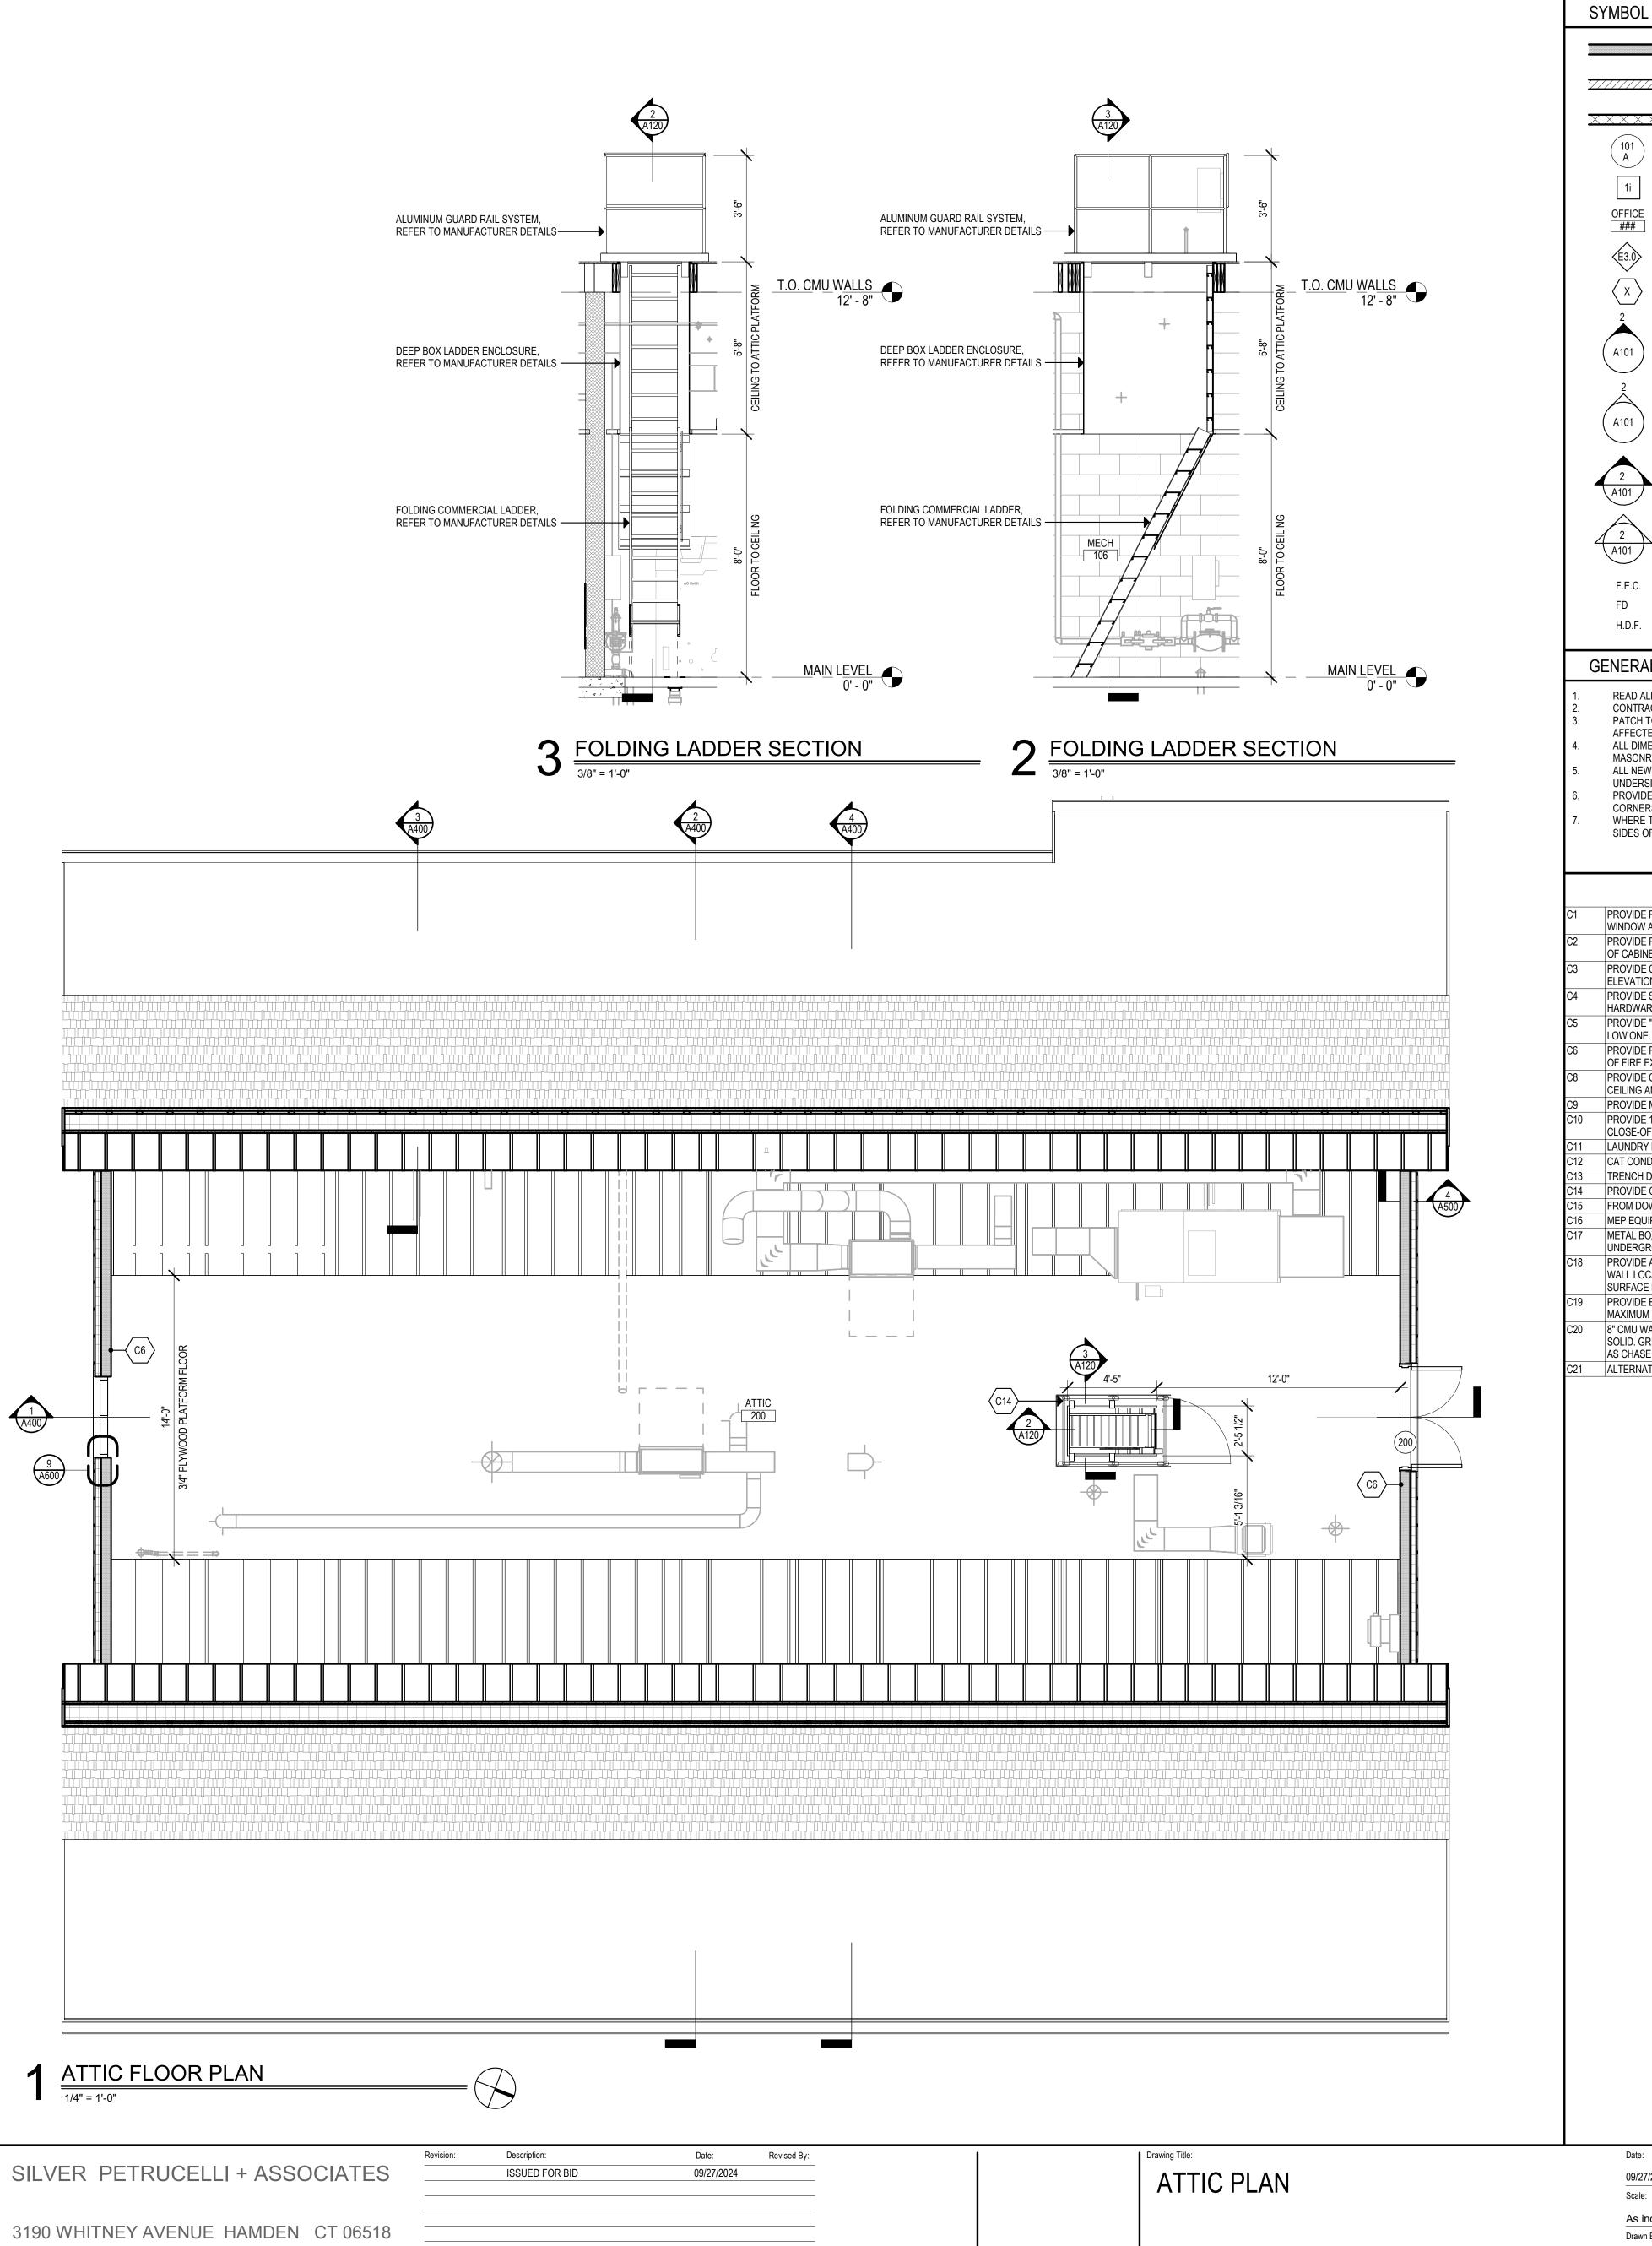
CAT CONDO WITH ATTACHED LITTER BOX ROOM, PROVIDED BY OWNER. TRENCH DRAIN, SEE PLUMBING DRAWINGS. PROVIDE GATED HANDRAIL FOR ATTIC LADDER, SEE PROJECT MANUAL. FROM DOWN ARROW, SLOPE SLAB TOWARDS TRENCH DRAIN @ 1/4" PER 12 MEP EQUIPMENT ON EXTERIOR SLABS, REFER TO CIVIL AND MEP DRAWINGS METAL BOX GUTTER AND DOWN SPOUT. CONNECT DOWNSPOUT INTO UNDERGROUND DRAINAGE VIA CAST IRON BOOT. SEE CIVIL DRAWINGS. PROVIDE ADDITIONAL LAYER OF 5/8" GYPSUM WALL BOARD AT SPECIFIED WALL LOCATION. ADDITIONAL LAYER IS REQUIRED TO PROVIDE FLUSH SURFACE BETWEEN GYPSUM WALLS.

PROVIDE EXTERIOR GALV. CHAIN LINK FENCE ENCLOSURE, 6' HIGH. 1 1/2" MAXIMUM WIRE MESH, 11 GAUGE MINIMUM. SEE CIVIL DRAWINGS 8" CMU WALL BUILT UP TO 4'. PROVIDE MORTAR MESH AND FILL TOP COURSE SOLID. GRIND TOP EDGE IN FIELD TO MATCH BULLNOSE. USE BLOCK CAVITIES AS CHASE FOR DOG GROOMING STATION. ALTERNATE: PROVIDE STAINLESS STEEL DOG GROOMING STATION.

Drawing Number:



Project Number: 22.130





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1 A400

Date:	Revised By:		Drawing 1	Title:	Date
09/27/2024			∧-	TTIC PLAN	09/2
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	- NEW METAL STUD PARTITIONS			
/////	- NEW MASONRY WALL			
	- NEW CMU WALL			
)	- DOOR NUMBER			
	- WINDOW TYPE			
E]	- ROOM NAME - ROOM NUMBER			
•	- PARTITION TYPE			
>	- CONSTRUCTION NOTE			
	- EXTERIOR ELEVATION NUMBER			
)	- SHEET NUMBER			
	- INTERIOR ELEVATION NUMBER			
)	- SHEET NUMBER			
	- BUILDING SECTION NUMBER - SHEET NUMBER			
	- WALL SECTION NUMBER - SHEET NUMBER			
	- FIRE EXTINGUISHER CABINET			
	- FLOOR DRAIN - SLOPE TO DRAIN - HANDICAPPED DRINKING FOUNTAIN			
AL NOTES ALL GENERAL NOTES ON DRAWING G000. RACTORS SHALL FIELD VERIFY ALL CONDITIONS AND DIMENSIONS. I TO MATCH ALL EXISTING WALLS AND CEILINGS TO REMAIN TED BY NEW WORK. MENSIONS ARE TO OUTSIDE FACE OF BRICK, CONCRETE NRY UNITS AND FINISH FACE OF WALL OTHERWISE NOTED. WWALL AND PARTITION ASSEMBLIES SHALL EXTEND TO RSIDE OF DECK UNLESS OTHERWISE NOTED. DE CMU WITH PRE-MANUFACTURED BULLNOSE AT <u>ALL</u> EXPOSED ERS. E THE WORD "ALIGN" IS INDICATED IT SHALL MEAN TO ALIGN BOTH OF WALL.				
CON	STRUCTION NOTES			
	ENING HORIZONTAL BLIND SYSTEM FOR EACH HALF OF SEE PROJECT MANUAL			
E FIRE EXTING	UISHER AND SEMI-RECESSED CABINET. SET BOTTOM F. SEE PROJECT MANUAL.			
E CABINETS, C	ASEWORK, COUNTERS AND FIXTURES. SEE INTERIOR O PROJECT MANUAL.			
e shelves wi Are. See inte E "High-Low" I Ie. See Also M E Fire Extund	TH REQUIRED BRACKETS AND ASSOCIATED RIOR ELEVATIONS, SEE ALSO PROJECT MANUAL. DOUBLE WATER COOLER UNIT WITH BOTTLE FILLER AT IEP DRAWINGS. GUISHER SURFACE MOUNTED TO STUD. SET BOTTOM			
	R 32" A.F.F. SEE PROJECT MANUAL			

OF FIRE EXTINGUISHER 32" A.F.F. SEE PROJECT MANUAL

PROVIDE COMMERIAL ATTIC LADDER WITH BOX ENCLOSURE BETWEEN CEILING AND ATTIC PLATFORM. SEE PROJECT MANUAL. PROVIDE MASON - SANI-KENNEL STAINLESS STEER GATE AND PANELS

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27/2024

Drawing Number:



vn Bv: ject Number: 130



METAL BOX GUTTER, SEE PROJECT MANUAL-----

PVC MEMBRANE ROOF

10"

SILVER PETRUCELLI + ASSOCIATES

3190 WHITNEY AVENUE HAMDEN CT 06518 311 STATE STREET NEW LONDON CT 06320 203 230 9007 silverpetrucelli.com

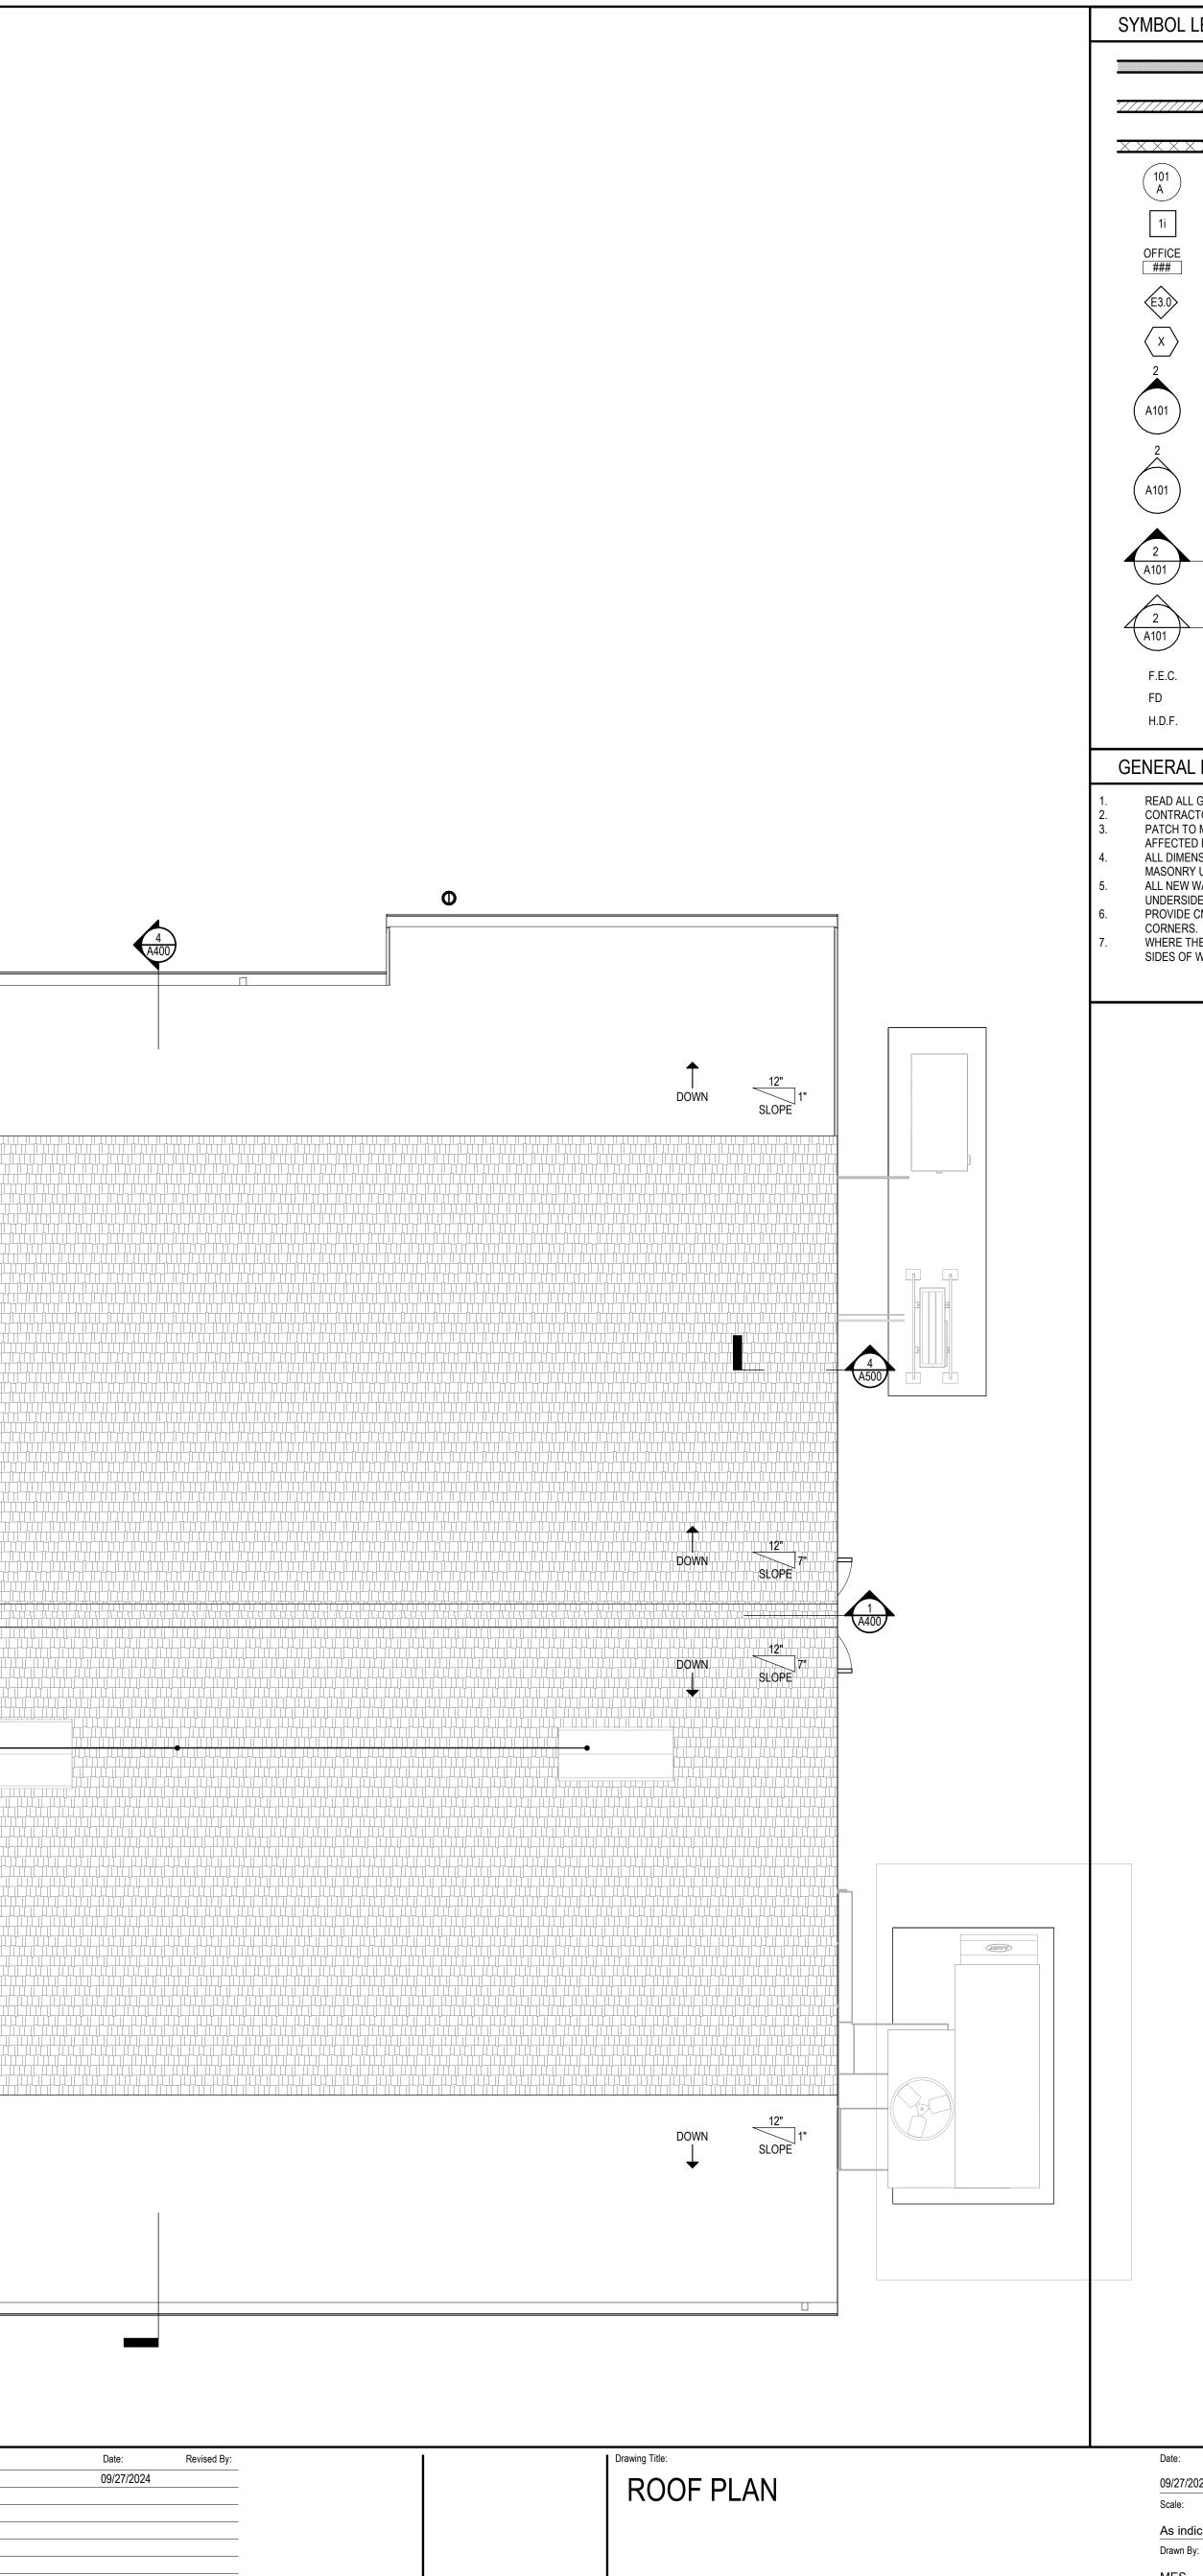
Description: ISSUED FOR BID

Revision:

2 A400

	SLOPE 1" DOWN
SPHAULT SHINGLE ROOF	
RIDGE VENT	
NTAKE AND EXHAUST VENTS, SEE MECHANICAL DRAWINGS	
ASPHAULT SHINGLE ROOF	
	12" 1" DOWN
	SLOPE
PVC MEMBRANE ROOF	
	Θ
IETAL BOX GUTTER, SEE	
PROJECT MANUAL	
	1 ROOF PLAN
	$\frac{\text{ROOF PLAN}}{1/4" = 1'-0"}$

A400



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Project Nu
22.130

L LEGENI					
	- NEW METAL STUD PARTITIONS				
/////	- NEW MASONRY WALL				
XX	- NEW CMU WALL				
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]	- ROOM NAME - ROOM NUMBER				
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	- FLOOR DRAIN - SLOPE TO DRAIN				
	- HANDICAPPED DRINKING FOUNTAIN				
AL NOTES					
ALL GENERAL NOTES ON DRAWING G000. AALTORS SHALL FIELD VERIFY ALL CONDITIONS AND DIMENSIONS. TO MATCH ALL EXISTING WALLS AND CEILINGS TO REMAIN TED BY NEW WORK. MENSIONS ARE TO OUTSIDE FACE OF BRICK, CONCRETE IRY UNITS AND FINISH FACE OF WALL OTHERWISE NOTED. W WALL AND PARTITION ASSEMBLIES SHALL EXTEND TO ISIDE OF DECK UNLESS OTHERWISE NOTED. DE CMU WITH PRE-MANUFACTURED BULLNOSE AT <u>ALL</u> EXPOSED IRS. E THE WORD "ALIGN" IS INDICATED IT SHALL MEAN TO ALIGN BOTH OF WALL.					

09/27/2024

As indicated ct Number: Drawing Number:

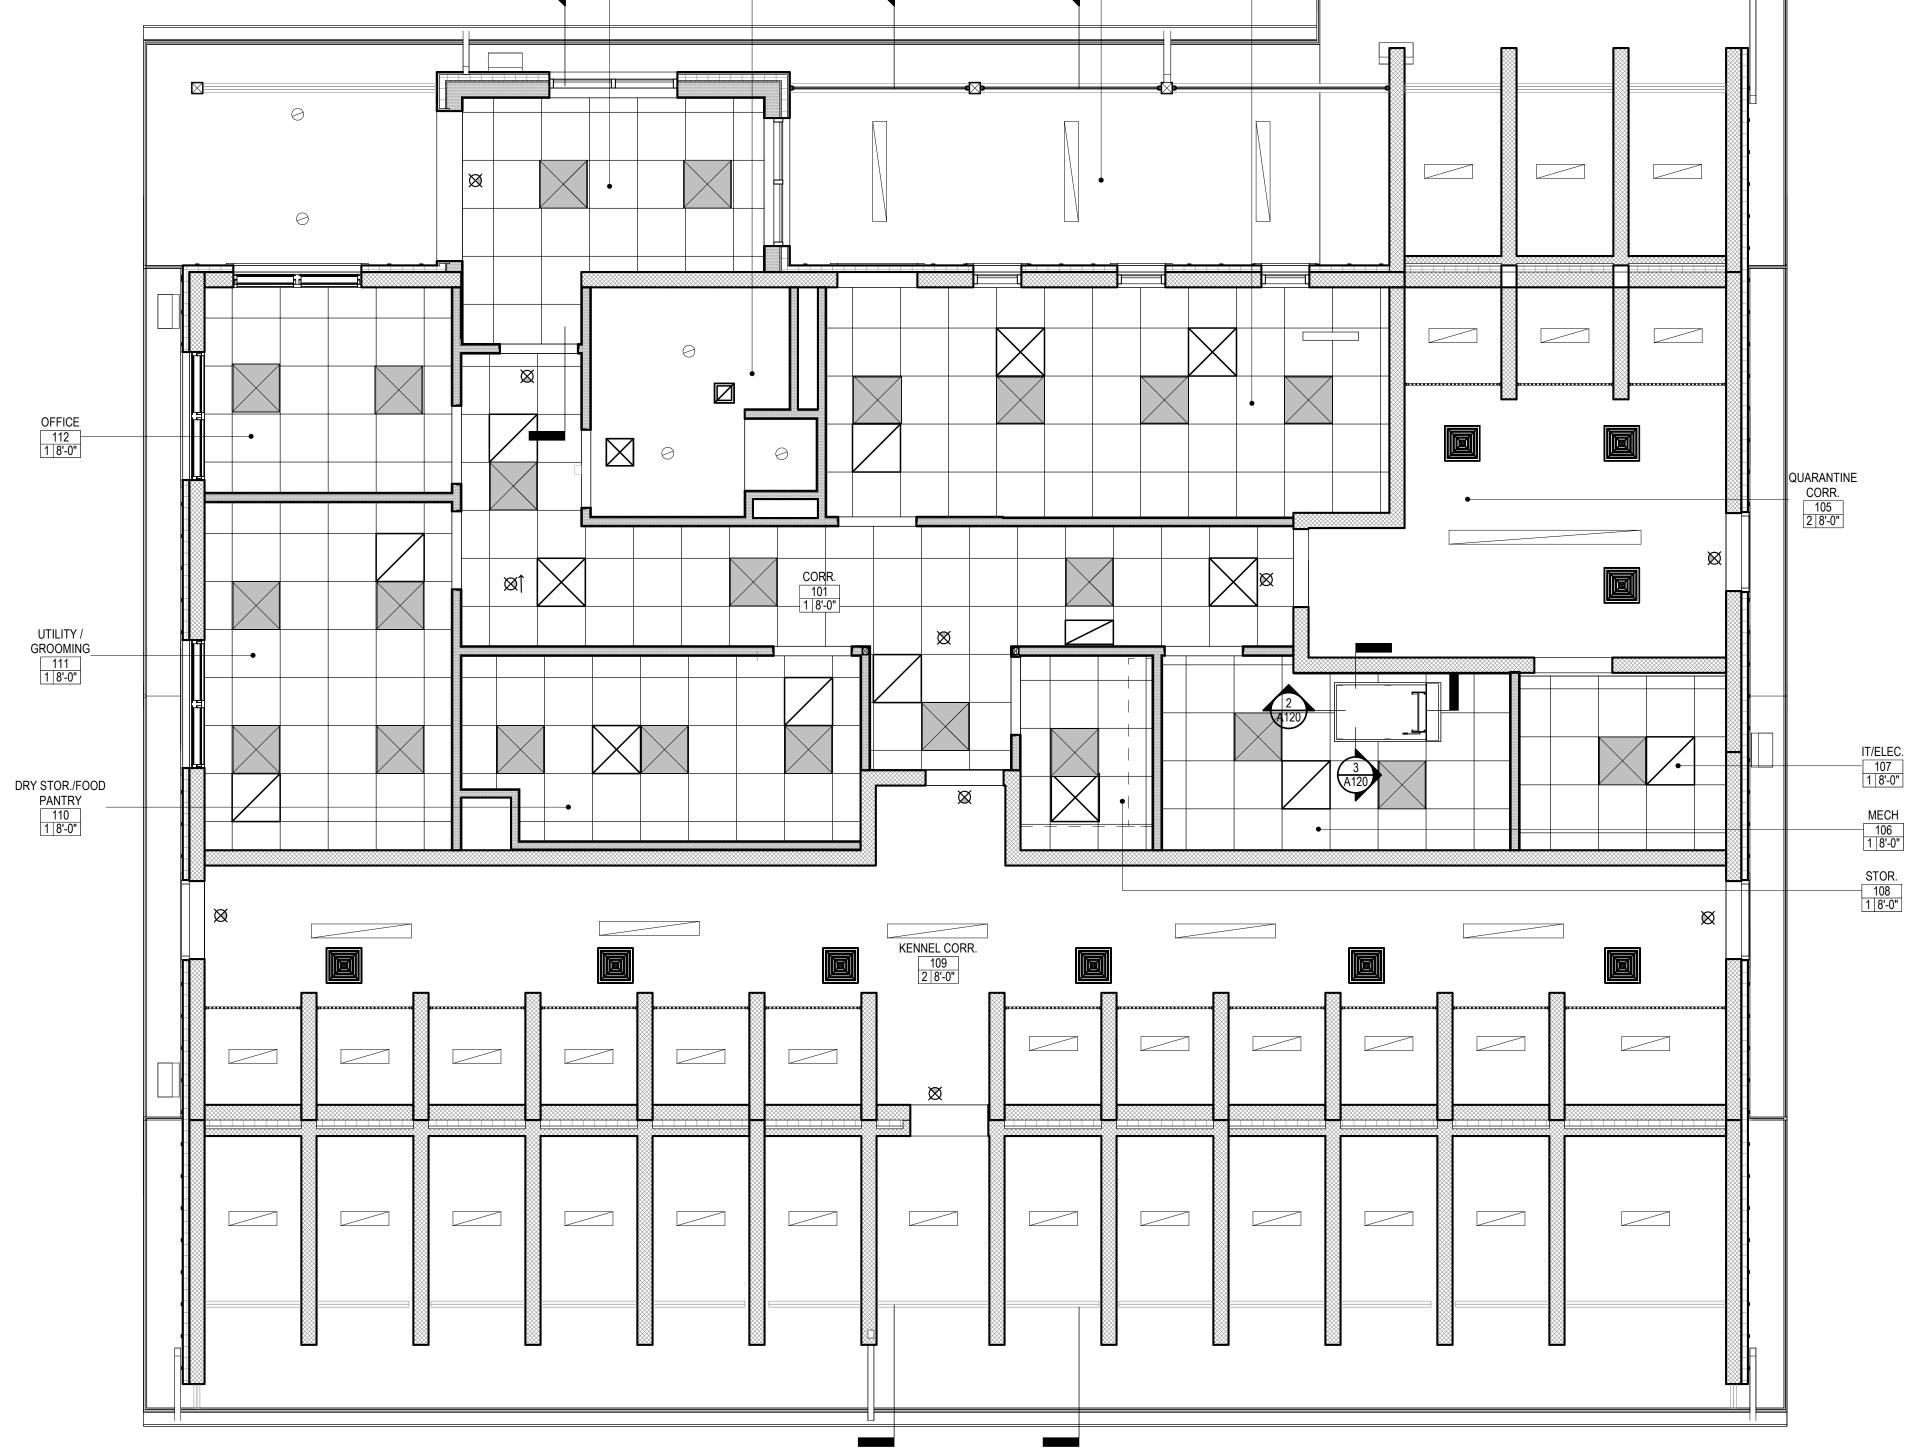




Revision: Description:
ISSUED FOR BID

3190 WHITNEY AVENUE HAMDEN CT 06518 311 STATE STREET NEW LONDON CT 06320203 230 9007silverpetrucelli.com

MAIN LEVEL REFLECTED CEILING PLAN SILVER PETRUCELLI + ASSOCIATES



102 2 8'-0" 2 A400

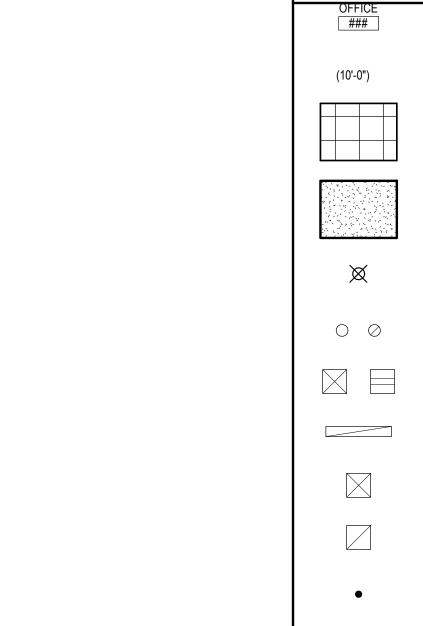
100 1 8'-0"

CATIO 104 3 --

2 8'-0"

4 A400

Date: Revised By:	1	Drawing Title:	Date:
09/27/2024		REFLECTED CEILING PLAN	09/27/202
			Scale:
			As indic
			Drawn By:
			MES
			Project Nur
			22.130



	CP SYMBOL LEGEND
OFFICE ###	- ROOM NAME - ROOM NUMBER
(10'-0")	- CEILING HEIGHT
	- 2' X 2' ACOUSTICAL CEILING TILES & GRID W/ SUPPORTS
	- PAINTED GYPSUM BOARD CEILING
\boxtimes	- EXIT SIGN, REFER TO ELECTRICAL DRAWINGS
0 Ø	- RECESSED LIGHT FIXTURES, REFER TO ELECTRICAL DRAWINGS
	- 2' X 2' LIGHT FIXTURE, REFER TO ELECTRICAL DRAWINGS
	- PENDENT STYLE LIGHT FIXTURE, REFER TO ELECTRICAL DRAWINGS
	- SUPPLY DIFFUSER, REFER TO MECHANICAL DRAWINGS
	- RETURN DIFFUSER, REFER TO MECHANICAL DRAWINGS
•	- CONCEALED SPINKLER HEAD, REFER TO FIRE PROTECTION DRAWINGS
0	- EXPOSED SPINKLER HEAD, REFER TO FIRE PROTECTION DRAWINGS
X	- CONSTRUCTION NOTE
X Axxx	- PLAN/SECTION/DETAIL NUMBER - SHEET NUMBER
REFLECTED	CEILING PLAN NOTES

ROOM NAME OFFICE ROOM NUMBER ### FINISH - HEIGHT # #"#"

<u>FINISH TYPE:</u> 1. ACOUSTIC CEILING TILE 2. 1/2" GYPSUM BOARD 3. VENTED SOFFIT PANEL

09/27/2024

Drawing Number:



As indicated Drawn By: Project Number:

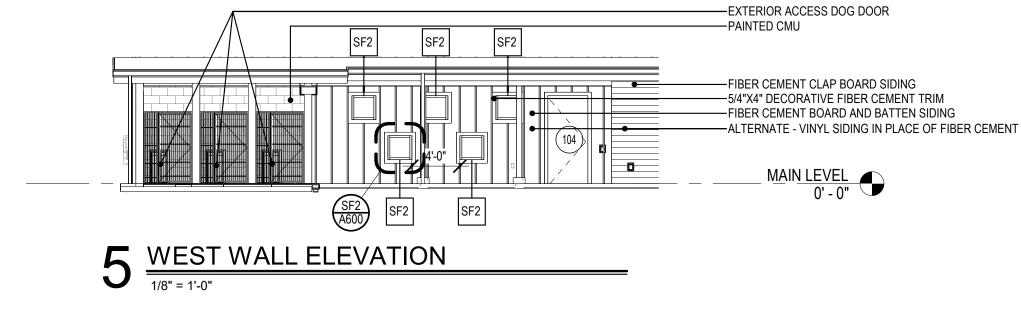


SILVER PETRUCELLI + ASSOCIATES

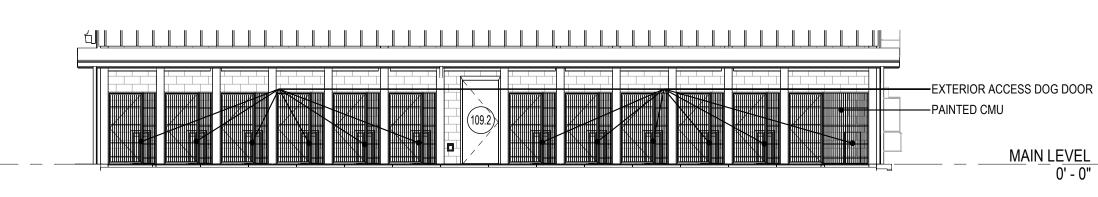
ISSUED FOR BID

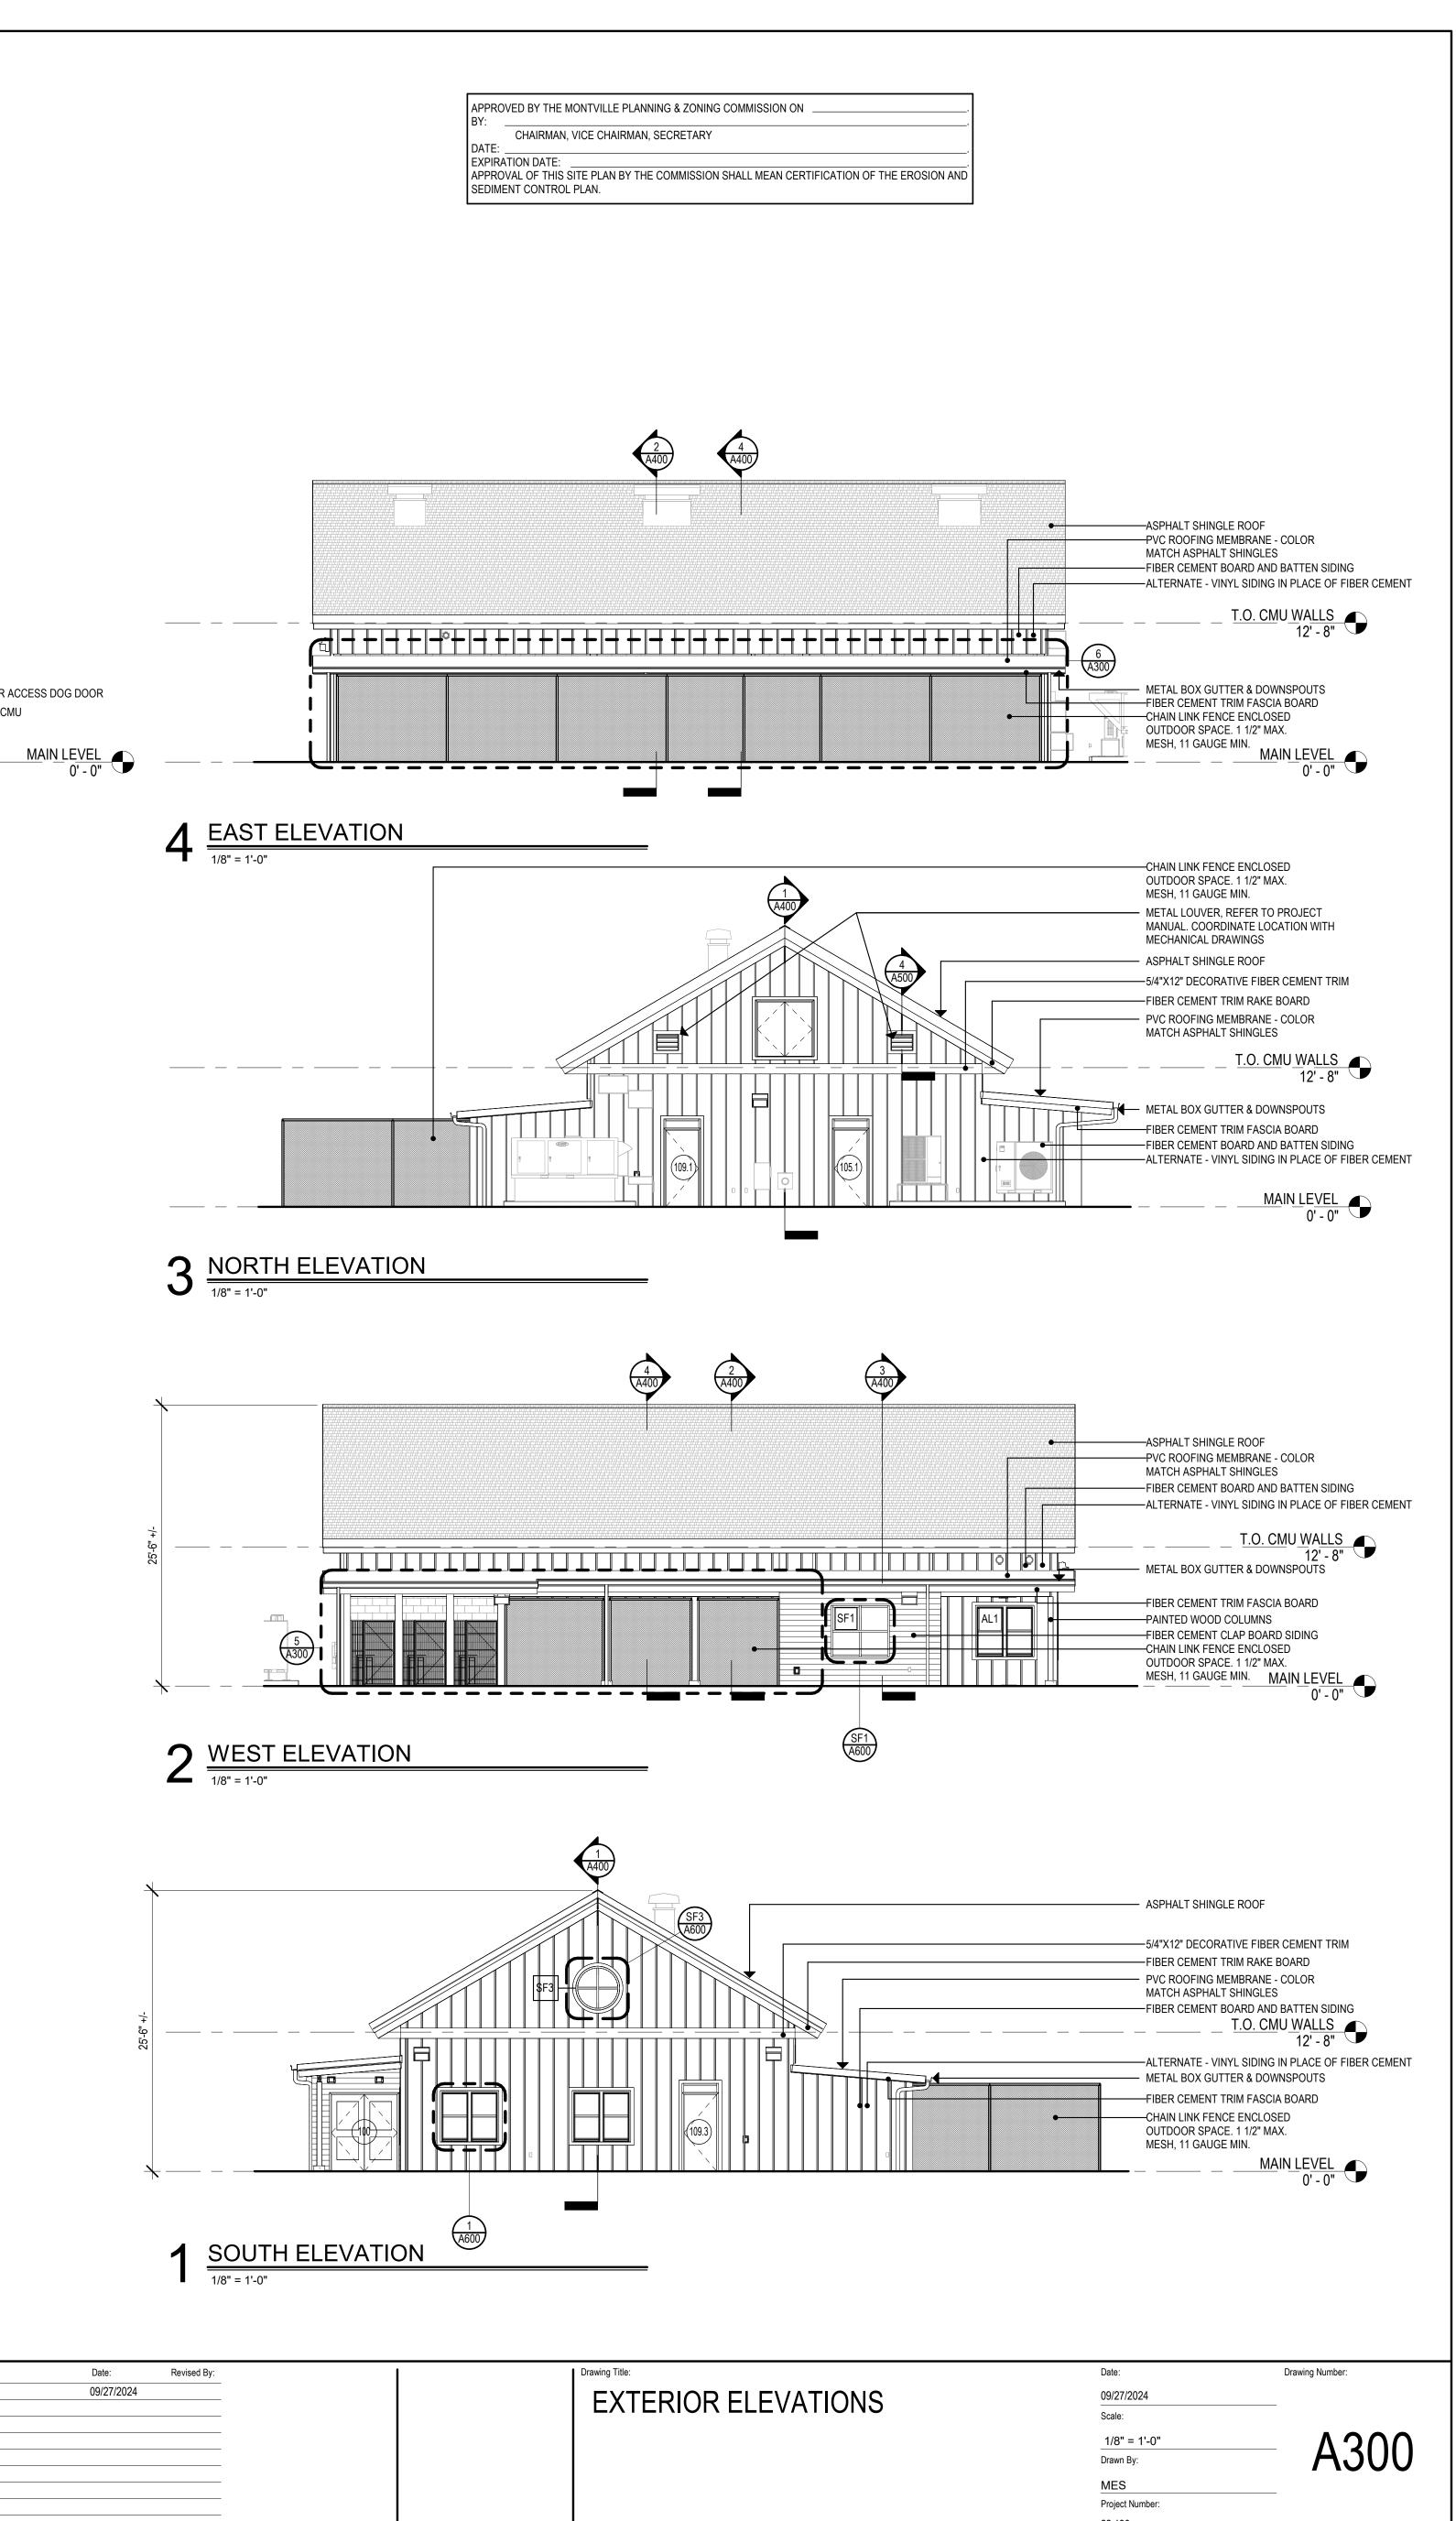
3190 WHITNEY AVENUE HAMDEN CT 06518 311 STATE STREET NEW LONDON CT 06320203 230 9007silverpetrucelli.com

Description: Revision:



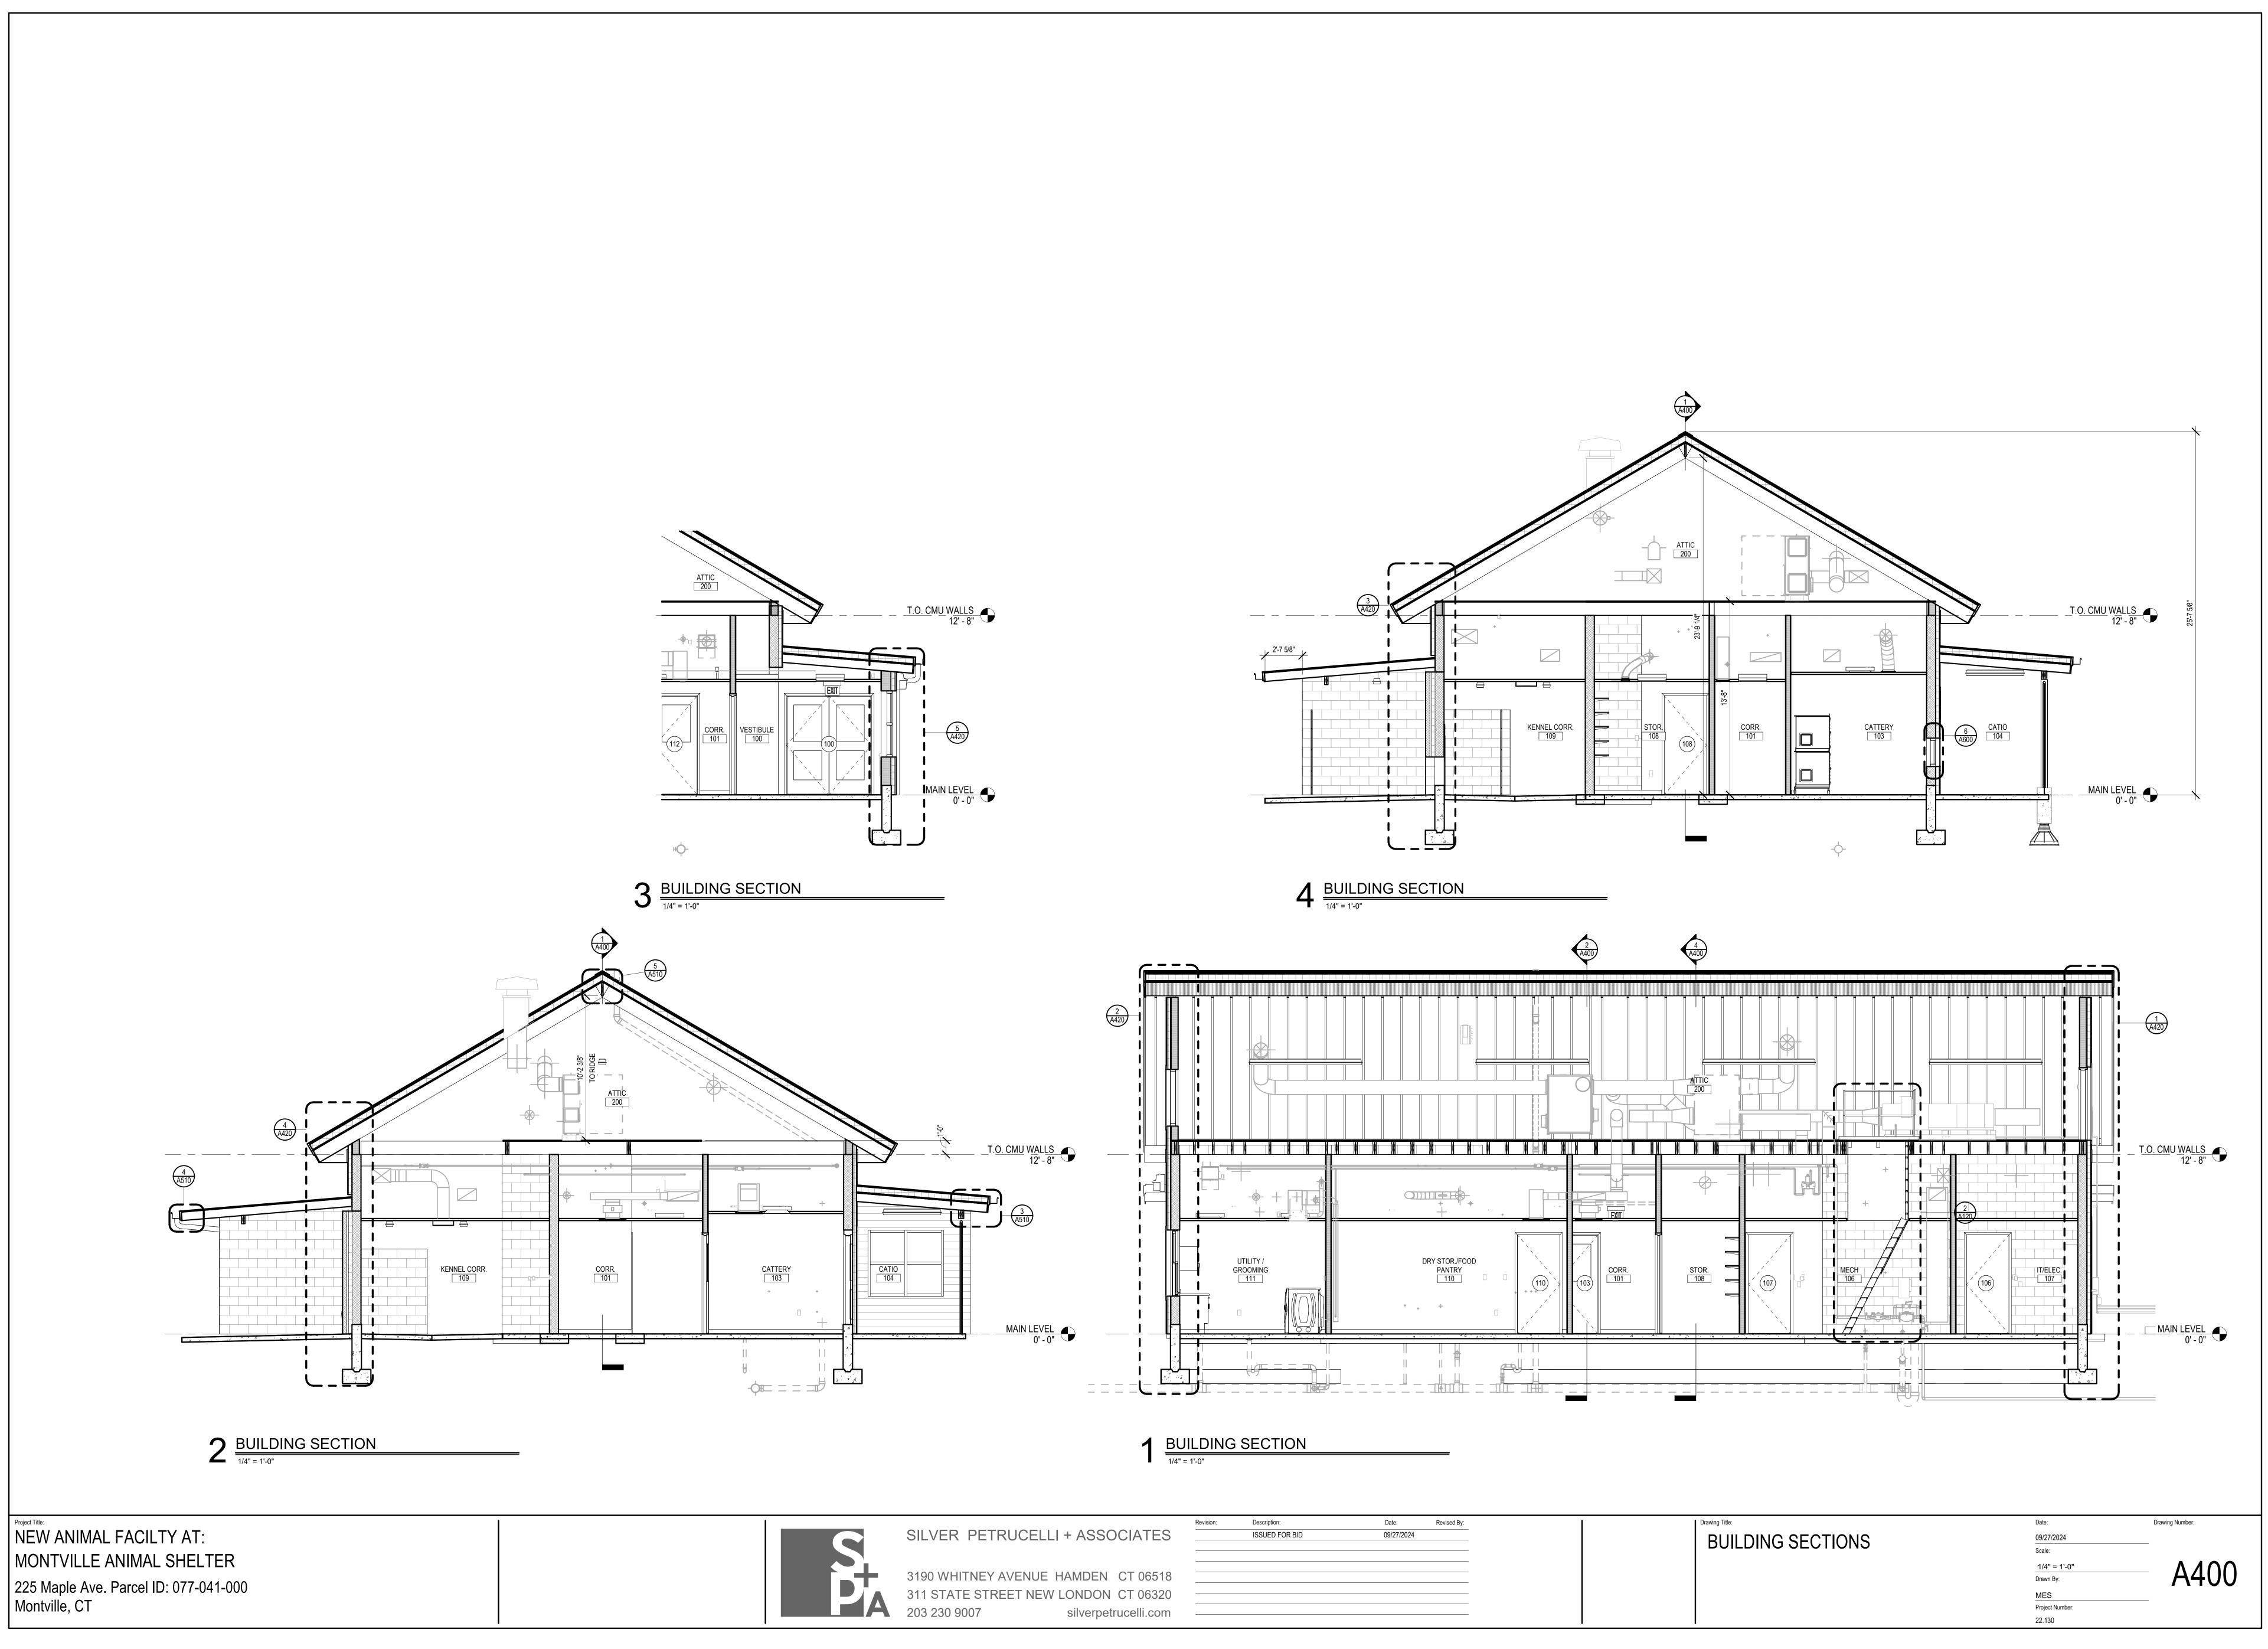
 $6 \frac{\text{EAST WALL ELEVATION}}{\frac{1}{8"} = 1' - 0"}$



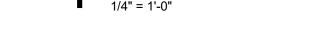


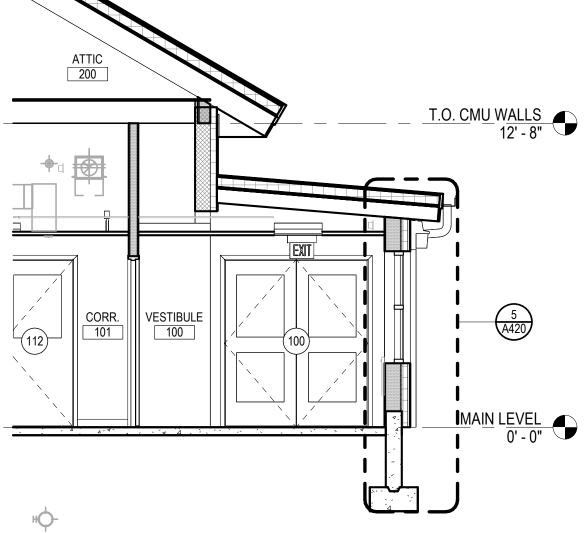
	EXTERIOR ELEVATIONS

22.130

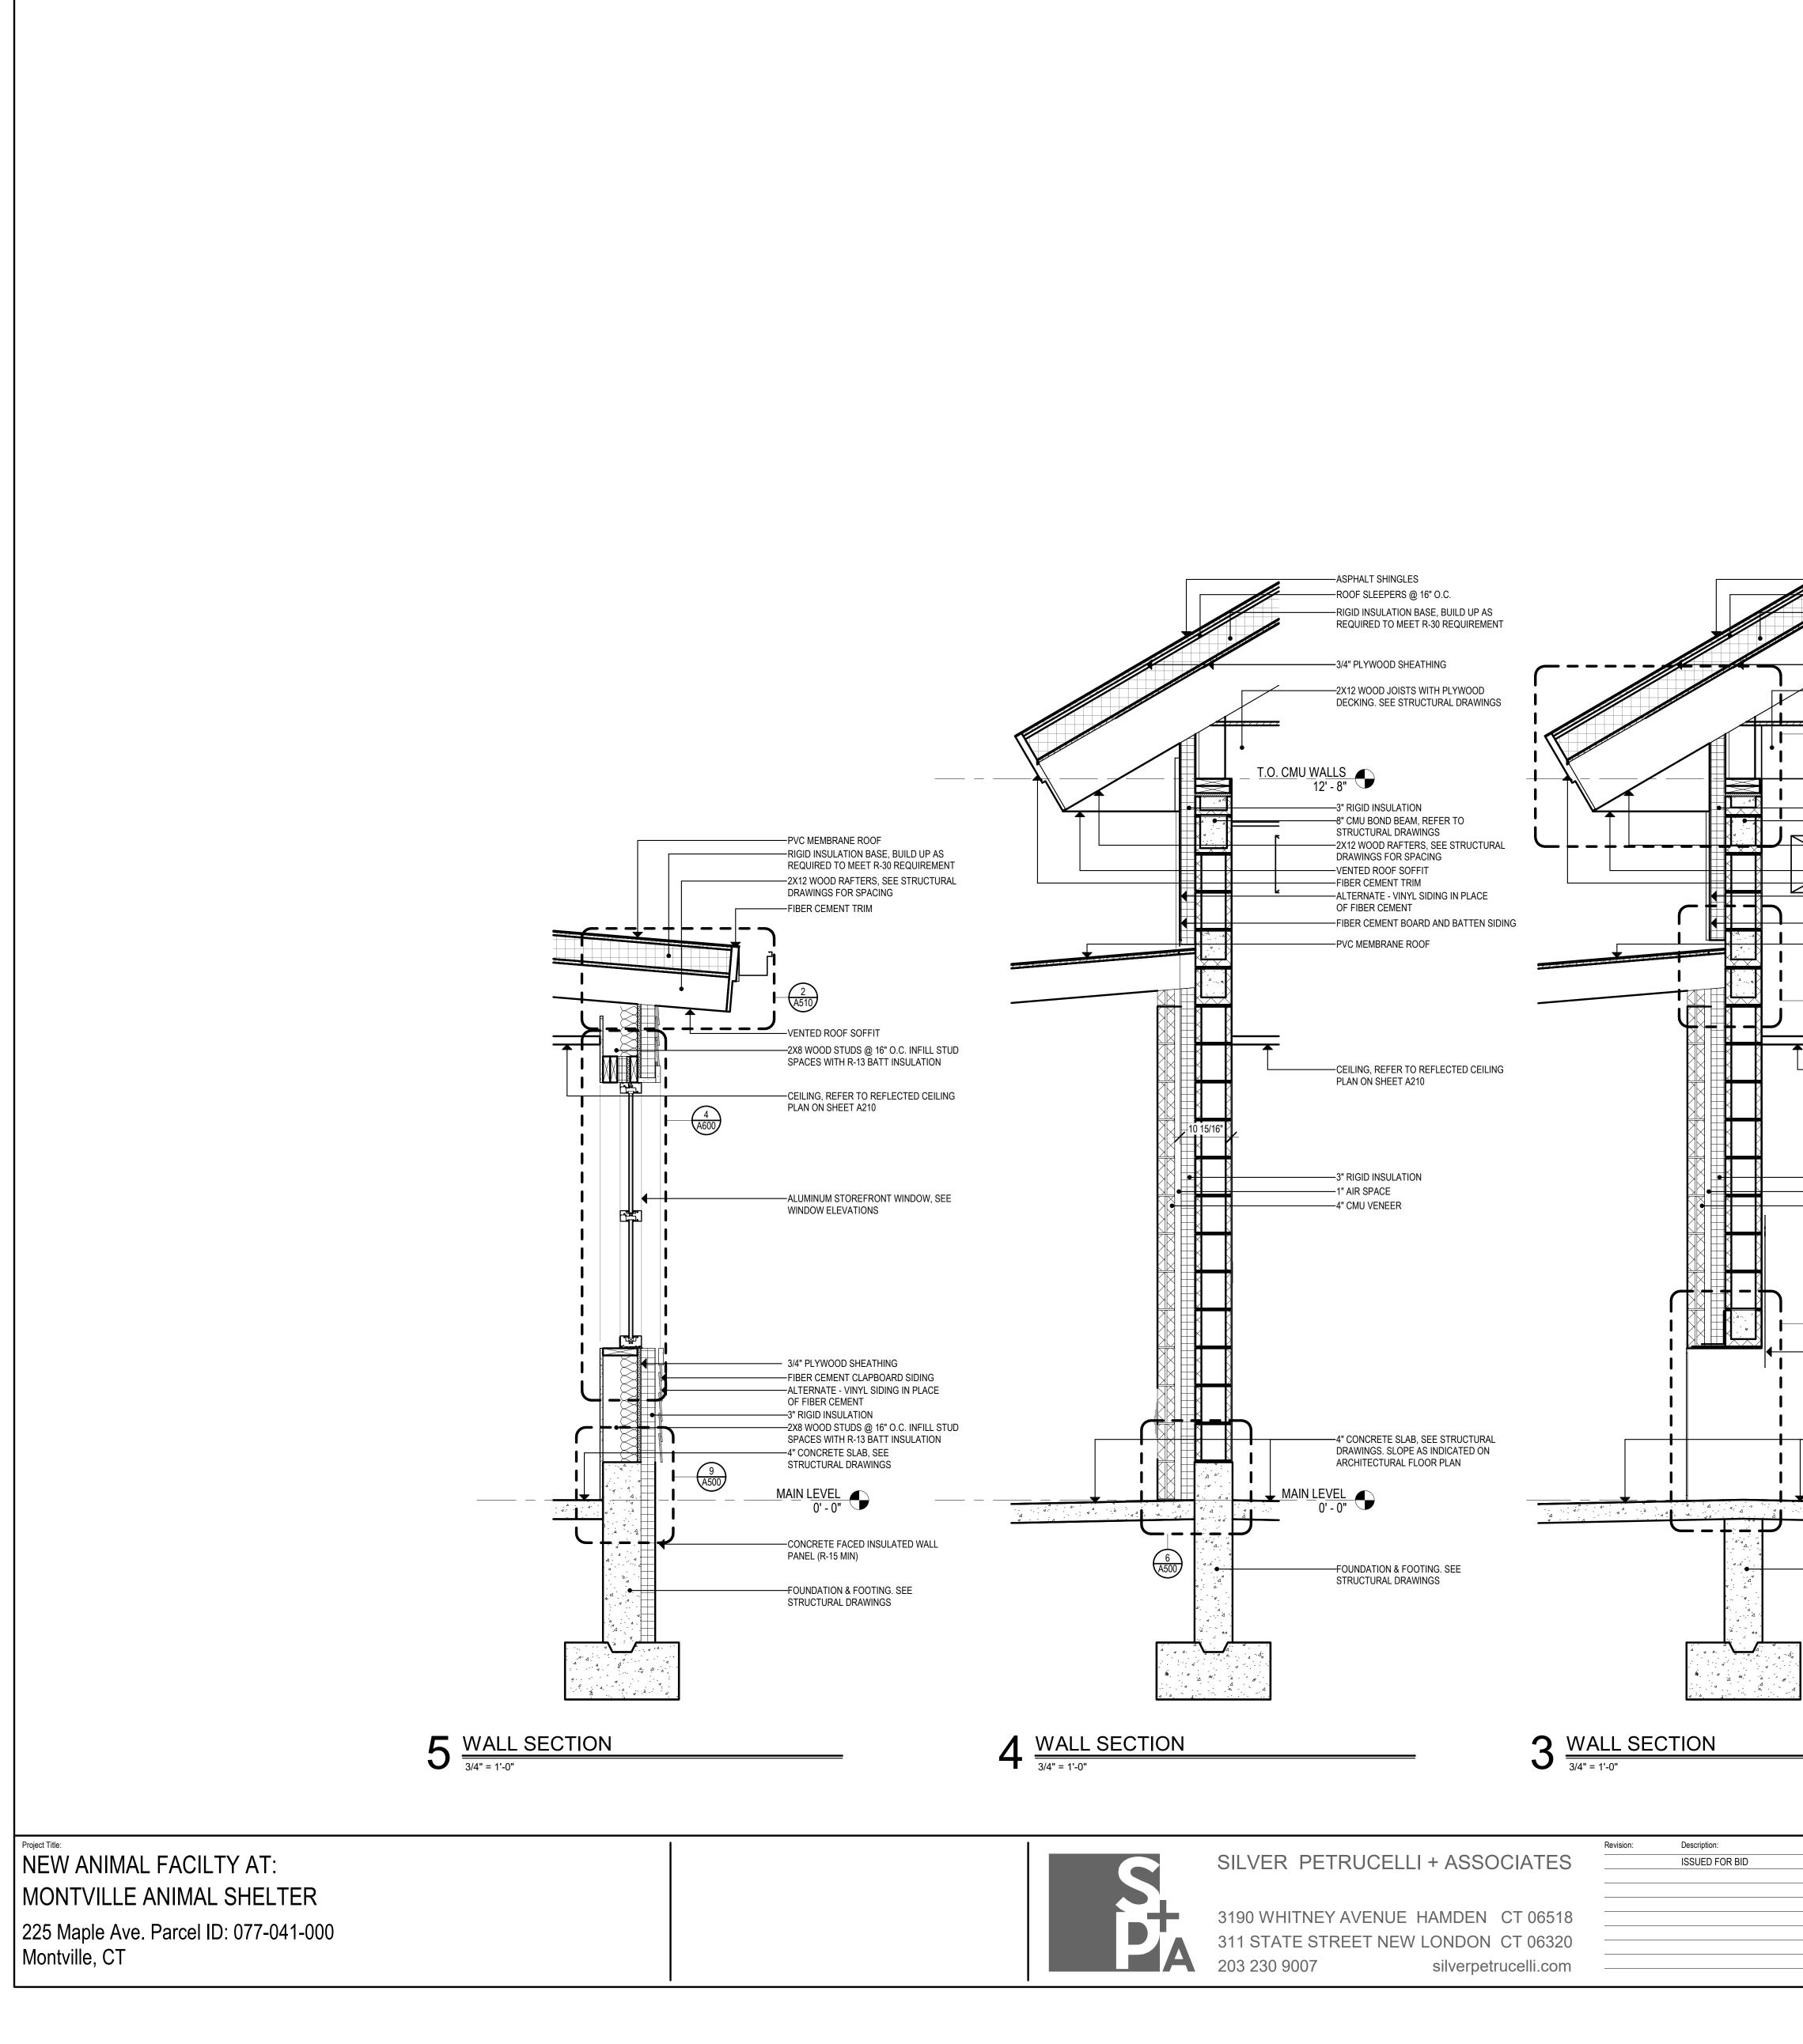








Date: Revised By:	Drawing Title:	Date:
09/27/2024	BUILDING SECTIONS	09/27/
		Scale:
		1/4"
		1/4" Drawn
		MES
		Project
		22.130



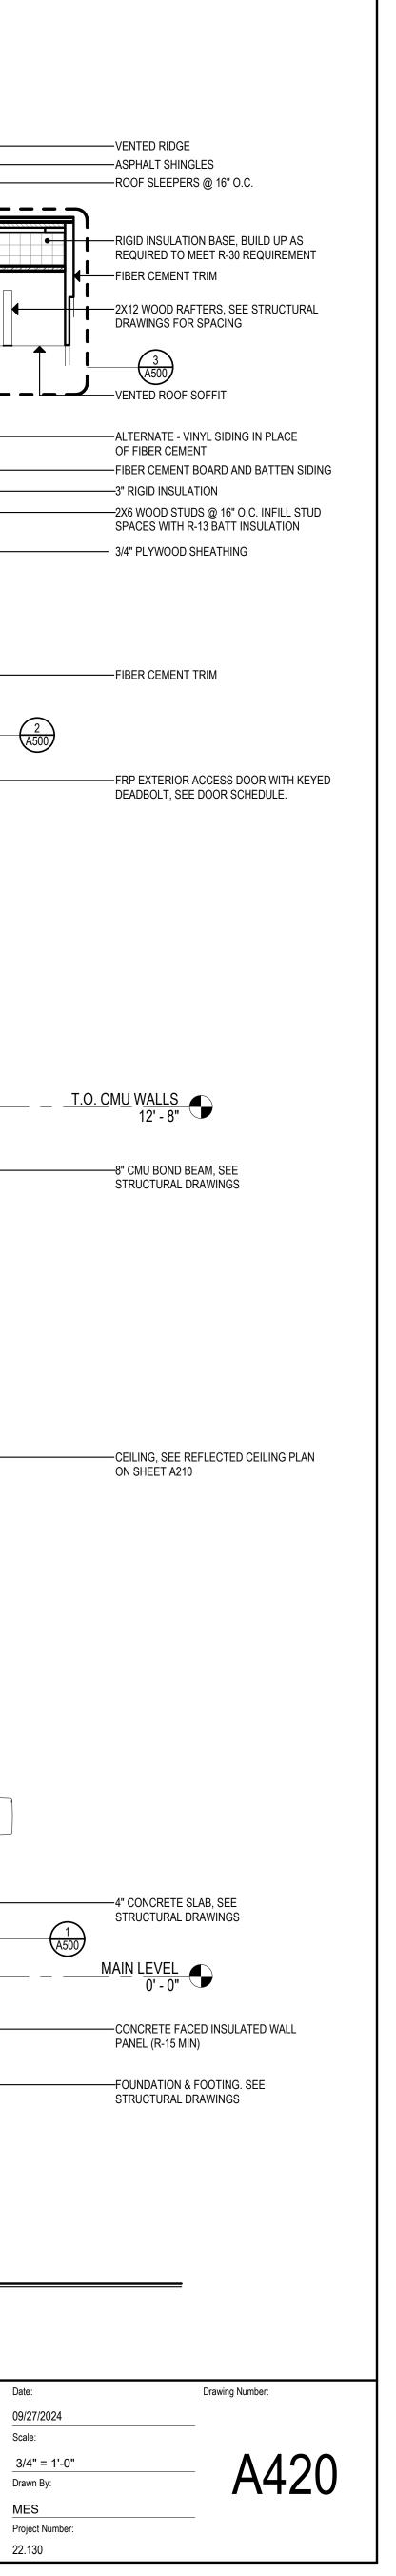


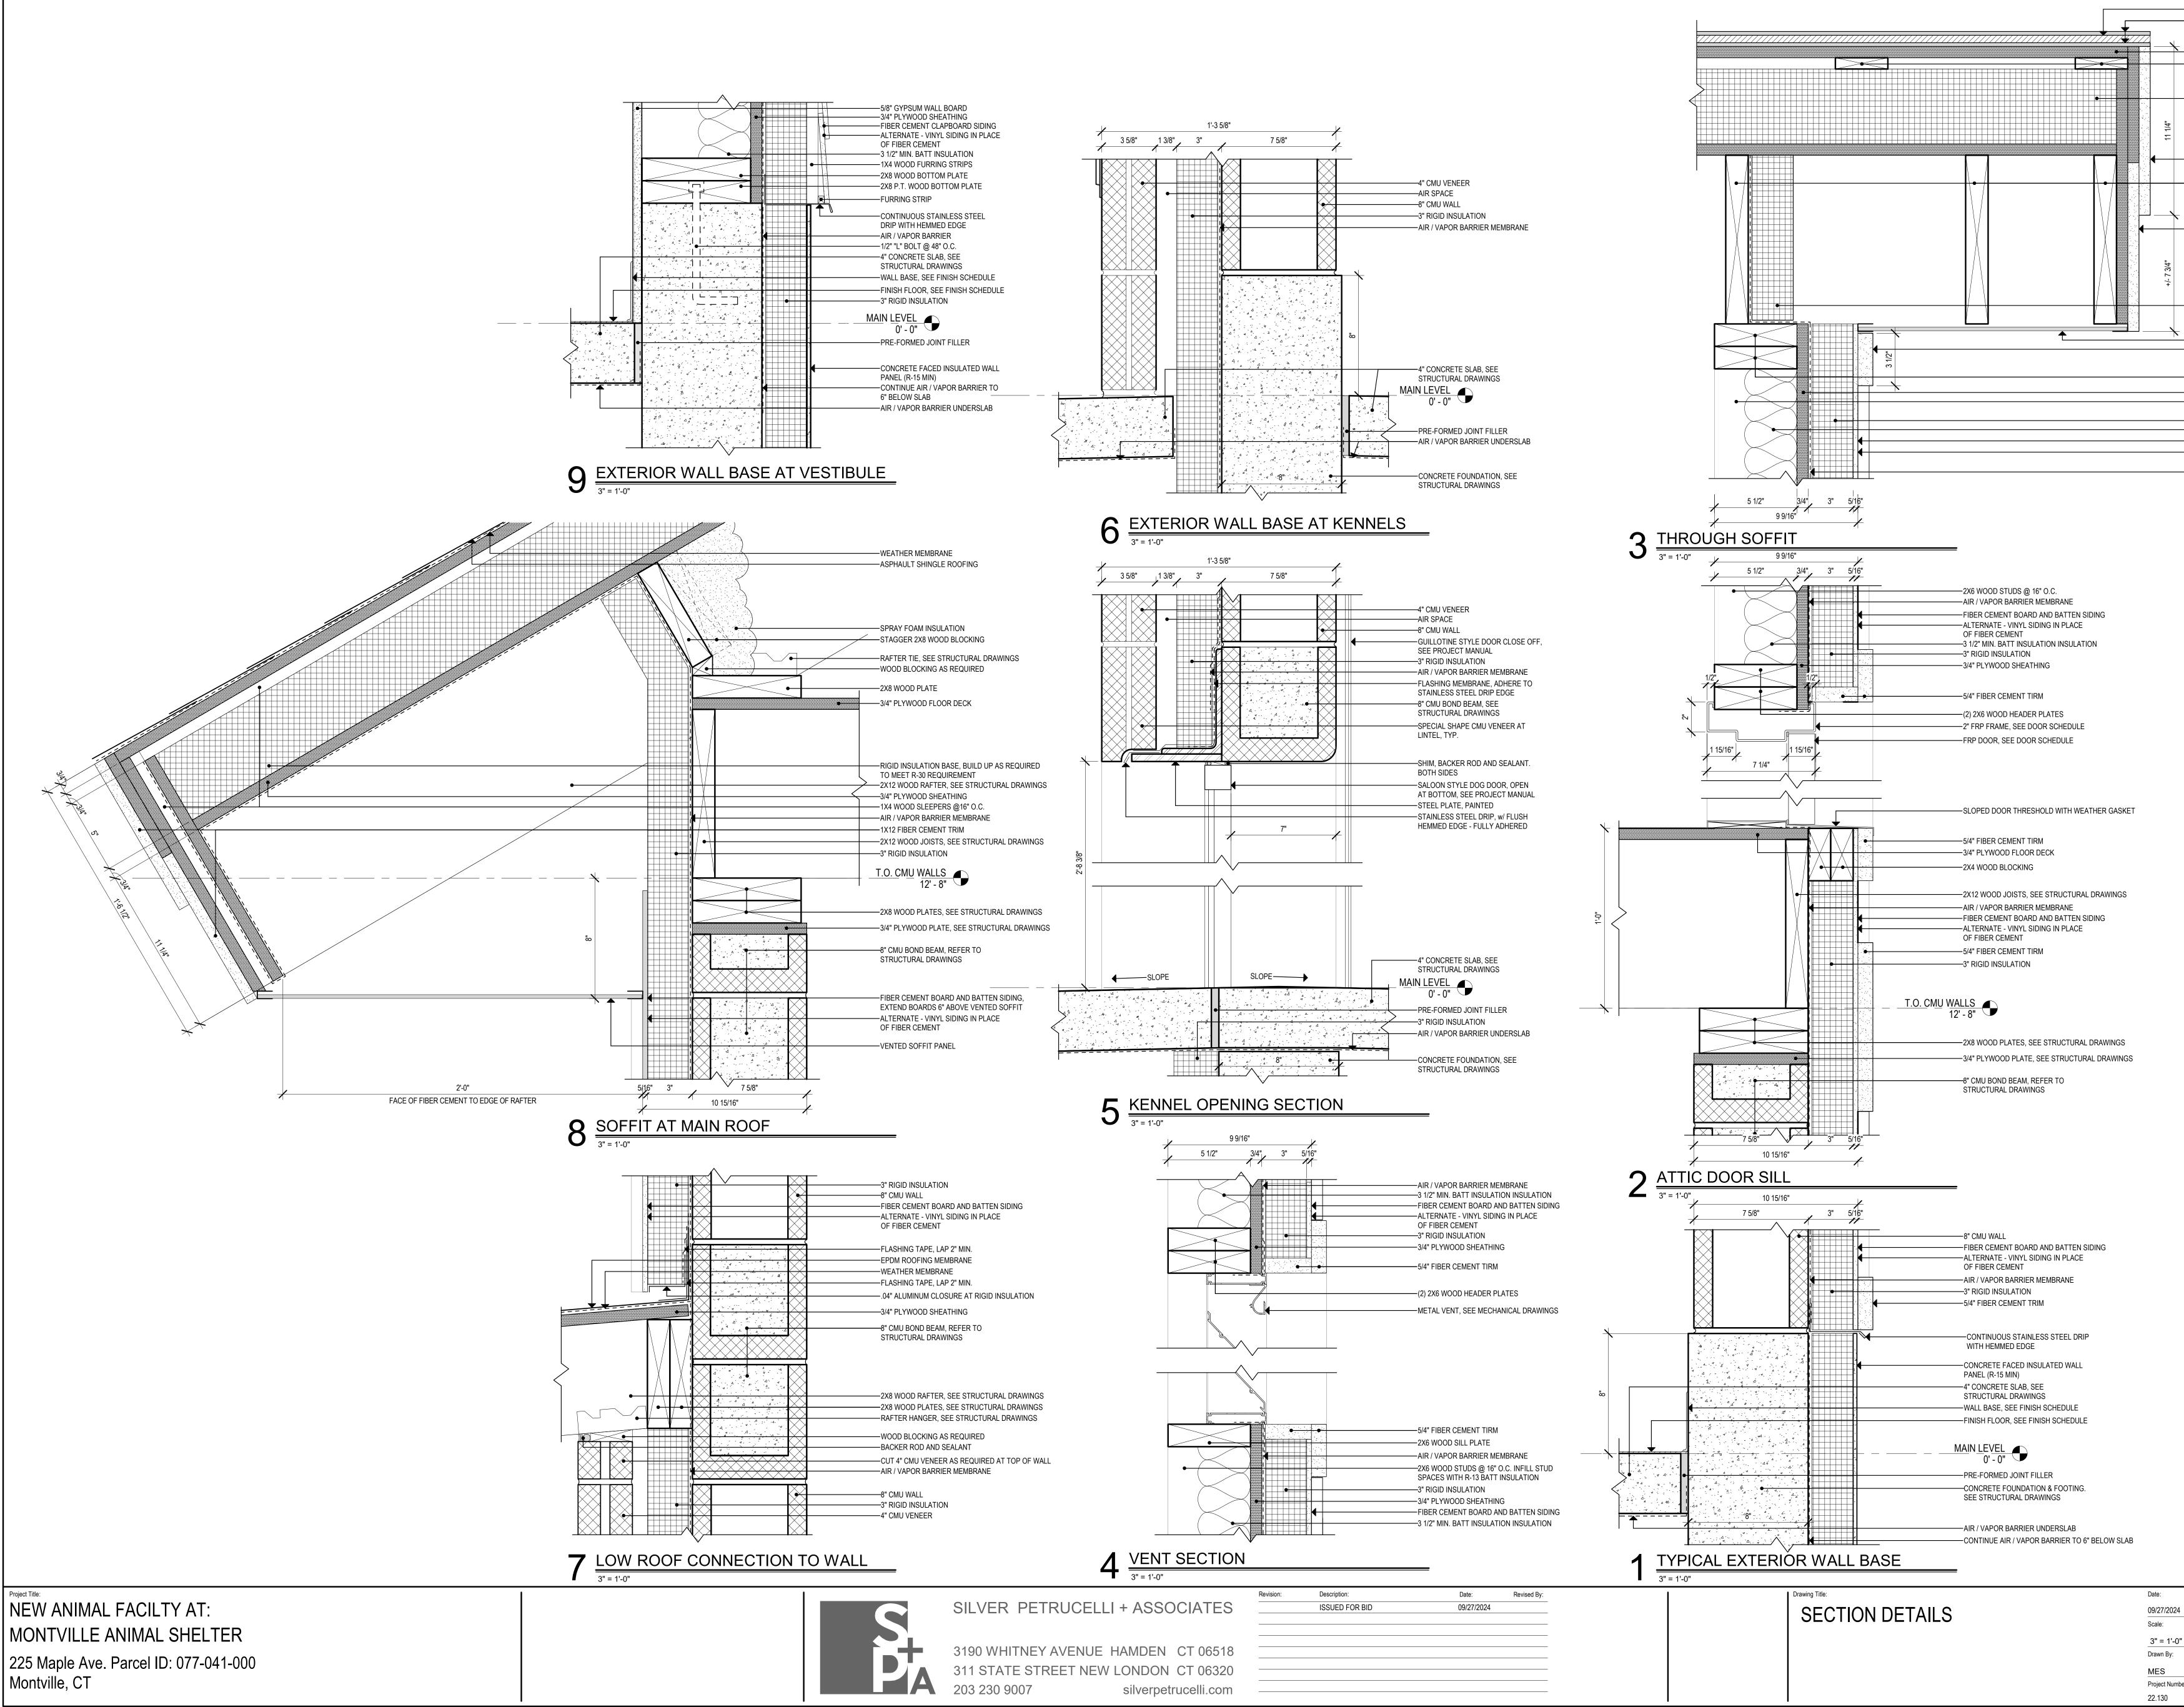
ISSUED FOR BID

		-RIGID INSULATION BASE, BUILD UP AS REQUIRED TO MEET R-30 REQUIREMENT	
		—FIBER CEMENT TRIM —2X12 WOOD RAFTERS, SEE STRUCTURAL DRAWINGS FOR SPACING	
Π		 VENTED ROOF SOFFIT ALTERNATE - VINYL SIDING IN PLACE OF FIBER CEMENT FIBER CEMENT BOARD AND BATTEN SIDING 3" RIGID INSULATION 2X6 WOOD STUDS @ 16" O.C. INFILL STUD SPACES WITH R-13 BATT INSULATION - 3/4" PLYWOOD SHEATHING 	
		—FIBER CEMENT TRIM	
ASPHALT SHINGLES ROOF SLEEPERS @ 16" O.C. RIGID INSULATION BASE, BUILD UP AS REQUIRED TO MEET R-30 REQUIREMENT		—ALUMINUM STOREFRONT WINDOW, SEE WINDOW ELEVATIONS	
3/4" PLYWOOD SHEATHING 2X12 WOOD JOISTS WITH PLYWOOD DECKING. SEE STRUCTURAL DRAWINGS T.O. CMU WALLS 12' - 8" 3" RIGID INSULATION 8" CMU BOND BEAM, REFER TO STRUCTURAL DRAWINGS 2X12 WOOD RAFTERS, SEE STRUCTURAL DRAWINGS FOR SPACING VENTED ROOF SOFFIT FIBER CEMENT TRIM ALTERNATE - VINYL SIDING IN PLACE OF FIBER CEMENT FIBER CEMENT BOARD AND BATTEN SIDING		O. CMU WALLS 12' - 8" 8" CMU BOND BEAM, SEE STRUCTURAL DRAWINGS	
PVC MEMBRANE ROOF		CEILING, SEE REFLECTED CEILING PLAN ON SHEET A210 ALUMINUM FRAME DOUBLEHUNG WINDOW, SEE WINDOW ELEVATIONS	
4" CMU VENEER		-4" CONCRETE SLAB, SEE STRUCTURAL DRAWINGS MAIN LEVEL 0' - 0"	
FOUNDATION & FOOTING. SEE STRUCTURAL DRAWINGS		CONCRETE FACED INSULATED WALL PANEL (R-15 MIN) FOUNDATION & FOOTING. SEE STRUCTURAL DRAWINGS	
<u>2 WALL 3</u> 3/4" = 1'-0"	SECTION	1 WALL 3/4" = 1'-0"	SECTION
Date: Revised By: 09/27/2024	Drawing Title:	L SECTIONS	Date 09/2 Scal <u>3/2</u> Drav

-VENTED RIDGE

—ASPHALT SHINGLES





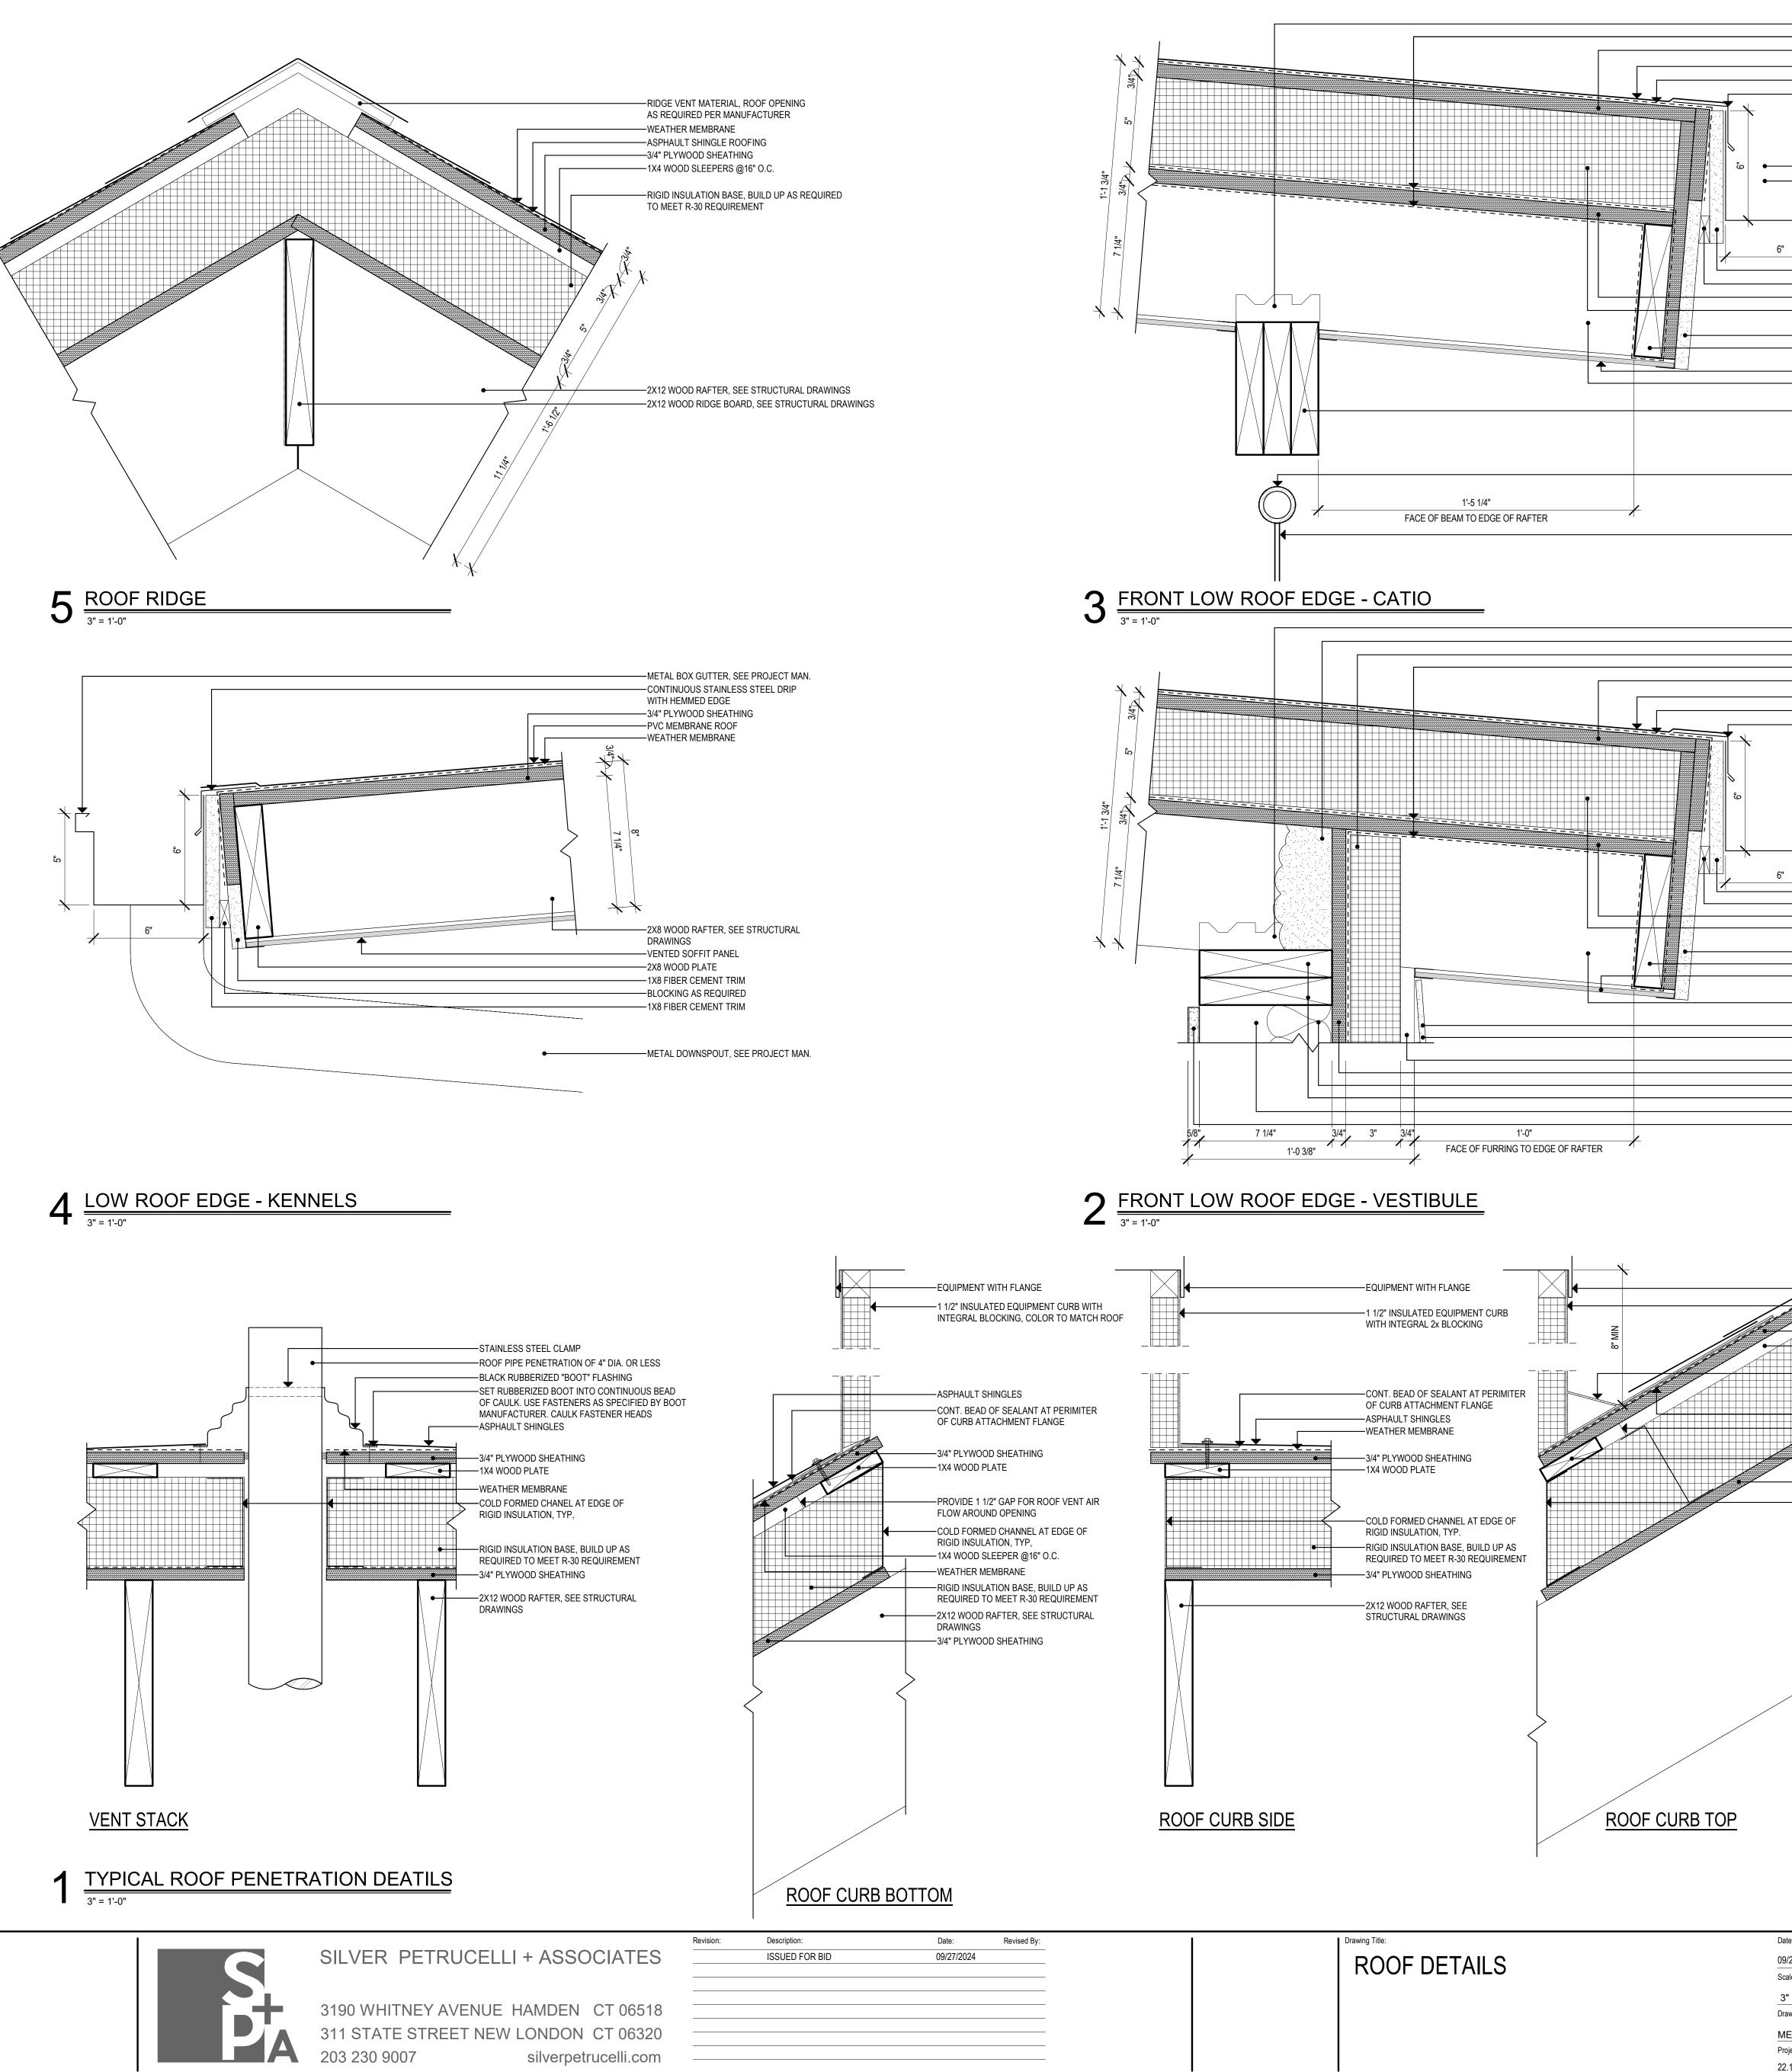
		-VENTED RIDGE -ASPHALT SHINGLES
	×	-PLYWOOD SHEATHING -ROOF SLEEPERS @ 16" O.C.
1 1/4"		-RIGID INSULATION BASE, BUILD UP AS REQUIRED TO MEET R-30 REQUIREMENT
		-1X12 FIBER CEMENT TRIM
		-2X12 WOOD RAFTERS, SEE STRUCTURAL DRAWINGS FOR SPACING
		-1X12 FIBER CEMENT TRIM
+/- 7 3/4"		
		-3" RIGID INSULATION
`	×	-VENTED ROOF SOFFIT -5/4" FIBER CEMENT TRIM
		-2X6 WOOD TOP PLATES
		-3/4" PLYWOOD SHEATHING -2X6 WOOD STUDS @ 16" O.C. INFILL STUD SPACES WITH R-13 BATT INSULATION -3" RIGID INSULATION -3 1/2" MIN. BATT INSULATION INSULATION -FIBER CEMENT BOARD AND BATTEN SIDING -ALTERNATE - VINYL SIDING IN PLACE OF FIBER CEMENT -AIR / VAPOR BARRIER MEMBRANE

09/27/2024

Drawing Number:

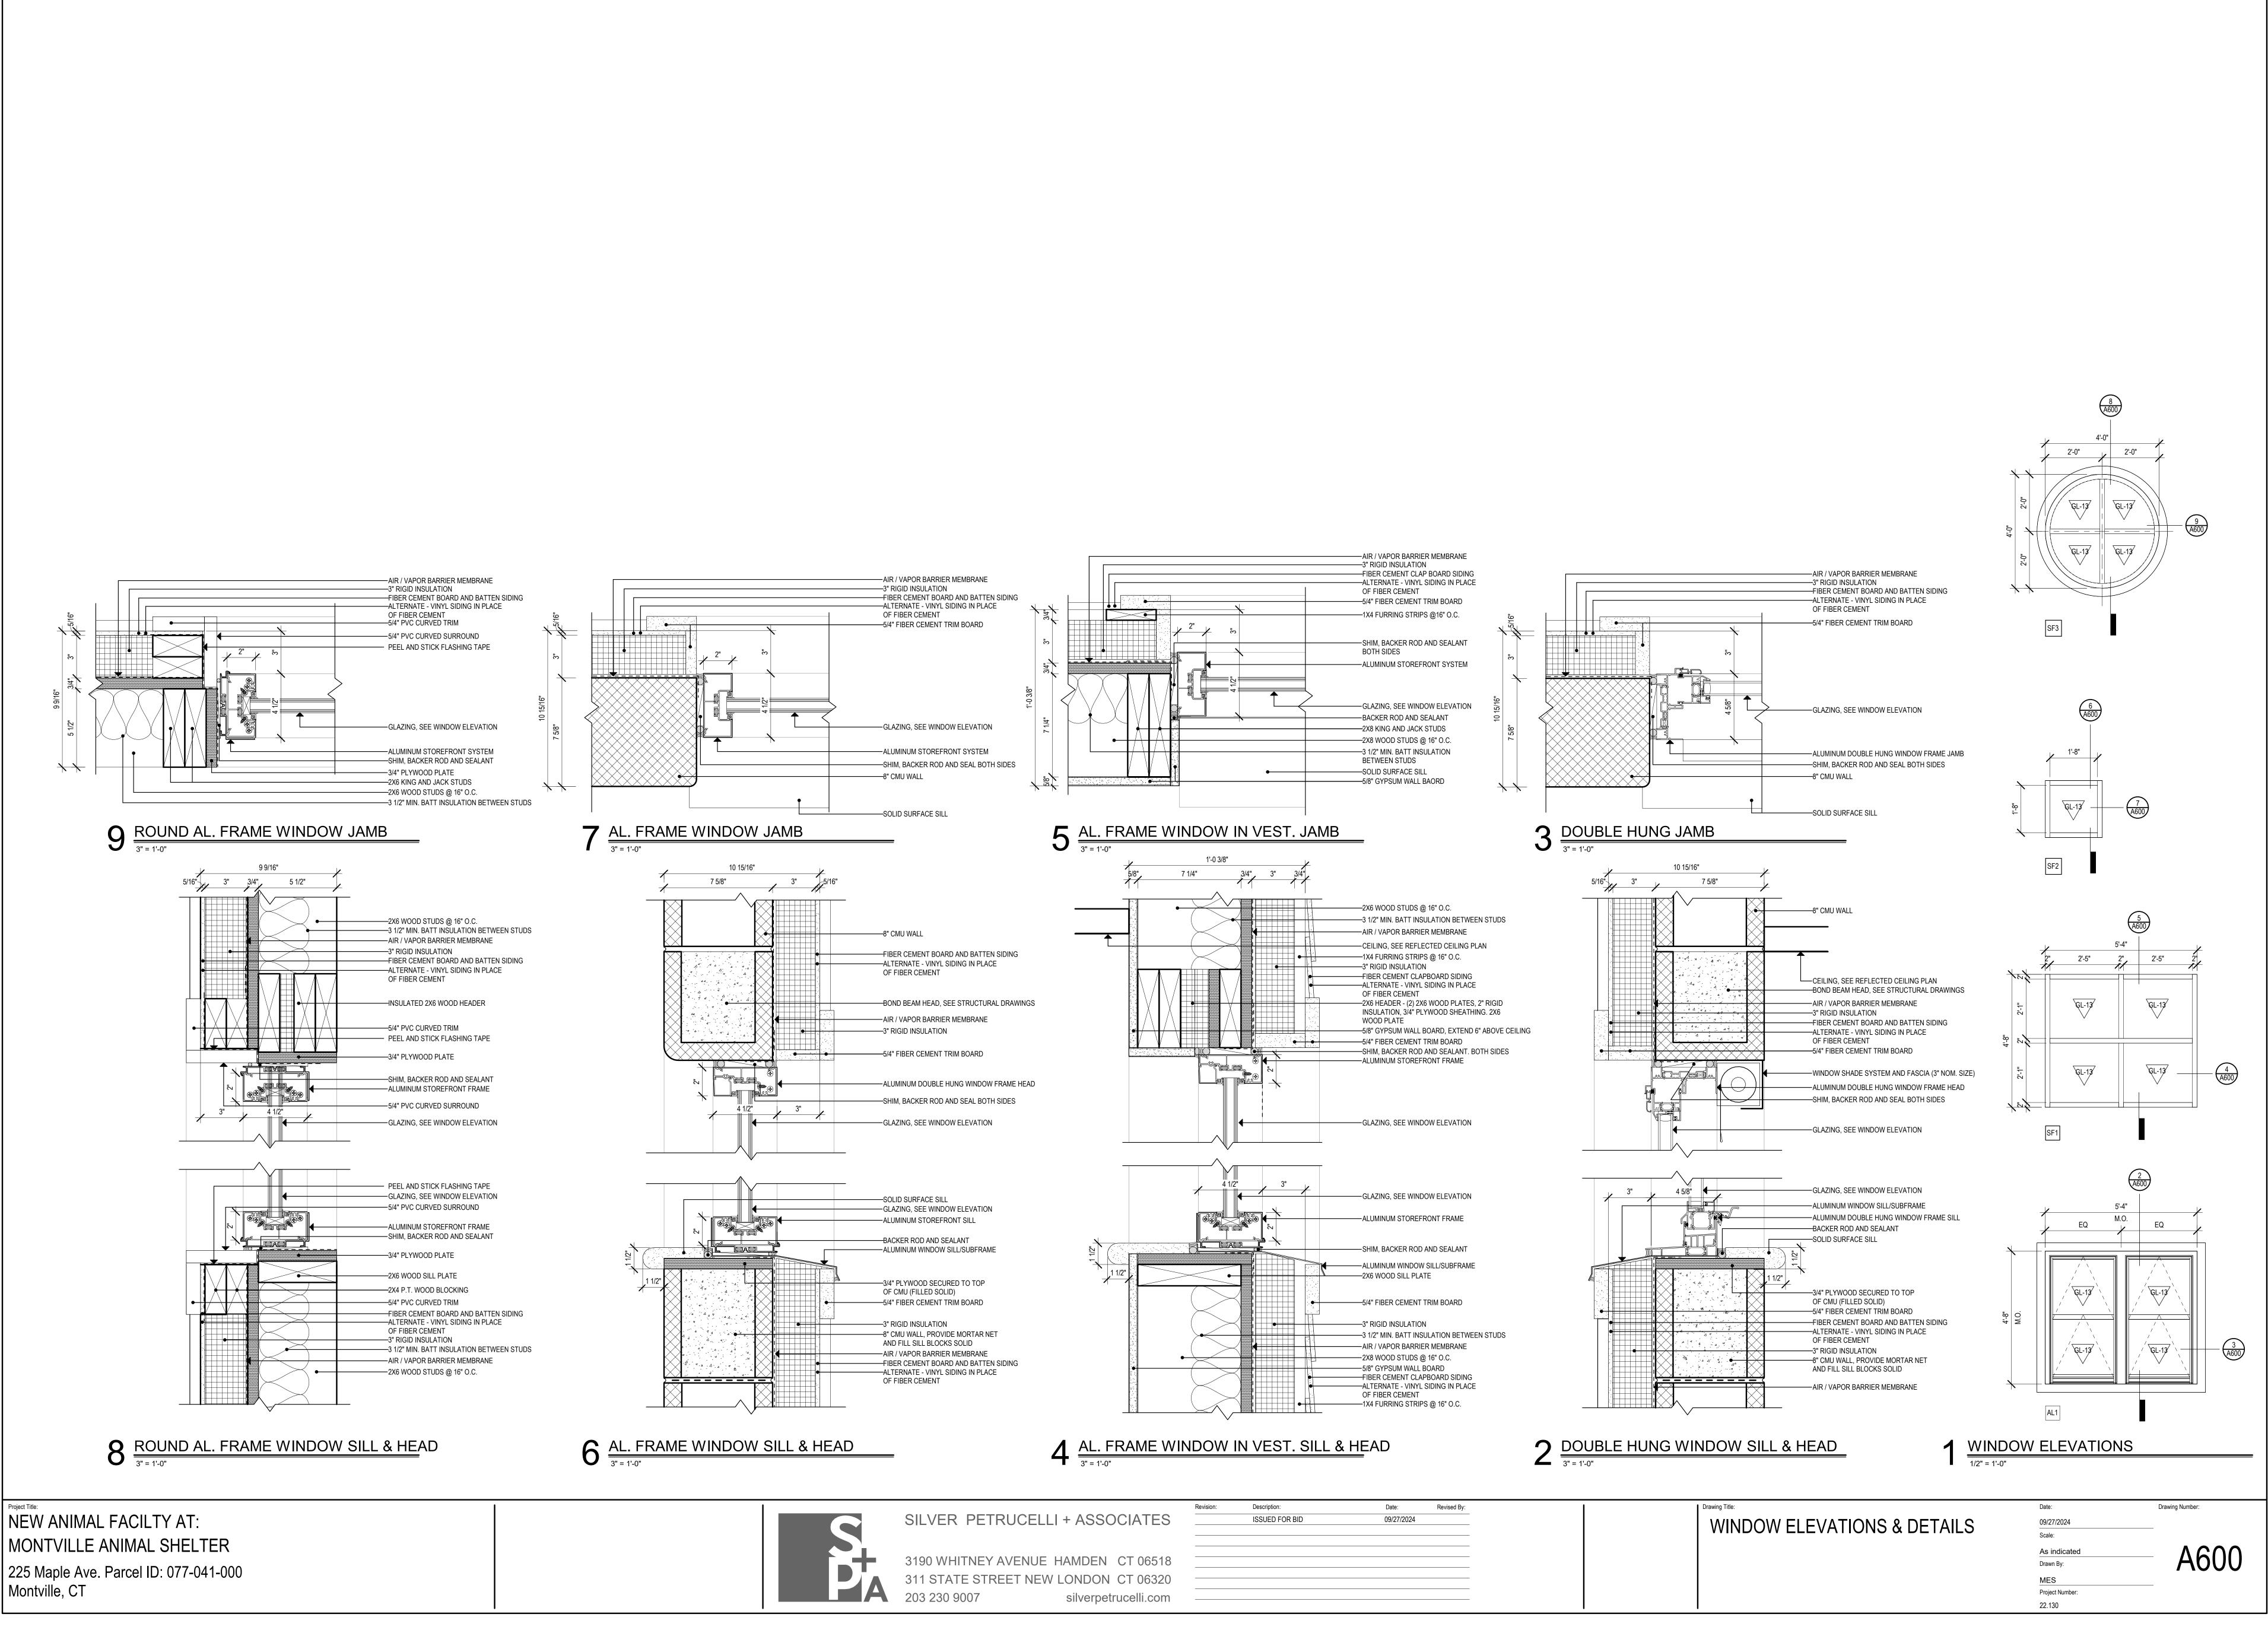


Project Number:

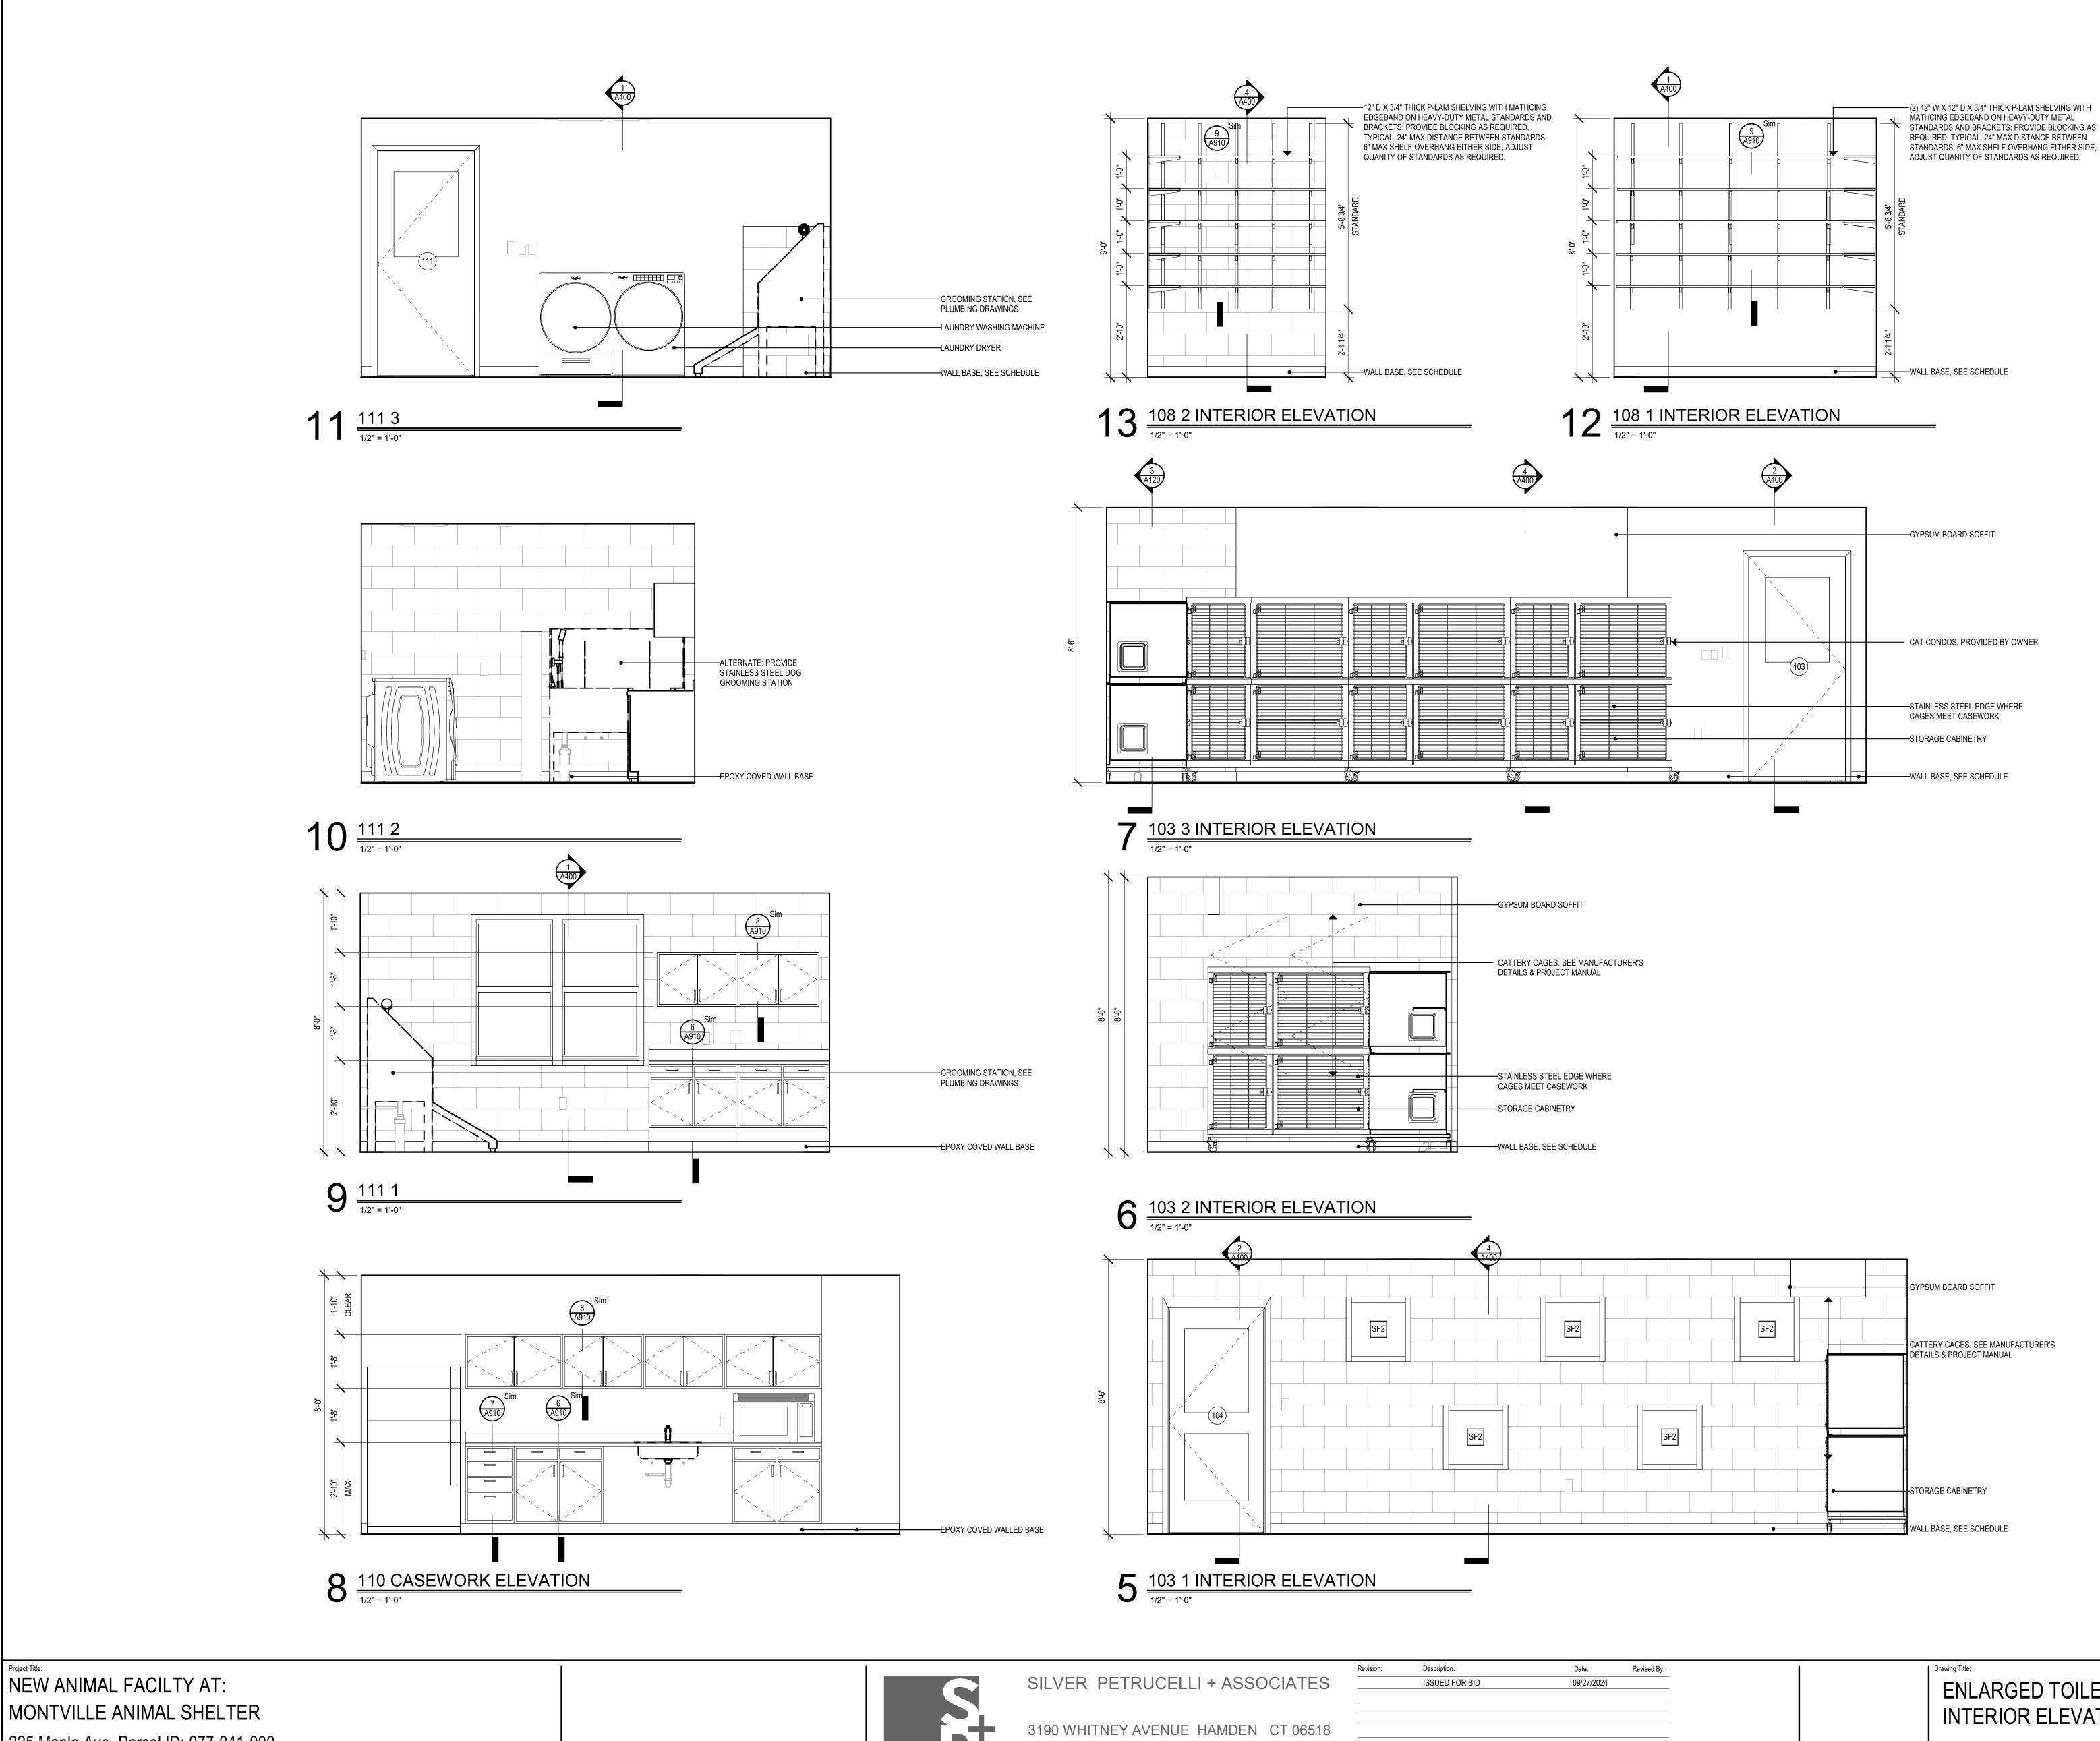


Date:	Revised By:	I	Drawing Title:	Date:
09/27/2024			ROOF DETAILS	09/27. Scale:
				<u> </u>
				MES Project 22.13

	-RAFTER TIE, SEE STRUCTURAL DRAWINGS
	-AIR / VAPOR BARRIER MEMBRANE -3/4" PLYWOOD SHEATHING
	-PVC MEMBRANE ROOF
	-WEATHER MEMBRANE -CONTINUOUS STAINLESS STEEL DRIP
	WITH HEMMED EDGE —METAL BOX GUTTER, SEE PROJECT MAN.
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o [‡]	
	-1X4 WOOD SLEEPER @16" O.C.
/	-1X8 FIBER CEMENT TRIM
	-BLOCKING AS REQUIRED -3/4" PLYWOOD SHEATHING
	-RIGID INSULATION BASE, BUILD UP AS REQUIRED TO MEET R-30 REQUIREMENT
	-1X8 FIBER CEMENT TRIM
	–2X8 WOOD PLATE –VENTED SOFFIT PANEL
	-2X8 WOOD RAFTER, SEE STRUCTURAL DRAWINGS
	-2X8 WOOD PLATE BEAM, SEE STRUCTURAL DRAWINGS
	STRUCTURAL DRAWINGS
	-GALV. 2" O.D. PIPE KENNEL FRAMING
	-GALV. KENNEL CHAIN LINK FENCING, MAXIMUM 1 1/2" MESH SPACING, MINIMUM 11
	GAUGE WIRE. FOR INJURY PREVENTION, NO EXPOSED WIRE ENDS ARE PERMITTED.
	-RAFTER TIE, SEE STRUCTURAL DRAWINGS -SPRAY FOAM INSULATION
	-3" RIGID INSULATION -3" RIGID INSULATION -AIR / VAPOR BARRIER MEMBRANE
	-3/4" PLYWOOD SHEATHING
	PVC MEMBRANE ROOF WEATHER MEMBRANE
	-CONTINUOUS STAINLESS STEEL DRIP WITH HEMMED EDGE
\checkmark \checkmark	-METAL BOX GUTTER, SEE PROJECT MAN.
ភា	
	-1X8 FIBER CEMENT TRIM -BLOCKING AS REQUIRED
	REQUIRED TO MEET R-30 REQUIREMENT —1X8 FIBER CEMENT TRIM
	—2X8 WOOD PLATE —VENTED SOFFIT PANEL
	-2X8 WOOD RAFTER, SEE STRUCTURAL
	DRAWINGS —FIBER CEMENT CLAPBOARD SIDING
	-ALTERNATE - VINYL SIDING IN PLACE OF FIBER CEMENT
	-1X4 WOOD FURRING STRIPS -3/4" PLYWOOD SHEATHING
	—3 1/2" MIN. BATT INSULATION —2X8 WOOD TOP PLATE PLATES
	—2X8 WOOD STUDS @ 16" O.C. —5/8" GYPSUM WALL BOARD, EXTEND 6"
	ABOVE CEILING
r	-ASPHAULT SHINGLES
	-EQUIPMENT WITH FLANGE
	-1 1/2" INSULATED EQUIPMENT CURB WITH INTEGRAL CRICKET AND 2X BLOCKING
	—3/4" PLYWOOD SHEATHING —1X4 WOOD SLEEPER @16" O.C.
	-CRICKET
	-RIGID INSULATION BASE, BUILD UP AS REQUIRED TO MEET R-30 REQUIREMENT
	-WEATHER MEMBRANE
	-1X4 WOOD PLATE
	-3/4" PLYWOOD SHEATHING
	-COLD FORMED CHANNEL AT EDGE OF RIGID INSULATION, TYP,
•	-2X12 WOOD RAFTER, SEE STRUCTURAL DRAWINGS
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27/2024	-
le:	•
= 1'-0" vn By:	— A510
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ect Number:	
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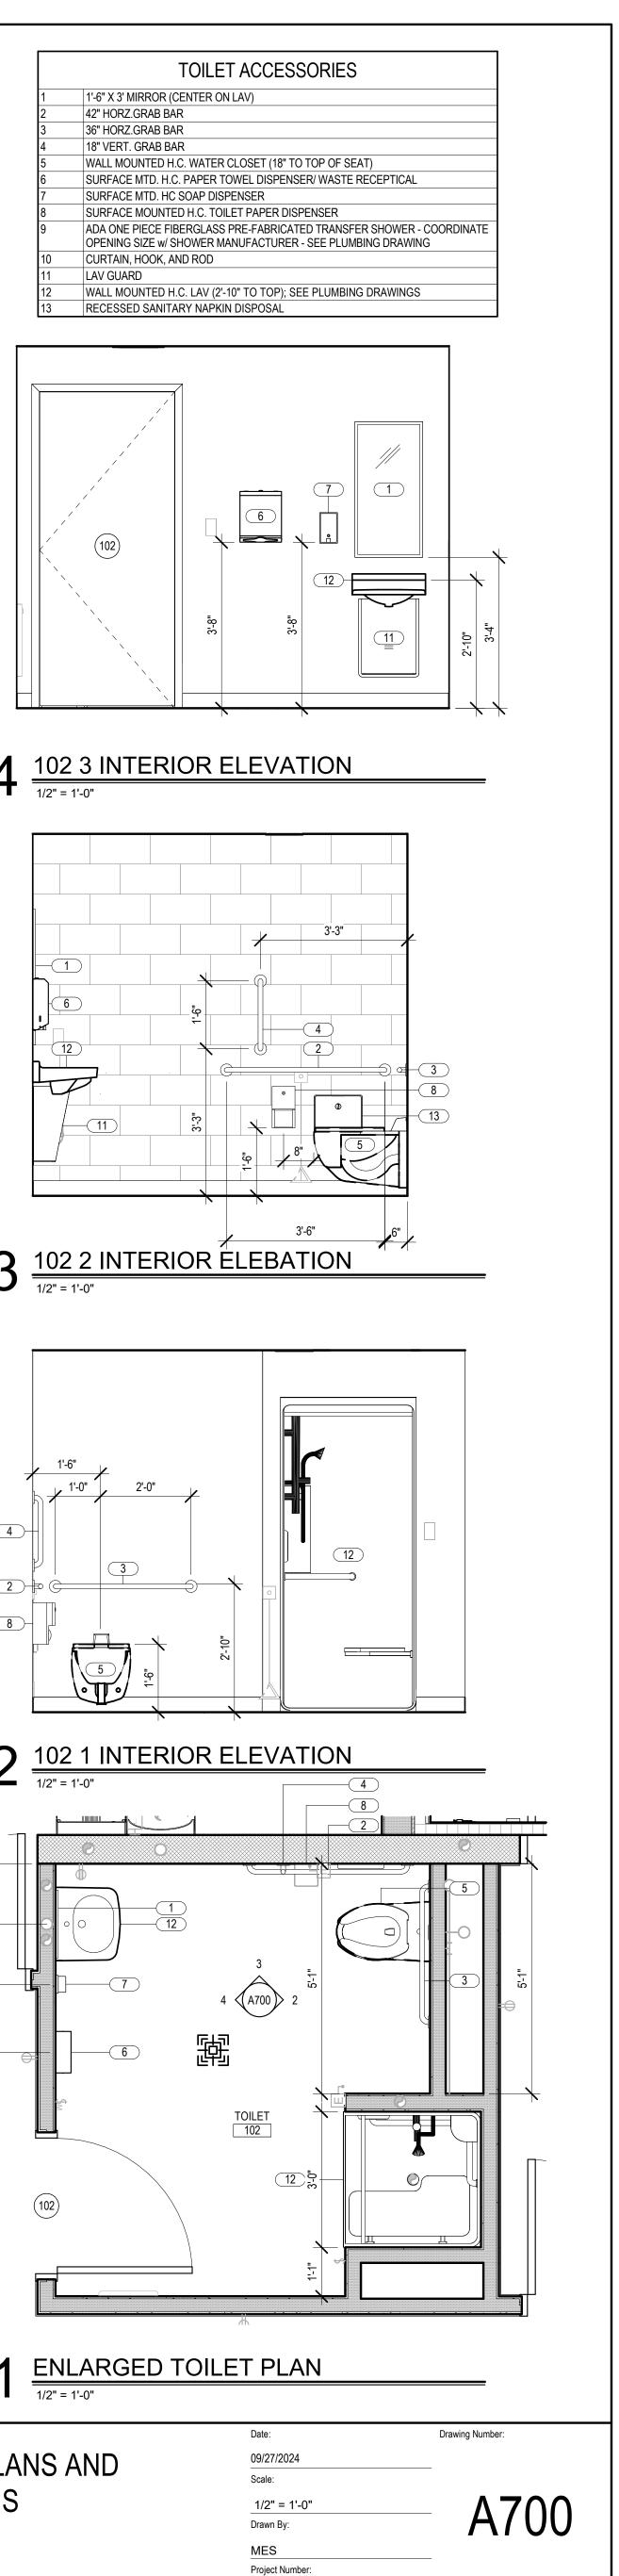
MONTVILLE ANIMAL SHELTER 225 Maple Ave. Parcel ID: 077-041-000 Montville, CT

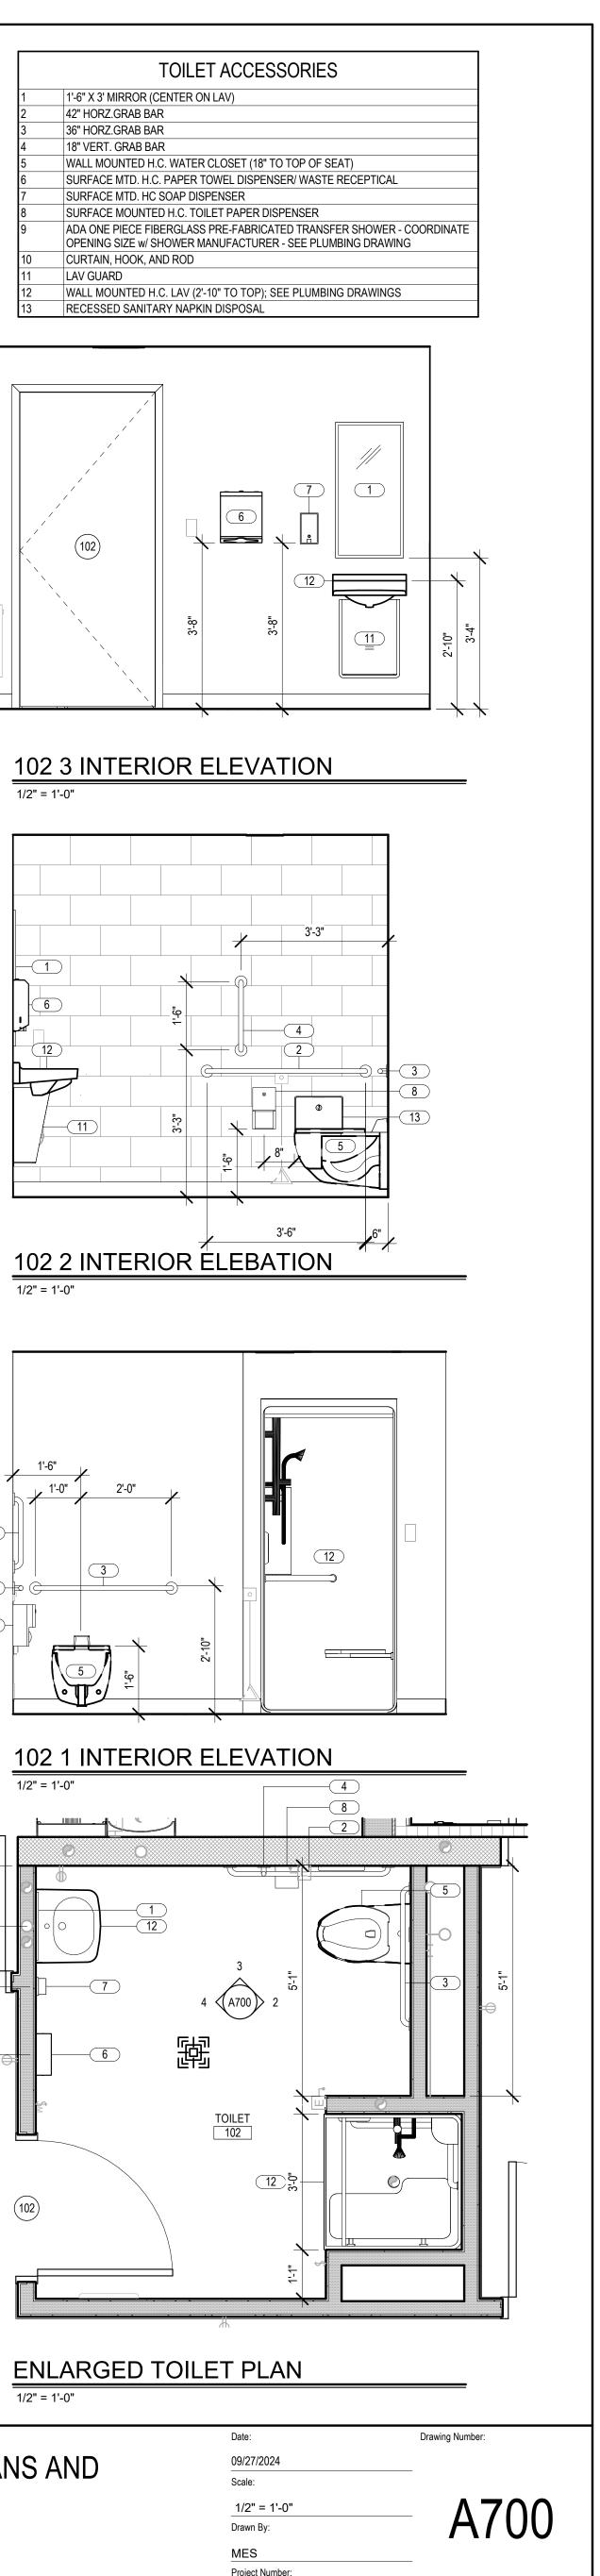


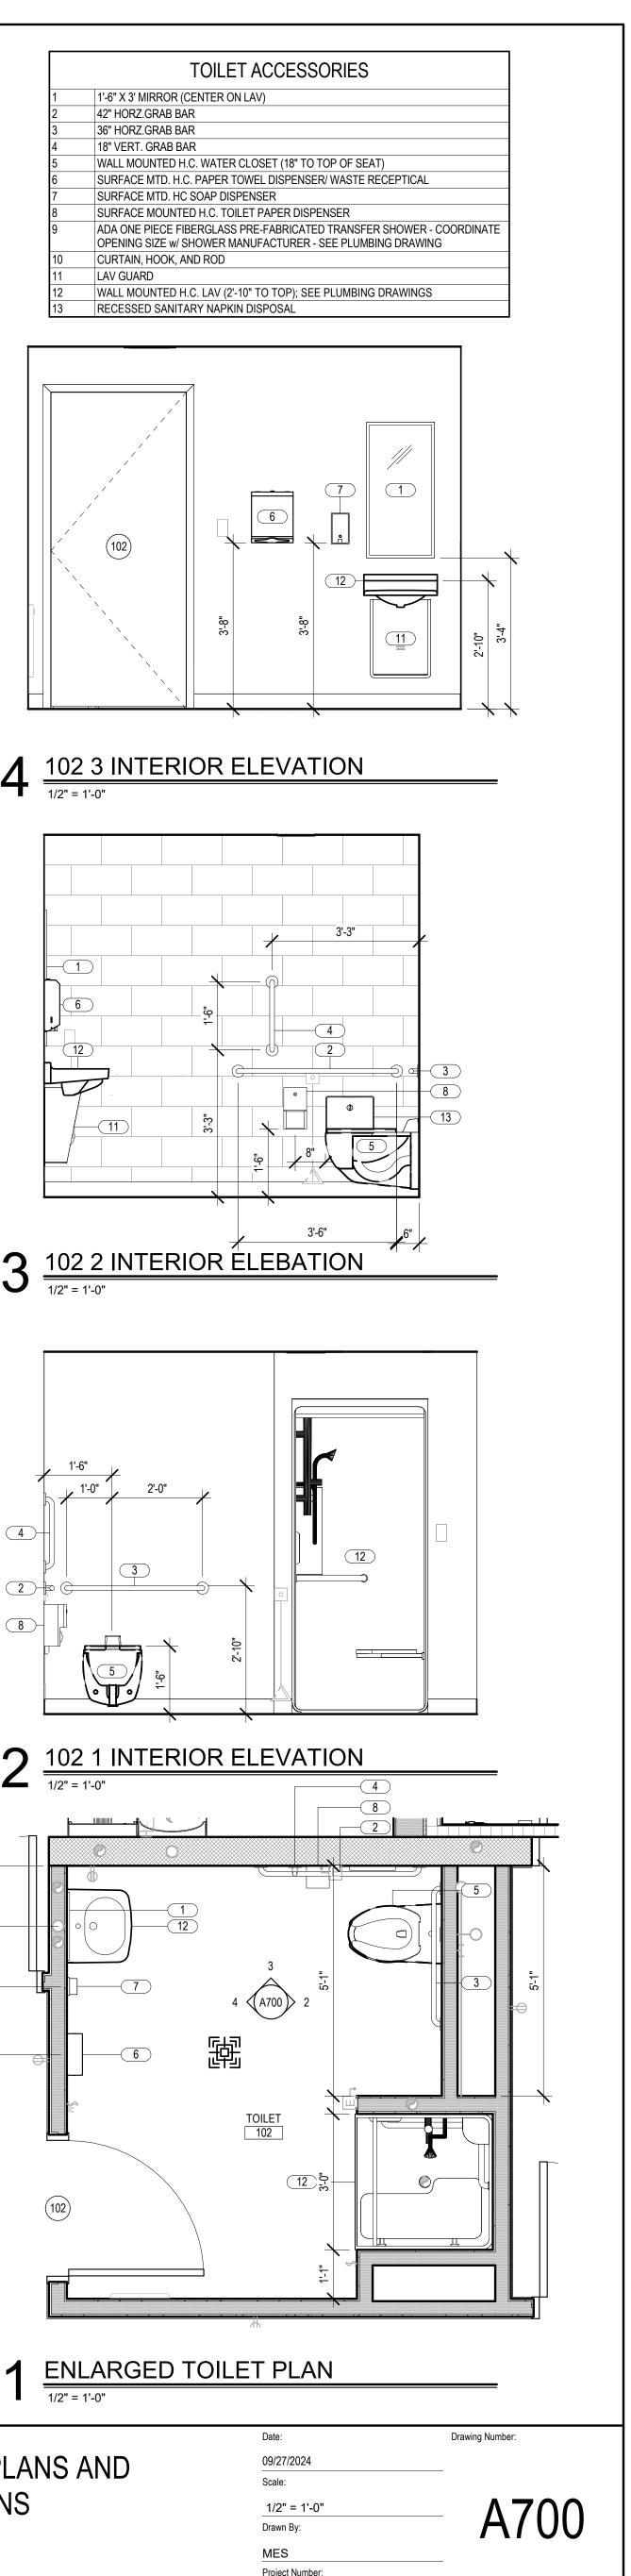
311 STATE STREET NEW LONDON CT 06320

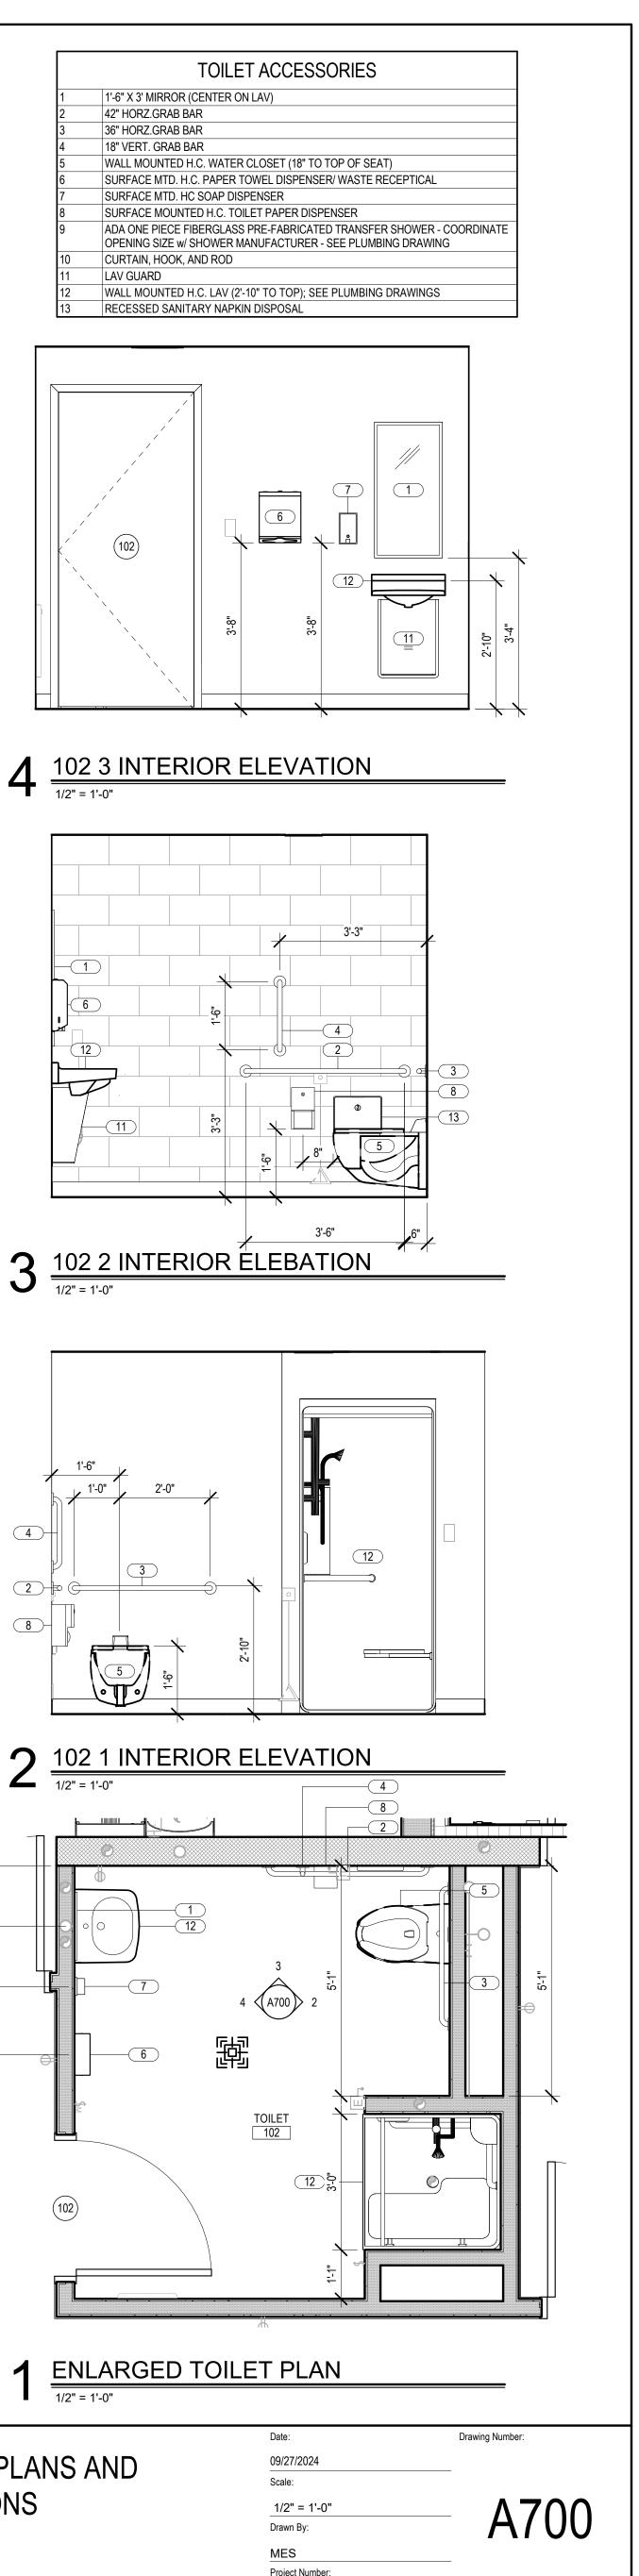
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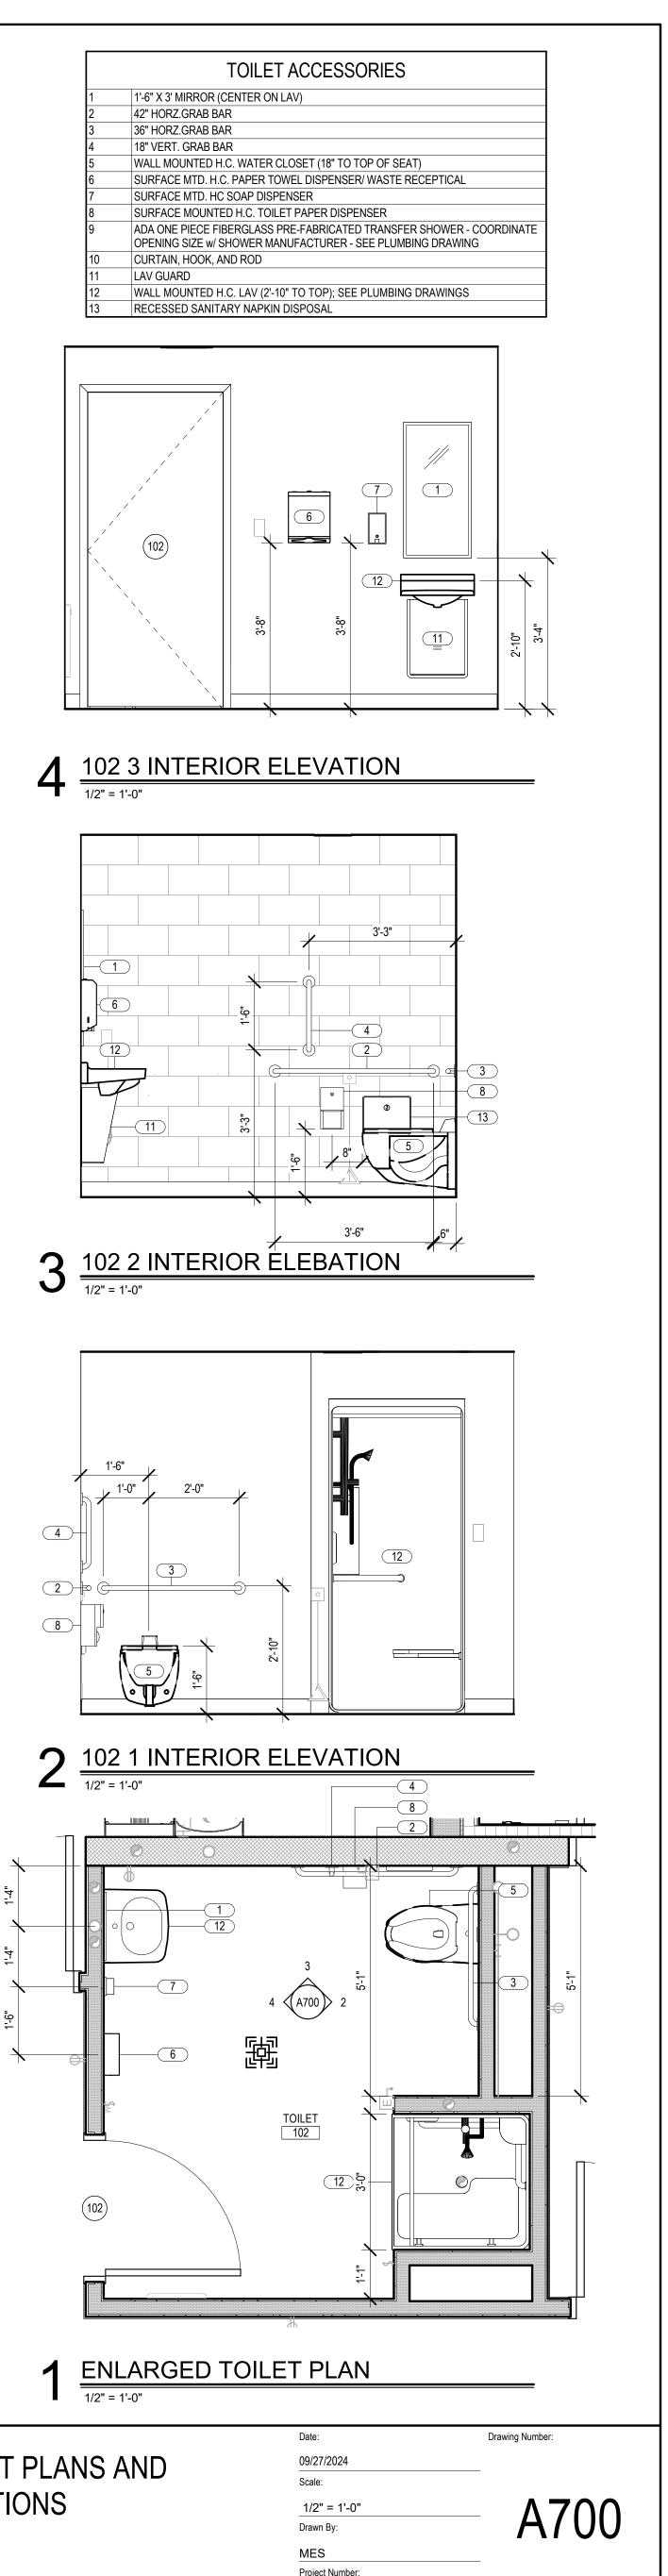
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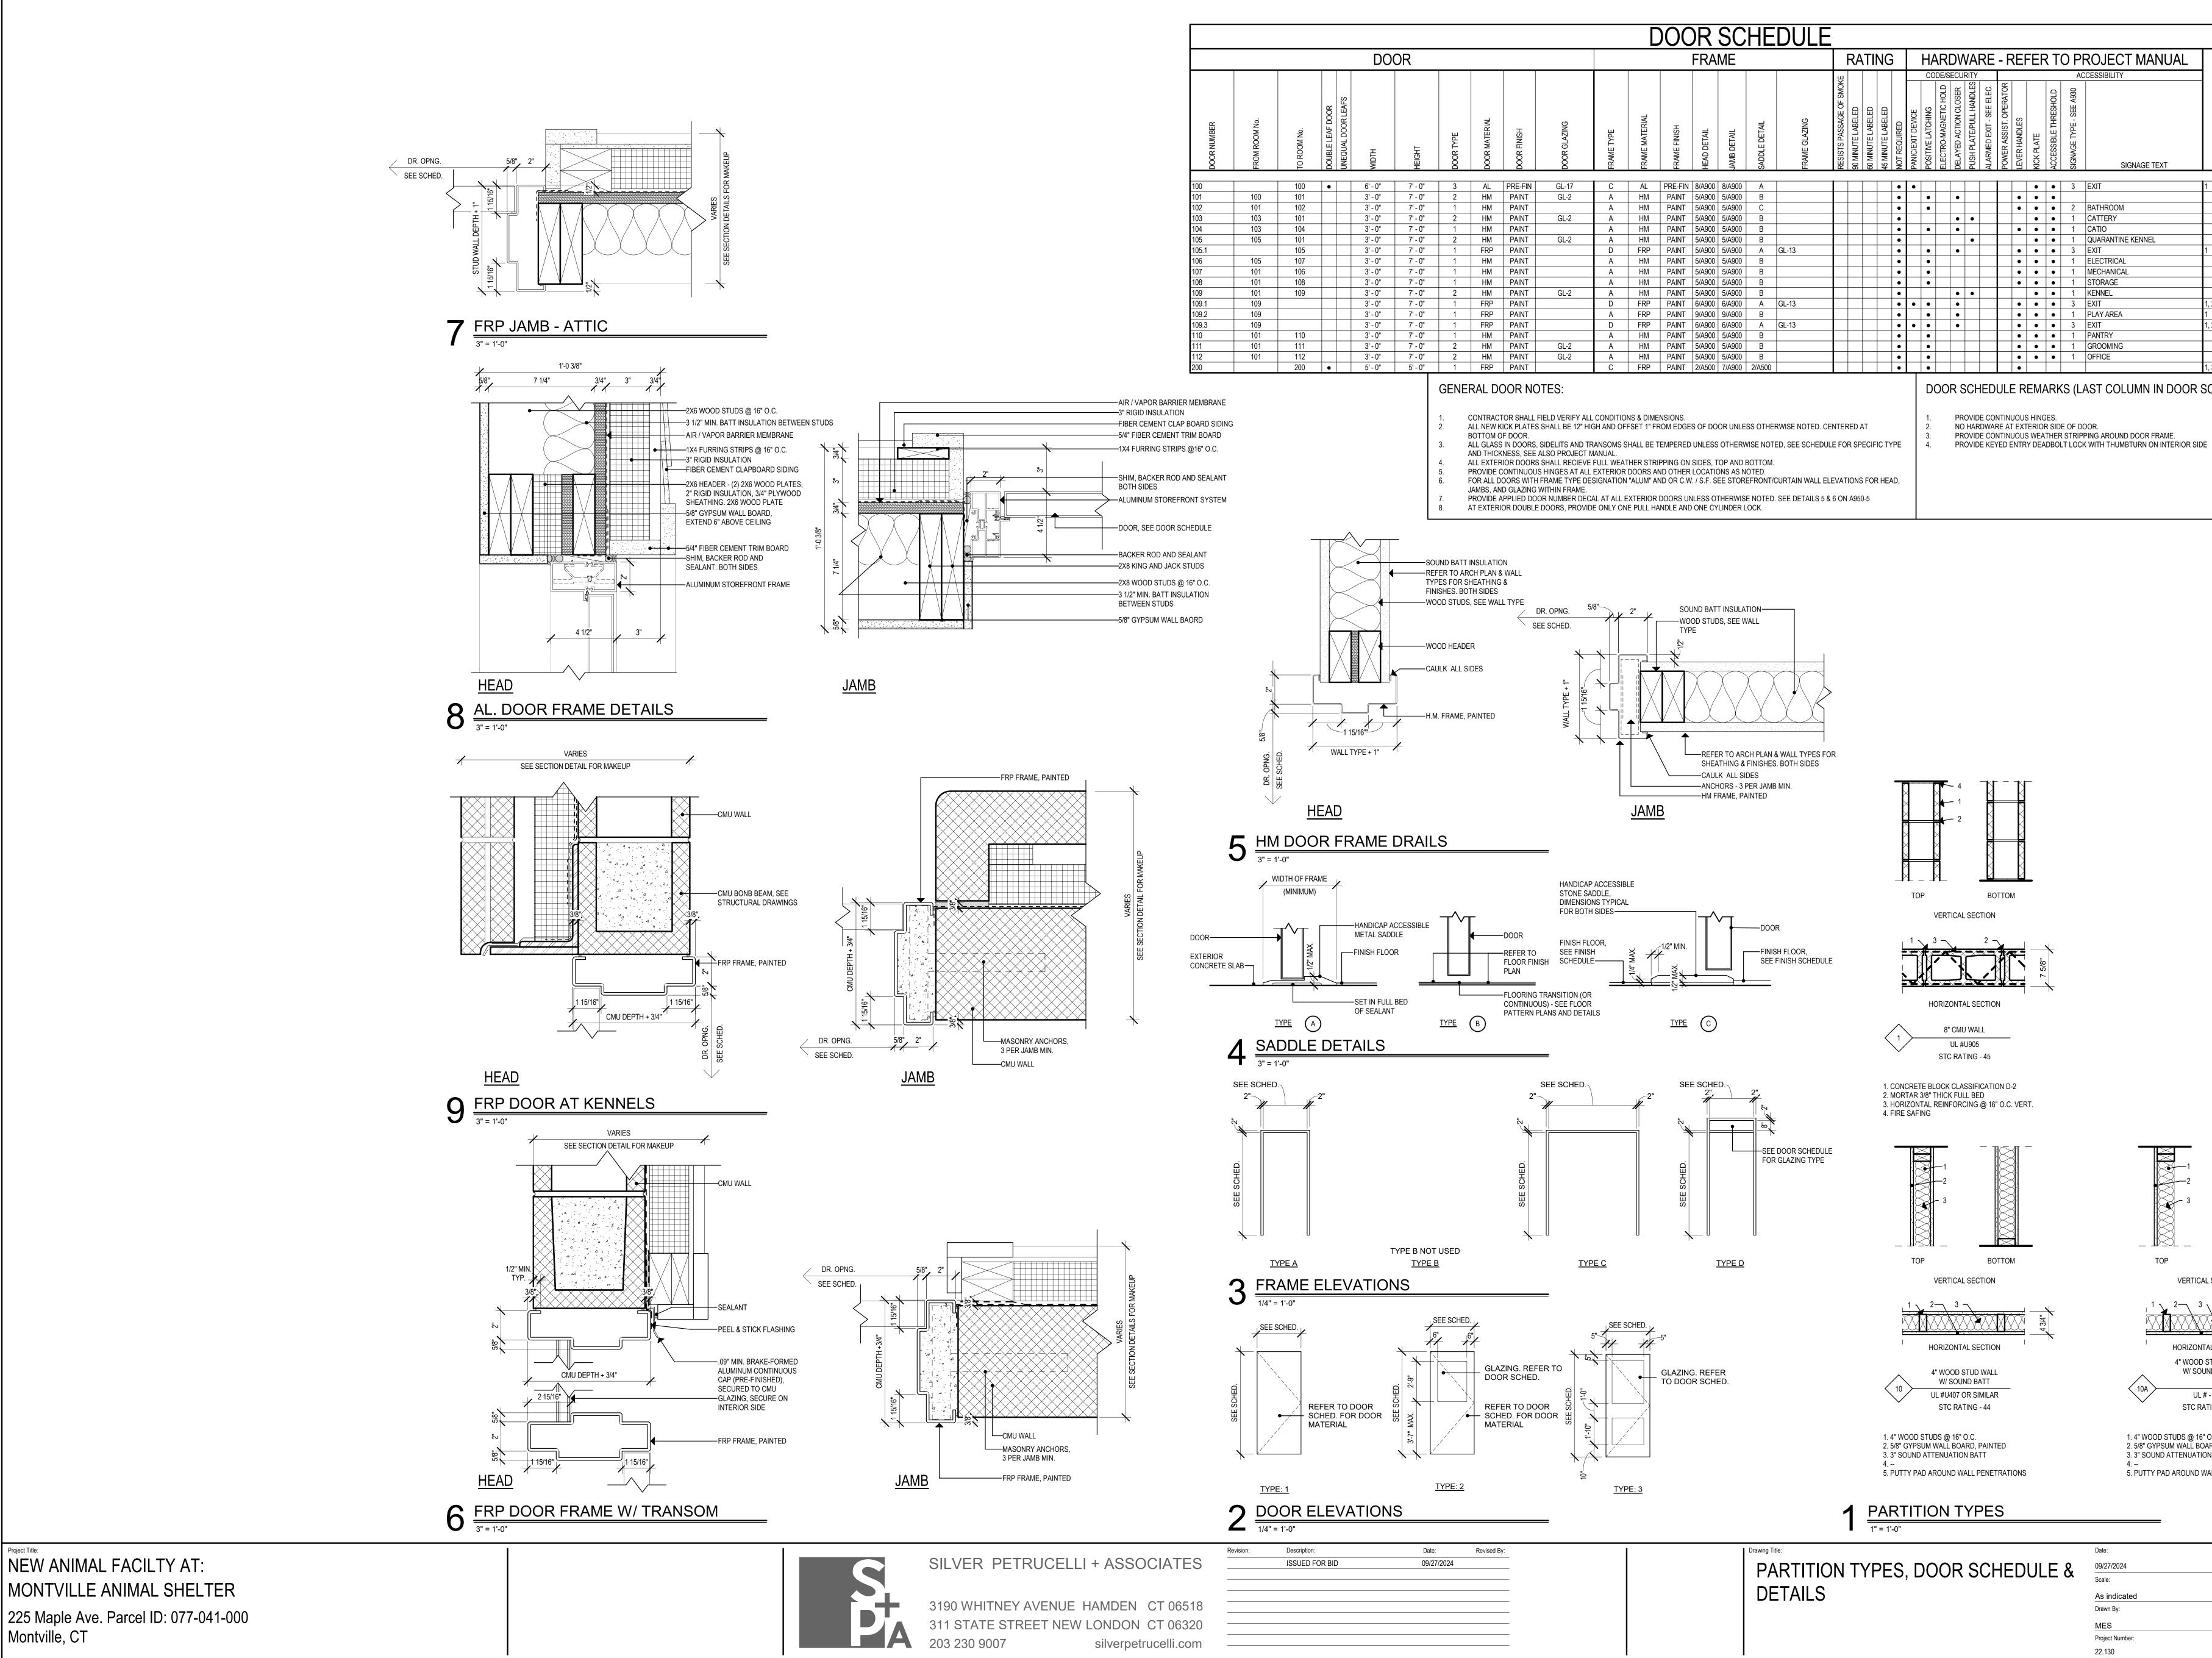




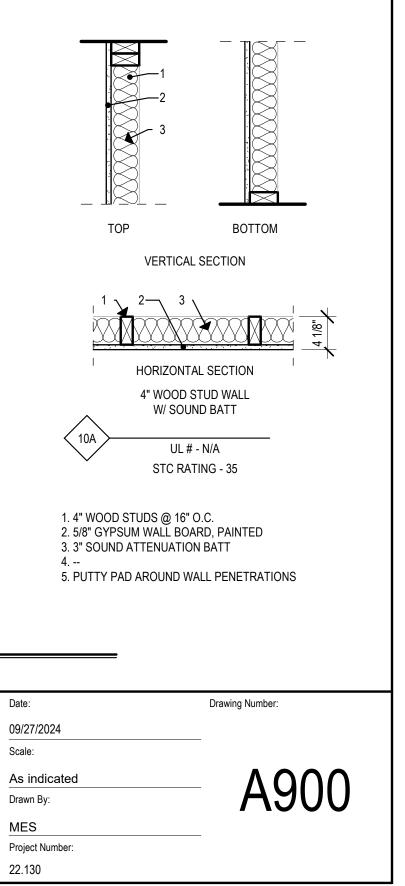




Date:	Revised By:	1	1	Drawing Title:	Date:
09/27/2024				INTERIOR ELEVATIONS	09/27/ Scale: 1/2" Drawn
				F	MES Project 22.13



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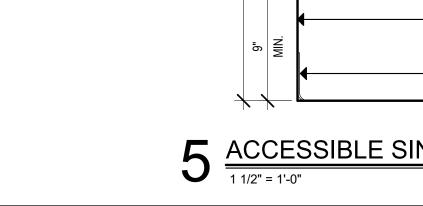


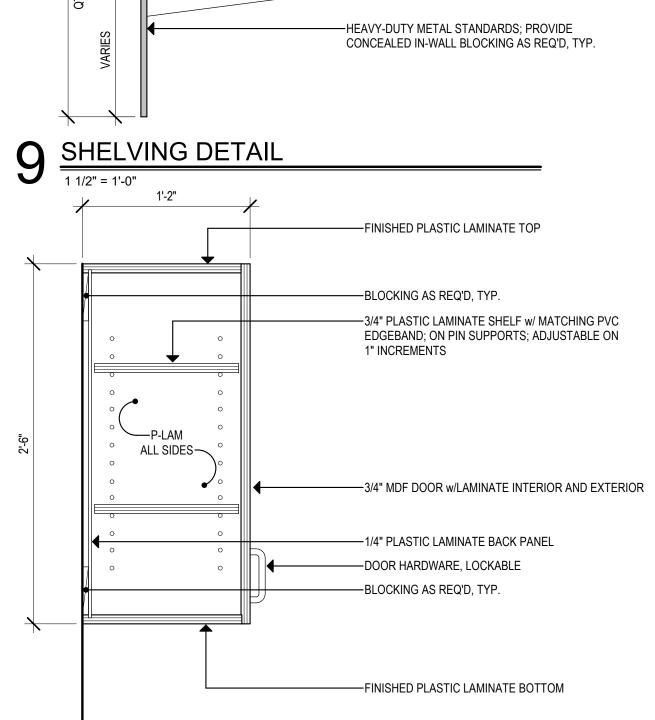




VARIES

SEE ELEVATION

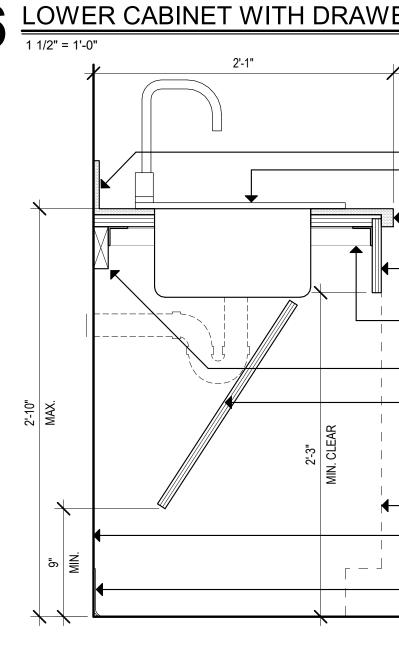




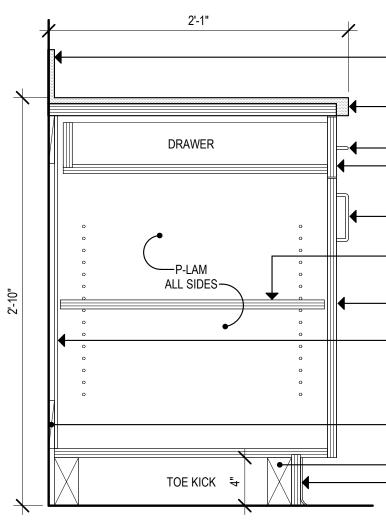
MDF CORE SHELF w/ MATCHING PVC EDGE

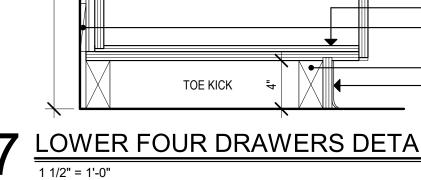
-HEAVY- DUTY METAL BRACKETS

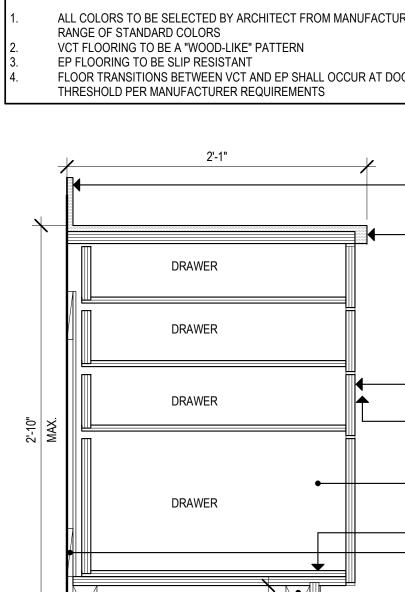
BAND



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	NO. N	AME FLOOR FINI	ISH BASE FINIS		SCHEDULE			NISH CEILING FINISH	COMMENTS		ILLUMINA IN TAMPE DRAWING
	100 VESTIBULE	VCT	RUBBER WALL BAS	SE PAINT	PAINT	PAINT	PAINT	ACOUSTIC CEILING TILE			ILLUMINA EXIT DOO
	101 CORR. 102 TOILET 103 CATTERY	VCT EP VCT	RUBBER WALL BAS COVED EP RUBBER WALL BAS	PAINT	PAINT PAINT PAINT	PAINT PAINT PAINT	PAINT PAINT PAINT	PAINT PAINT ACOUSTIC CEILING TILE			TYPICAL S BY DOOR SC
	104CATIO105QUARANTINE106MECH	BRUSHED CONC CORR. EP EP	RETE COVED EP COVED EP	 PAINT PAINT	 PAINT PAINT	 PAINT PAINT	 PAINT PAINT	 PAINT ACOUSTIC CEILING TILE			
	107 IT/ELEC. 108 STOR.	EP VCT R. EP	COVED EP RUBBER WALL BAS	PAINT SE PAINT	PAINT PAINT	PAINT PAINT	PAINT PAINT	ACOUSTIC CEILING TILE ACOUSTIC CEILING TILE			NOTE: TA BRAILLE A CHARACT
	109KENNEL COF110DRY STOR./F111UTILITY / GRO	OOD PANTRY VCT	COVED EP RUBBER WALL BAS RUBBER WALL BAS		PAINT PAINT PAINT	PAINT PAINT PAINT	PAINT PAINT PAINT	PAINT ACOUSTIC CEILING TILE ACOUSTIC CEILING TILE	 	LATCH SIDE	EXIT CHARACT
	112OFFICE200ATTIC	VCT 	RUBBER WALL BAS	SE PAINT	PAINT 	PAINT 	PAINT 	ACOUSTIC CEILING TILE		DOOR	WHEN BO SIDE ON V
		ELECTED BY ARCHITECT FROM	MANUFACTURER'S FULL								4" NIW0-
	3. EP FLOORING TO BE	E A "WOOD-LIKE" PATTERN SLIP RESISTANT								EXIT	
		BETWEEN VCT AND EP SHALL C NUFACTURER REQUIREMENTS	JCCUR AT DOOR								ELECTRIC FINISH FL
		2'-1"							✓ TYF	ICAL EXIT S	
			4"	'H SOLID SURFACE BACK	(SPLASH				1/2" = 1		
			1 1 E/	1/2" SOLID SURFACE COU ASED EDGE; w/ 1" MDF BA	UNTERTOP, ACKER						TYPICAL S
		DRAWER							ſ	/	G 9" , O SEE TYPE AS DESIG DOOR SC OTHER DI
		DRAWER									9" OTHER DI
		DRAWER	≡Щ ■ ■	LASTIC LAMINATE DRAW	'ER FACE, TYP.						NOTE: TACTILE S AFF TO B/
	Z-10"			RAWER HARDWARE, LOC	CKABLE, TYP.					LATCH SIDE DOOR	AFF TO BA AFF TO BA MAX. AFF TACTILE S AFF TO BA MAX. AFF TACTILE S AFF TO BA MAX. AFF TACTILE S AFF TO BA MAX. AFF
		•	S(olid hardwood drawe	ER SIDES / BACKS, TYP.						NOTE:
		DRAWER		ARDWOOD PLYWOOD DR							
				LOCKING AS REQUIRED,							LEAVES A MOUNT O ON WALL
				LOCKING AS REQUIRED, ⁻ 'H RESILIENT WALL BASE							FINISH FL
		JR DRAWERS	DETAIL							<u>'ICAL SIGN N</u>	MOUNTING DE
	1 1/2" = 1'-0"								J 1/2" = 1	'-0"	
	Ŀ	2'-1"								G -	<u>.</u>
				H SOLID SURFACE BACK	SPLASH				7	EQ	EQ
				1/2" SOLID SURFACE COL ASED EDGE; w/ 1" MDF BA							•
		DRAWER	DF	ASED EDGE; W/ T_MDF BA RAWER HARDWARE, LOC H DRAWER FACE							
LASTIC LAMINATE ON / MATCHING PVC EDGE		۰ ۰		OOR HARDWARE, LOCKAI 4" PLASTIC LAMINATE SH							
		P-LAM ALL SIDES	M/ AE	ATCHING PVC EDGE BAN DJ. ON 1" INCREMENTS, 2" MDF DOOR w/ MATCHII	ND; ON PIN SUPPORTS;						
L BRACKETS	∠ √		1A A	2 MDF DOOR W/ MATCHI ND EXTERIOR 4" PLASTIC LAMINATE BA							
		0 0 0									
STANDARDS; PROVIDE			BL	LOCKING AS REQUIRED,	TYP.				BOTTOM OF BRAILLE	WON	ЛЕМ
L BLOCKING AS REQ'D, TYP.				LOCKING AS REQUIRED, 1 H RESILIENT WALL BASE					38		
									\		
		BINET WITH D	RAWER DE	TAIL						PICLA SIGN D	DETAIL
	1 1/2" = 1'-0"	2'-1"							6" = 1'-)"	
IC LAMINATE TOP								NOTE: COORDINATE TEXT AS INDIC. DOOR SCHEDULE.		COORDINATE TEXT AS INDICA FOR ONE-LINE TEXT.	ATED ON DOOR SCHEDULE.
				-4"H SOLID SURFACE BA -PLUMBING FIXTURES A	ACKSPLASH NS SCHEDULED; REFER TO P	LUMBING DWGS		6"	+		Ö
/INATE SHELF w/ MATCHING PVC PIN SUPPORTS; ADJUSTABLE ON		↓			COUNTERTOP, EASED EDGE	•					
				w/ 1" MDF BACKER -5" PLASTIC LAMINATE A	APRON w/ MATCHING PVC EE	GEBAND		© ROOM NAME	4		4 1/2" 3/8" MIN. FROM TOP OF BRAILLE TYP.
			Щ	-UNISTRUT CONTINUOUS	IS METAL ANGLE BRACKET F	OR		#	δ		OF BRAIN. H
V/LAMINATE INTERIOR AND EXTERIOR			 	CONCEALED COUNTER SIDES OF ADJACENT CA	TOP SUPPORT; SECURE TO ASEWORK/WALL/APRON. AINTED TO MATCH WALL; RI	ALL				UNISE	EX g
/INATE BACK PANEL	2'-10" MAX.			TO FINISH SCHEDULE -REMOVABLE PANEL - PI	LASTIC LAMINATE w/ MATCH ATE WITH PLUMBING, TYP. F	ING PVC			,	RESTRO	
RE, LOCKABLE EQ'D, TYP.		2'-3" CIFAR		SUPPORT CLEATS AND				TYPE S1		9" TYPE S2	2
		NW		-LINE OF CASEWORK BE	EYOND			SIGNAGE NOTES:			
IC LAMINATE BOTTOM			 	-PAINTED WALL; REFER	TO FINISH SCHEDULE			1. SIGNS SHALL COMPLY WIT	TH CURRENT BUILDING CODE LINES, AND ALL OTHER APPL		
	⁵ σ N			-RUBBER WALL BASE AS	S SCHEDULED			2. TEXT ON SIGNS SHALL BE APPROVED BY ARCHITECT	COORDINATED IN FIELD TO I AND OWNER PRIOR TO FAB	REFLECT ROOM USE, AND SH	
		*							GS FOR ALL ILLUMINATED SIG		
	$5 \frac{\text{ACCESSIBLI}}{1 \text{ 1/2"} = 1'-0"}$	E SINK DETAIL							1 <u>SIG</u> 3" = 1'-1		ELEVATIONS
	Re	vision: Description:		Date: Revised	By:	<u> </u>		Drawing Title:	- 3" = 1'-		Date:
SILVER PETRUCELL	I + ASSOCIATES	ISSUED FOR BI	D	09/27/2024				SIGNAGE [NISH SCHE	
3190 WHITNEY AVENUE	HAMDEN CT 06518							& CASEWC	ORK DETAIL	S	As indi
311 STATE STREET NEW	/ LONDON CT 06320										MES Project N
203 230 9007	silverpetrucelli.com –					I					22.130

