

## **GENERAL POWER NOTES**

- ALL WORK SHALL CONFORM WITH THE ELECTRICAL SPECIFICATIONS AND LATEST ACCEPTED NATIONAL ELECTRICAL CODE (NEC).
- ALL ELECTRICAL EQUIPMENT INCLUDED BUT NOT LIMITED TO ELECTRICAL PANELS,
  DISCONNECTS, STARTERS AND VFD TO BE INSTALLED INSIDE SHALL BE MOUNTED ON 3/4"
  FIRE RATED PLYWOOD BACKBOARD TO BE PROVIDED BY ELECTRICAL CONTRACTOR.
- PROVIDE UNISTRUT AS REQUIRED TO INSTALL DISCONNECT, VFD OR STARTER NEAR EQUIPMENT AND ACCESSIBLE.
- FINAL LOCATION OF POWER SHALL BE COORDINATED WITH FIRNITURE AND EQUIPMENT.
- DEVICES TO BE INSTALLED ABOVE COUNTER SHALL BE MOUNTED 6" FROM COUNTER SURFACE (WHEN THERE IS NO BACK SPLASH) OR 6" FROM BACK SPLASH.
- ALL ELECTRICAL EQUIPMENT INCLUDED BUT NOT LIMITED TO ELECTRICAL PANELS, DISCONNECT, STARTERS, AND VFD SHALL BE MOUNTED ON 3/4" FIRE RATED PLYWOOD BACKBOARD TO BE PROVIDED BY ELECTRICAL CONTRACTOR.
- PROVIDE UNISTRUT AS REQUIRED TO INSTALL DISCONNECT MEANS NEAR EQUIPMENT AND
  ACCESSIBLE
- REFER TO ONE-LINE RISER DIAGRAM ON SHEET E600 FOR ADDITIONAL INFORMATION ON ELECTRICAL EQUIPMENT AND DISTRIBUTION.

ELECTRICAL MAIN LEVEL POWER PLAN

1/4" = 1'-0"

NEW ANIMAL FACILITY AT:
MONTVILLE ANIMAL SHELTER

225 Maple Ave. Parcel ID: 077-041-000
Montville, CT



SILVER PETRUCELLI + ASSOCIATES

3190 WHITNEY AVENUE HAMDEN CT 06518 311 STATE STREET NEW LONDON CT 06320 203 230 9007 silverpetrucelli.com

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ELECTRICAL MAIN LEVEL POWER PLAN


Date: Drawing Number:

09/27/2024
Scale:

AS NOTED
Drawn By:

JRP
Project Number:

22.130

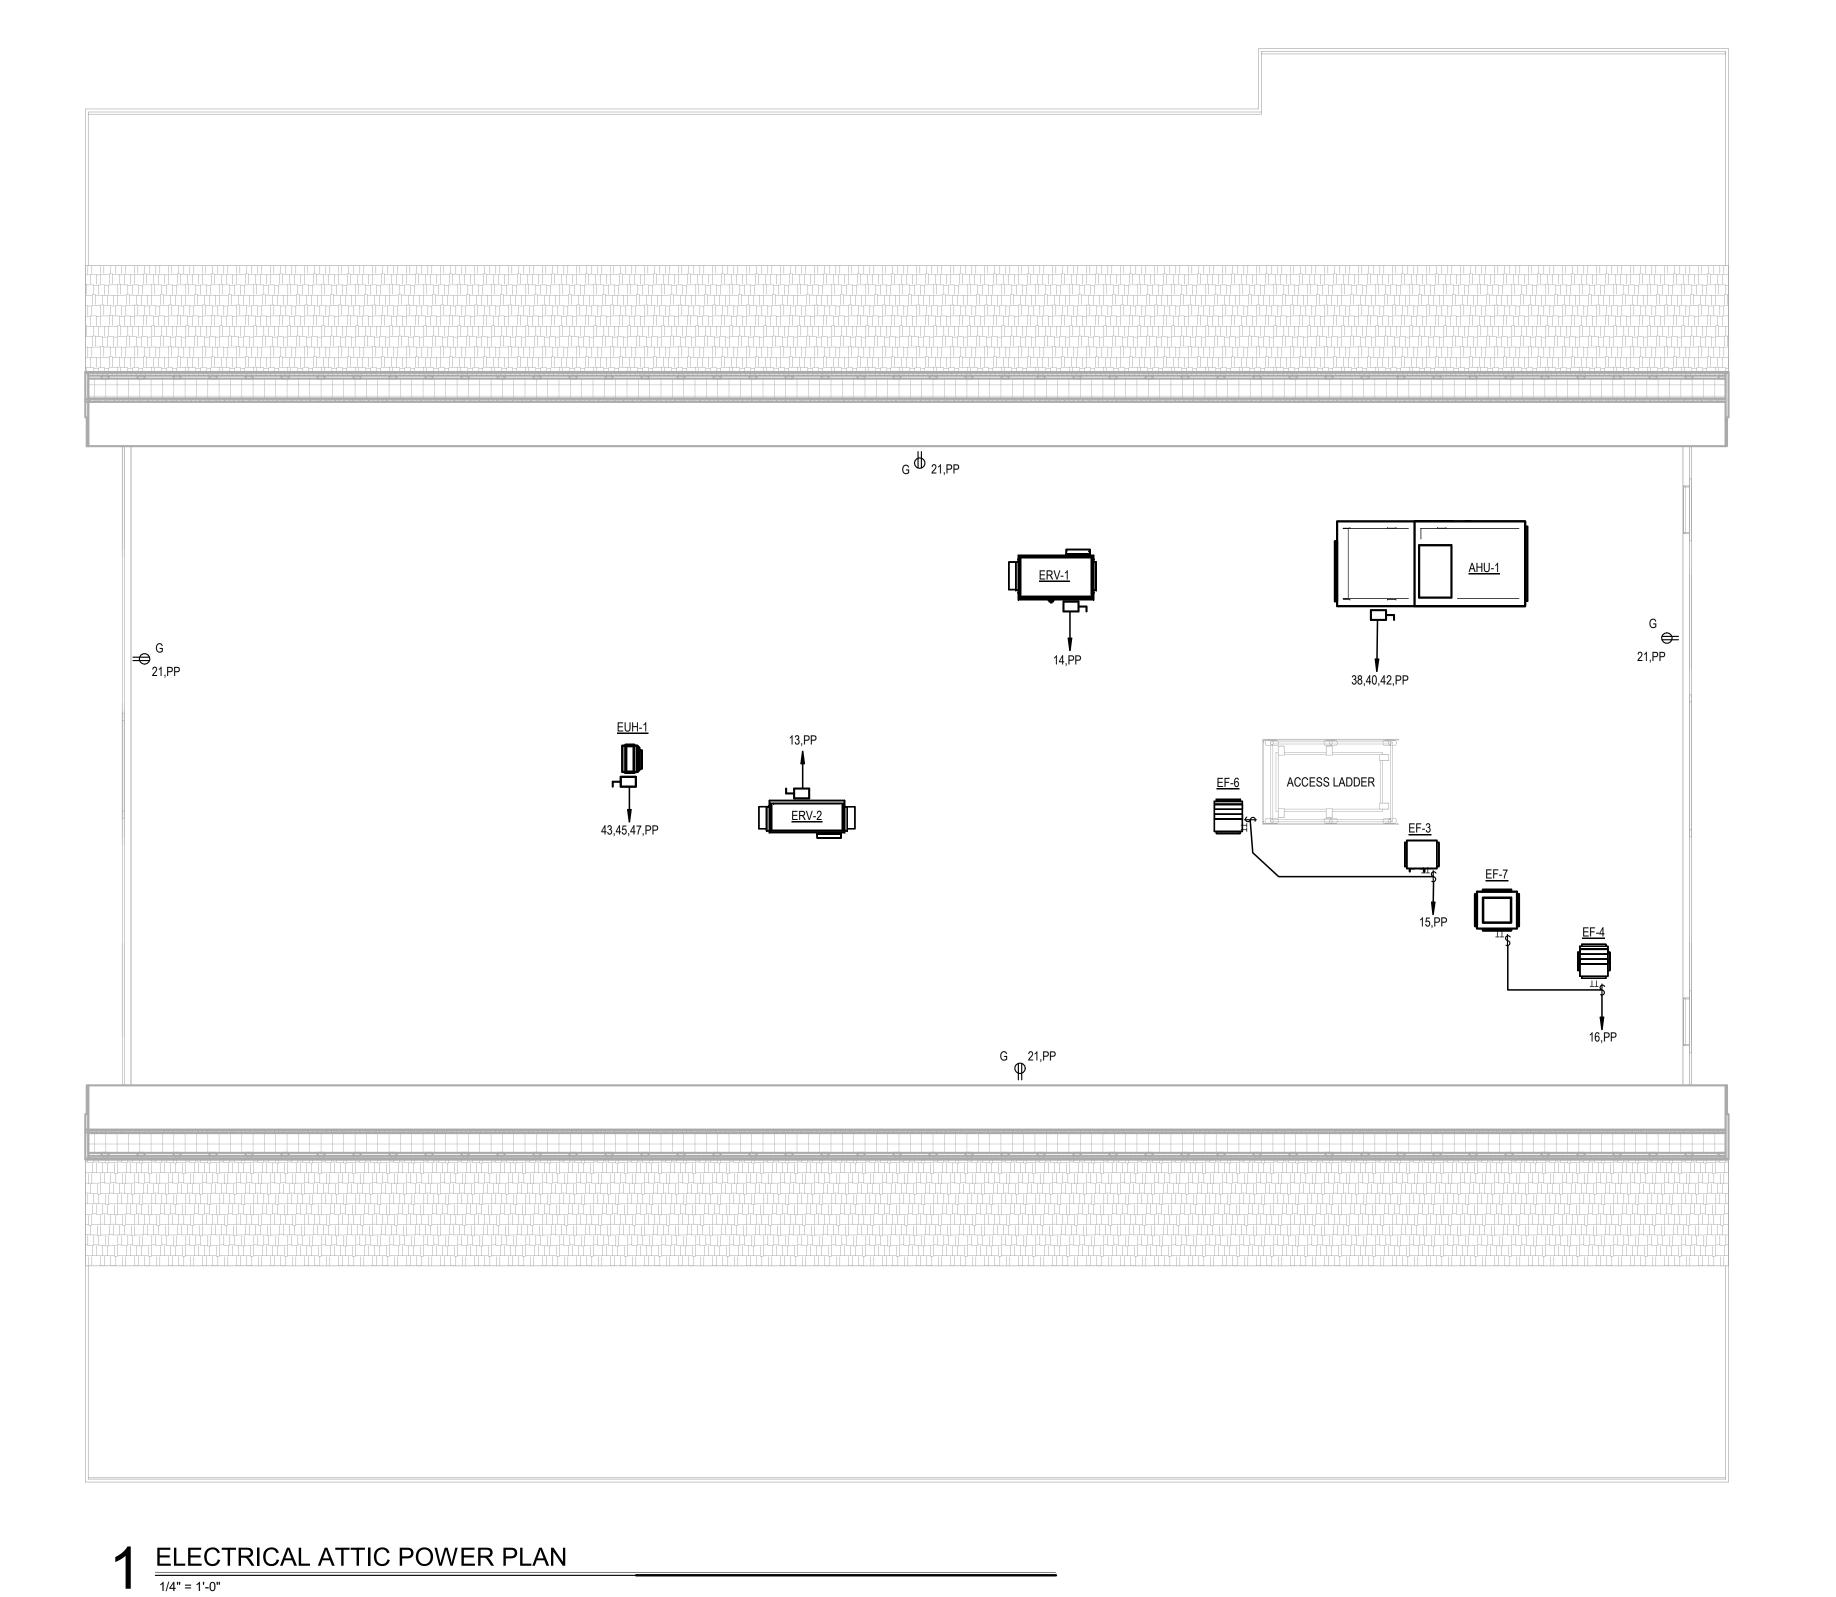

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# **Branch Panel: PP**

Location: MECH 106 Supply From: Mounting: Surface

Enclosure: Type 1

### Volts: 120/208 Wye Phases: 3 Wires: 4

**A.I.C. Rating:** 42,000 Mains Type: MLO Mains Rating: 400 A MCB Rating: 0 A

1. UPDATE WIRE SIZE AS REQUIRED TO MAINTAIN 3% MAXIMUM VOLTAGE DROP. 2. PANELBOARD SHALL BE CUTTLE HAMMER PPOWER-R-LINE OR EQUAL WITH MAIN LUGS.

СКТ	Circuit Description	Wire & Conduit	Trip	Poles		Ą	E	3	C	;	Poles	Trip	Wire & Conduit	Circuit Description	СКТ
1	Power Receptacles	3/4"C, 2#12, 1#12G	20 A	1	180	336					1	20 A	3/4"C, 2#12, 1#12G	Lighting	2
3	EF-1, EF-2 & EF-5	3/4"C, 2#12, 1#12G	20 A	1			300	606			1	20 A	3/4"C, 2#12, 1#12G	Lighting	4
5	Electric Water Cooler	3/4"C, 2#12, 1#12G	20 A	1					300	350	1	20 A	3/4"C, 2#12, 1#12G	Lighting - Exterior	6
7	Lighting	3/4"C, 2#12, 1#12G	20 A	1	680	1260					1	20 A	3/4"C, 2#12, 1#12G	Power Receptacles	8
9	Power Receptacles	3/4"C, 2#12, 1#12G	20 A	1			900	900			1	20 A	3/4"C, 2#12, 1#12G	Power Receptacles	10
11	Lighting	3/4"C, 2#12, 1#12G	20 A	1					860	1500	1	20 A	3/4"C, 2#12, 1#12G	Electric Wall Heater	12
13	ERV-2	3/4"C, 2#12, 1#12G	20 A	1	1464	1800					1	25 A	3/4"C, 2#10, 1#10G	ERV-1	14
15	EF-3 & EF-6	3/4"C, 2#12, 1#12G	20 A	1			1000	1000			1	20 A	3/4"C, 2#12, 1#12G	EF-4 & EF-7	16
17	Heat Trace Control	3/4"C, 3#12, 1#12G	20 A	2					1664	720	1	20 A	3/4"C, 2#12, 1#12G	Power Receptacles	18
19					1664	720					1	20 A	3/4"C, 2#12, 1#12G	Power Receptacles	20
21	Power Receptacles	3/4"C, 2#12, 1#12G	20 A	1			720	200			2	20 A	3/4"C, 2#12, 1#12G	Fan Coil Units	22
23	Spare		20 A	1					0	200					24
25	 Spare		20 A	1	0	1080					1	20 A	3/4"C, 2#12, 1#12G	Power Receptacles	26
27	Dryer Machine	1"C, 3#8, 1#10G	40 A	2			2500	1080			1	20 A	3/4"C, 2#12, 1#12G	Power Receptacles	28
29									2500	1080	1	20 A	3/4"C, 2#12, 1#12G	Power Receptacles	30
31	Microwave	3/4"C, 2#12, 1#12G	20 A	1	1500	1500					1	20 A	3/4"C, 2#12, 1#12G	Electric Wall Heater	32
33	Refrigerator	3/4"C, 2#12, 1#12G	20 A	1			1500	1500			1	20 A	3/4"C, 2#12, 1#12G	Electric Wall Heater	34
35	Washer Machine	3/4"C, 2#12, 1#12G	20 A	1					1500	1500	1	20 A	3/4"C, 2#12, 1#12G	Electric Wall Heater	36
37	ASHP-1	3/4"C, 3#10, 1#10G	30 A	3	1920	2040					3	25 A	3/4"C, 3#10, 1#10G	AHU-1	38
39							1920	2040							40
41									1920	2040					42
43	EUH-1	3/4"C, 3#10, 1#10G	30 A	3	2500	3456					3	40 A	1"C, 3#8, 1#10G	VRF-1	44
45							2500	3456							46
47									2500	3456					48
49	Hot Water Heater	1-1/4"C, 3#4, 1#8G	70 A	3	6000	162					1	20 A	3/4"C, 2#12, 1#12G	Site Lighting	50
51							6000	0			1	20 A	, ,	Spare	52
53									6000	0	1	20 A		Spare	54
55	PHPU-1	2"C, 3#1/0, 1#6G	150 A	3	12240	0					1	20 A		Spare	56
57							12240	0			1	20 A		Spare	58
59									12240	0	1	20 A		Spare	60
61	Spare		20 A	1	0	0					1	20 A		Spare	62
63	Spare		20 A	1			0	0			1	20 A		Spare	64
65	 Spare		20 A	1					0	0	1	20 A		Spare	66
67	Spare		20 A	1	0	0					1	20 A		Spare	68
69	Spare		20 A	1			0	0			1	20 A		Spare	70
71	Spare		20 A	1					0	0	1	20 A		Spare	72
73	Spare		20 A	1	0	0					1	20 A		Spare	74
75	Spare		20 A	1			0	0			1	20 A		Spare	76
77	Spare		20 A	1					0	0	1	20 A		Spare	78
79	Spare		20 A	1	0	0					1	20 A		Spare	80
81	Spare		20 A	1			0	0			1	20 A		Spare	82
83	Spare		20 A	1					0	0	1	20 A		Spare	84
03	Spare		1	l Load:	4050	 )2 VA	4000	 62 VA	4031	_	1	20 A		Spare	_

Load Classification	Connected Load	Demand Factor	Estimated Demand	Panel Totals		
Lighting	2482 VA	100.00%	2482 VA			
Other	8700 VA	80.00%	6960 VA	Total Conn. Load:	121177 VA	
Power	109500 VA	80.00%	87600 VA	Total Est. Demand:	97504 VA	
Lighting - Exterior	350 VA	100.00%	350 VA	Total Conn. Current:	336 A	
				Total Est. Demand Current:	271 A	

**Total Amps:** 338 A 336 A 336 A

3. PROVIDE HACR BREAKER TO SUIT HEATING, AIR CONDITION AND REFRIGERATOR EQUIPMENT. 4. PROVIDE 3/4"C, 2#12, 1#12G FOR ALL 20A-1P CKT. WITHOUT WIRE AND CONDUIT INFORMATION.

				E	EQUIPM	ENT SO	CHEDULE			
SYMBOL	VOLTAGE	PHASE	FLA	DISCONNECT SWITCH	BREAKER	PANEL	CONDUIT & WIRE	CONNECTION	LOCATION	NOTES
ASHP-1	208	3	16	30A-3P	30A-3P	PP	SEE PNL. SCHEDULE	HARD-WIRED DISC. SWITCH	EXTERIOR	-
AHU-1	208	3	17	30A-3P	25A-3P	PP	SEE PNL. SCHEDULE	HARD-WIRED DISC. SWITCH	ATTIC	-
FCU 1-1 THRU 1-4	208	1	2	30A-2P	20A-2P	PP	SEE PNL. SCHEDULE	HARD-WIRED DISC SWITCH	SEE DRAWING E200	-
EF-1	120	1	1	30A-1P	20A-1P	PP	SEE PNL. SCHEDULE	HARD-WIRED DISC. SWITCH	CORRIDOR	-
EF-2	120	1	4.4	30A-1P	20A-1P	PP	SEE PNL. SCHEDULE	HARD-WIRED DISC. SWITCH	GROOMING - 111	-
EF-3	120	1	4.4	30A-1P	20A-1P	PP	SEE PNL. SCHEDULE	HARD-WIRED DISC. SWITCH	ATTIC	-
EF-4	120	1	4.4	30A-1P	20A-1P	PP	SEE PNL. SCHEDULE	HARD-WIRED DISC. SWITCH	ATTIC	-
EF-5	120	1	1	30A-1P	20A-1P	PP	SEE PNL. SCHEDULE	HARD-WIRED DISC. SWITCH	GROOMING - 111	-
EF-6	120	1	5.8	30A-1P	20A-1P	PP	SEE PNL. SCHEDULE	HARD-WIRED DISC. SWITCH	ATTIC	-
EF-7	120	1	5.8	30A-1P	20A-1P	PP	SEE PNL. SCHEDULE	HARD-WIRED DISC. SWITCH	ATTIC	-
ERV-1	120	1	15	30A-1P	25A-1P	PP	SEE PNL. SCHEDULE	HARD-WIRED DISC. SWITCH	ATTIC	5
ERV-2	120	1	12	30A-1P	25A-1P	PP	SEE PNL. SCHEDULE	HARD-WIRED DISC. SWITCH	ATTIC	5
EUH-1	208	3	21	30A-3P	30A-3P	PP	SEE PNL. SCHEDULE	HARD-WIRED DISC. SWITCH	ATTIC	5
EWH-1 THRU 4	120	1	12.5	30A-1P	20A-1P	PP	SEE PNL. SCHEDULE	HARD-WIRED DISC. SWITCH	SEE DRAWING E210	-
VFR-1	208	1	28	60A-3P	40A-3P	PP	SEE PNL. SCHEDULE	HARD-WIRED DISC. SWITCH	EXTERIOR	-
HWH-1	208	3	50	60A-3P	70A-3P	PP	SEE PNL. SCHEDULE	HARD-WIRED DISC. SWITCH	MECHANICAL ROOM 106	
PHPU-1	208	3	102	200A-3P	150A-3P	PP	SEE PNL. SCHEDULE	HARD-WIRED DISC. SWITCH	EXTERIOR	5,6

# NOTES:

1. REFER TO ELECTRICAL AND MECHANICAL DRAWINGS FOR QUANITITY.

2. PROVIDE ANY 120V WIRING REQUIRED TO INTERLOCK EQUIPMENT WITH HVAC CONTROL. 3. UPGRADE WIRE SIZE AS REQUIRED TO MAINTAIN 3% MAXIMUM VOLTAGE DROP.

4. CONNECT EXHAUST FAN IN TOILET, GROOMING AND MECHANICAL ROOM WITH LOCAL LIGHT SWITCH. 5. SAFETY DISONNECT SWITCH TO BE PROVIDED WITH UNIT, INSTALLED AND WIRED BY ELECTRICAL CONTRACTOR. 6. UNIT TO BE PROVIDED INTEGRATED POWER RECEPTACLE TO BE WIRED FROM A SEPERATE 120V CIRUCUIT.

		LIGHTING FIXTURE SC	HEDUL	E					
DESIGNATION	DESCRIPTION	MANUFACTURER/	l	_AMP		E	LECTRICAL		NOTES
DESIGNATION	DESCRIPTION	MODEL NUMBER	TYPE	COLOR TEMP	NO	DRIVER	VOLTAGE	WATTS	NOTES
А	2' X 2' RECESSED LED EDGE LIT FLAT PANEL WITH ACRYLIC BLEND FROSTER LENS AND SWITCHABLE LUMEN TECHNOLOGY	COLUMBIA CF22-40/33/2835	LED	4000K		ELECTRONIC	120	40	
A/EM	SAME AS TYPE - A WITH INTEGRATED EMERGENCY BATTERY PACK	COLUMBIA CF22-40/33/2835-PLD10M	LED	4000K		ELECTRONIC	120	40	
В2	2' LENGTH SURFACE MOUNTED LED GASKETED LINEAR RATED FOR EXTREME ENVIROTMENT AND WITH RIBBED FROSTED ACRYLIC LENS	COLUMBIA LXEM2-40LW-RFA-ED-U	LED	4000K		DIMMING	120	26	
В4	4' LENGTH SURFACE MOUNTED LED GASKETED LINEAR RATED FOR EXTREME ENVIROTMENT AND WITH RIBBED FROSTED ACRYLIC LENS	COLUMBIA LXEM4-40ML-RFA-ED-U	LED	4000K		DIMMING	120	42	
B4/EM	SAME AS TYPE - B4 WITH INTEGRATED EMERGENCY BATTERY PACK	COLUMBIA LXEM4-40ML-RFA-ED-U-ELL14	LED	4000K		DIMMING	120	42	
B8	8' LENGTH SURFACE MOUNTED LED GASKETED LINEAR RATED FOR EXTREME ENVIROTMENT AND WITH RIBBED FROSTED ACRYLIC LENS	COLUMBIA LXEM8-40ML-RFA-ED-U	LED	4000K		DIMMING	120	84	
B8/EM	SAME AS TYPE - B8 WITH INTEGRATED EMERGENCY BATTERY PACK	COLUMBIA LXEM8-40ML-RFA-ED-U-ELL14	LED	4000K		DIMMING	120	42	
С	6" DIAMETER RECESSED LED DOWNLIGHT	PRESCOLITE LFR-6RD-M-20L40K8-WD	LED	4000K		ELECTRONIC	120	14.6	
C/EM	SAME AS TYPE - C WITH INTEGRATED EMERGENCY BATTERY PACK	PRESCOLITE LFR-6RD-M-20L40K8-WD-EM	LED	4000K		ELECTRONIC	120	14.6	
C1	6" DIAMETER RECESSED LED SHOWER DOWNLIGHT WITH LENS	PRESCOLITE LTR-6RD (SH)-H-SL15L	LED	4000K		ELECTRONIC	120	18.7	
C2	6" DIAMETER ADJUSTABLE RECESSED LED DOWNLIGHT	PRESCOLITE LTR-6RD-H-SL15L / LTR-6RD-T-SL40K8	LED	4000K		ELECTRONIC	120	18.7	
C2/EM	SAME AS TYPE - C2 WITH INTEGRATED EMERGENCY BATTERY PACK	PRESCOLITE LTR-6RD-H-SL15L-EM / LTR-6RD-T-SL40K8	LED	4000K		ELECTRONIC	120	18.7	
Х	THERMOPLASTIC LED EXIT SIGN	DUAL LITE EVE-U-R-W-E-I	LED		-	-	120	2.2	1
X1	THERMOPLASTIC LED EXIT SIGN WITH ARROW	DUAL LITE EVE-U-R-W-E-I	LED		-	-	120	2.2	1
X2	EXIT LED SIGN WITH POLYCARBONTE HOUSING AND RATED FOR WET LOCATION	DUAL LITE EVE4X-R-W-A	LED	-	-	-	120	1.42	1
X/HC	ADA EDGE-LIT SIGN WTH DYNAMIC HANDICAP SYMBOL AND UNIVERSAL MOUNTING KIT	SIGNTEX INC CAEBB-1RCW-NA-TW	LED	-	-	-	120	1.42	1 7

## LIGHT FIXTURE NOTES:


- (1.) PROVIDE WITH FEATURES & ACCESSORIES NECESSARY FOR UNIVERSAL MOUNTING AND DIRECTIONAL ARROW KNOCKOUTS. ARROWS ON PLANS INDICATE DIRECTION OF CHEVRONS, SHADING INDICATES QUANTITY AND LOCATIONOF FIXTURE FACE.
- 2. ALL EXTERIOR FIXTURES AND INTERIOR FIXTURES IN UNHEATED SPACES SHALL BE CAPABLE OF OPERATING IN COLD TEMPERATURES (ZERO DEGREE FARENHEIGHT).
- 3. ALL ELECTRONIC DRIVERS SHALL HAVE A MAXIMUM TOTAL HARMONIC DISTORTION BETWEEN TEN & FIFTEEN PERCENT (10-15%).
- 4. ALL INTERIOR FIXTURES SHALL BE FURNISHED WITH 4000K COLOR LED's, AND ALL EXTERIOR LED's SHALL BE 4000k.
- 5. FURNISH ALL ADDITIONAL MATERIALS AND ACCESSORIES REQUIRED FOR A COMPLETE INSTALLATION AND BE FULLY OPERATIONAL.
- 6. FURNISH WITH NICKEL CADMIUM BATTERY FOR A MINIMUM OF 90 MINUTES OF EMERGENCY LIGHTING OPERATION. 7.) FIXTURE SHALL BE ONE LONG SIGN WITH THE WORDING "EXIT" AND THE CT APPROVED DYNAMIC HANDICAP SYMBOL ADJACENT TO IT.
- 8. ALL EQUALS MUST BE APPROVED BY THE ARCHITECT/ENGINEER OF RECORD BY A <u>POINT BY POINT CALCULATION</u>. <u>IES FILES HAVE TO BE PROVIDED FOR EACH ALTERNATE</u>
  <u>FIXTURE, THERE WILL BE NO EXCEPTIONS GRANTED</u>. ANY ALTERNATES SUBMITTED MUST NOT CONSUME MORE THEN THE WATTAGE SHOWN ON THE FIXTURE SCHEDULE, THERE
  WILL BE NO EXCEPTIONS GRANTED. ALTERNATE FIXTURES MAY VARY SLIGHTLY IN APPEARANCE & AESTHETICS PROVIDED THEY MEET THE PERFORMANCE REQUIREMENTS SHOWN ON FIXTURE SCHEDULE (FINAL APPROVAL BY LIGHTING DESIGNER AND ARCHITECT). POINT BY POINT CALCULATIONS NEED TO BE PERFORMED AND APPROVED PRIOR TO PRODUCT SUBMITTAL PACKAGE SUBMISSION.

ALL SUBSTITUTED DRIVERS OFFERED MUST BE LESS THAN OR EQUAL TO WATTAGES SHOWN ON EACH TYPE FIXTURE, NO SUBSTITUTED DRIVER WILL BE ACCEPTED THAT DOESN'T MEET THIS REQUIREMENT.

- 9. CONTRACTOR TO INCLUDE IN THEIR BASE BID THE FOLLOWING EXTRA MATERIAL: 2 PIECES - POWER PACKS - DUAL CIRCUIT
  - 2 PIECES WALL SWITCH WITH J-BOX (TOGGLE & DIMMER) 2 PIECES - JUNCTION BOXES INSTALLED (EACH SIZE)
  - 2 PIECES ROOM CONTROLLER 1 PIECE - EXIT SIGN

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# Electrical One-Line Riser Diagram 12" = 1'-0"

### CONDUCTOR NOTES:

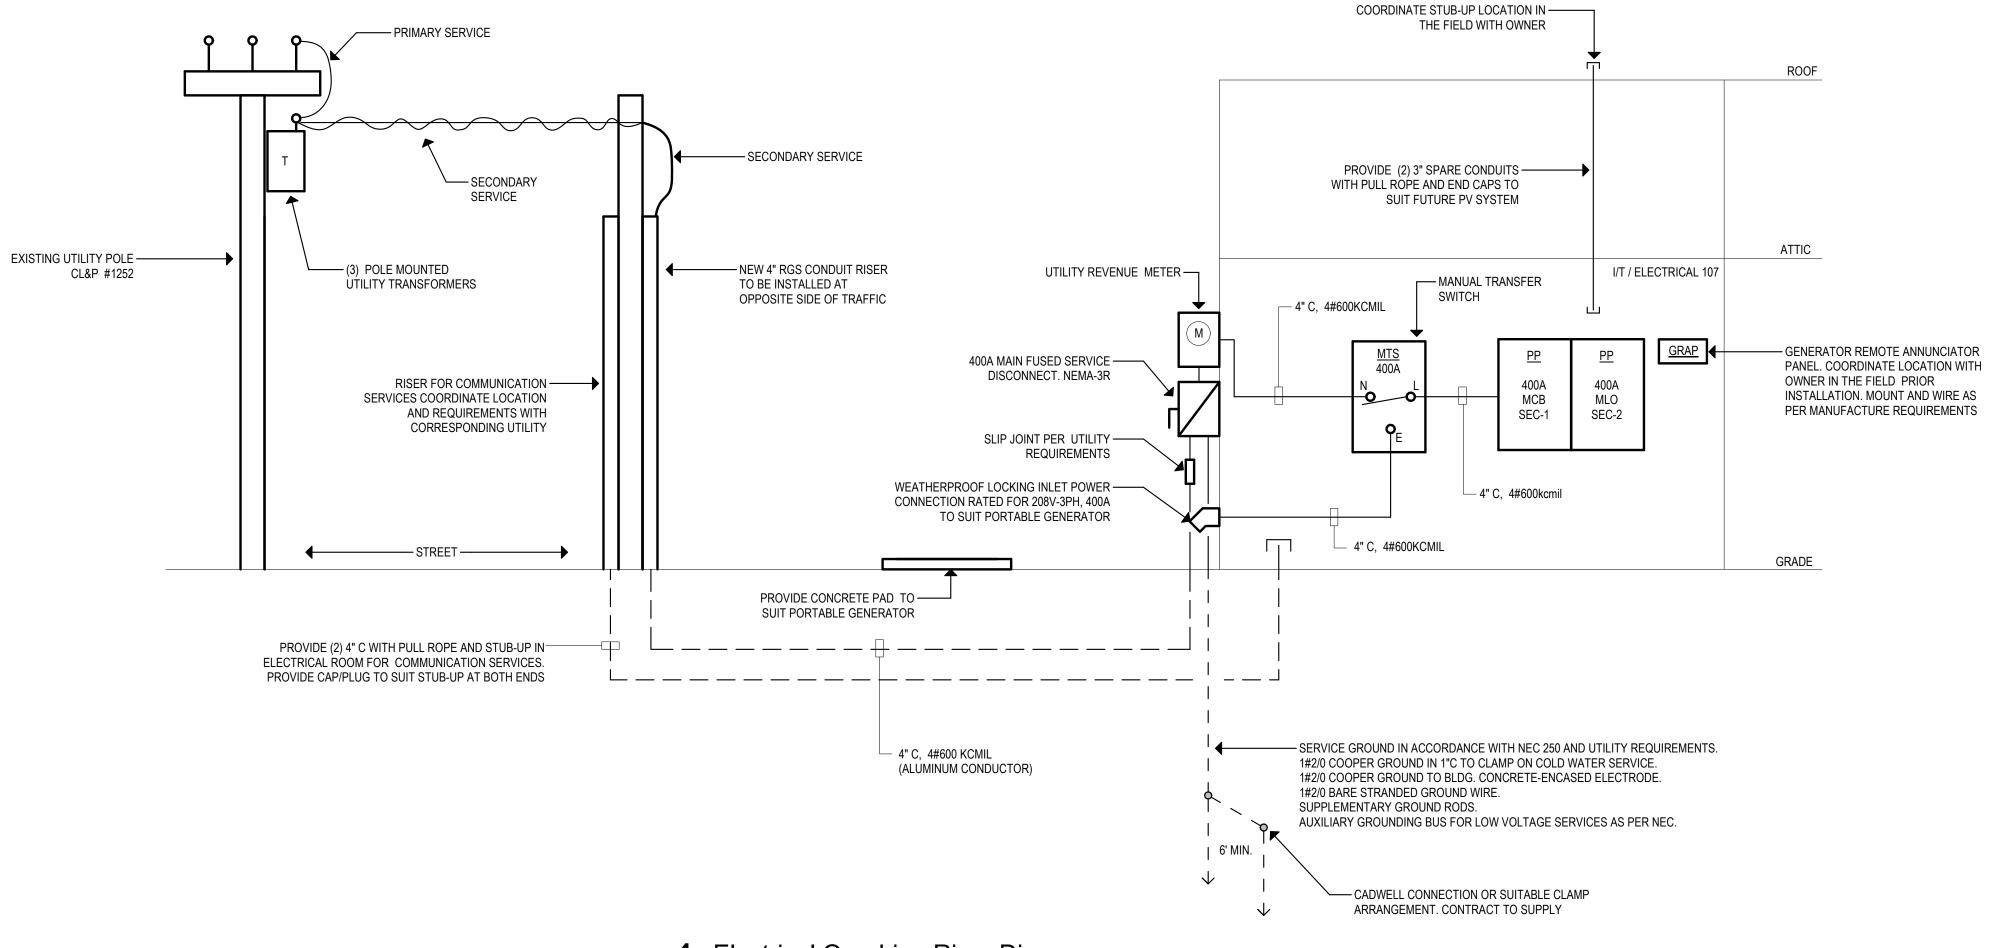- 1. UNLESS OTHERWISE INDICATED ALL VALUES BASED ON COPPER CONDUCTORS.
- <u>FEEDERS</u> UPGRADE WIRE TO MAINTAIN MAXIMUM OF 2% VOLTAGE DROP.

## BRANCH CIRCUITS UPGRADE WIRE TO MAINTAIN MAXIMUM OF 3% VOLTAGE DROP.

- 3. NUMBER OF WIRES SHALL BE DETERMINED WITH EQUIPMENT ELECTRICAL NAMEPLATE CHARACTERISTICS.
- 4. WHERE NEUTRALS ARE REQUIRED, IT SHALL MATCH FEEDER CONDUCTOR SIZE.
- 5. USE CONDUCTOR (THWN/THHN) (3PH, 3W) WITH GROUND PRIMARY FEEDER FOR TRANSFORMERS.



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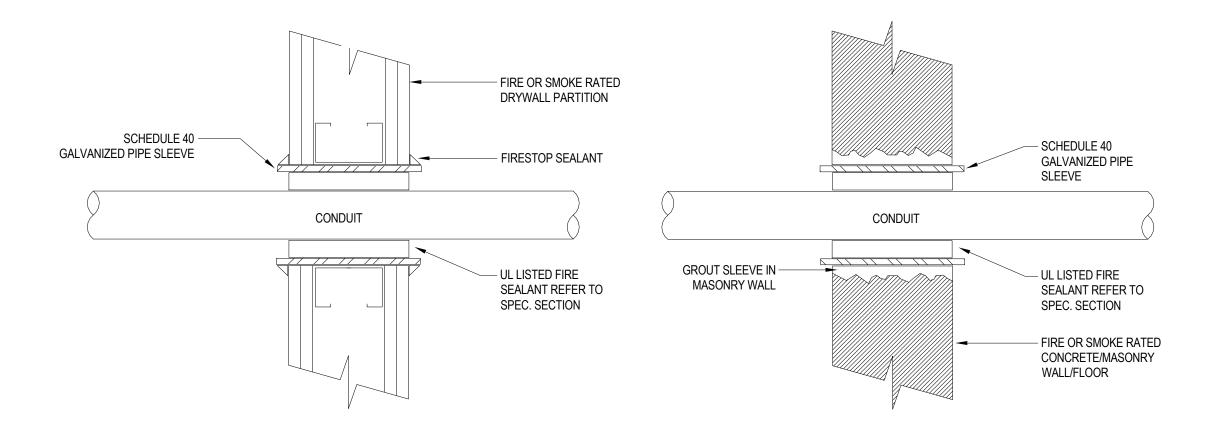
ELECTRICAL RISER DIAGRAM

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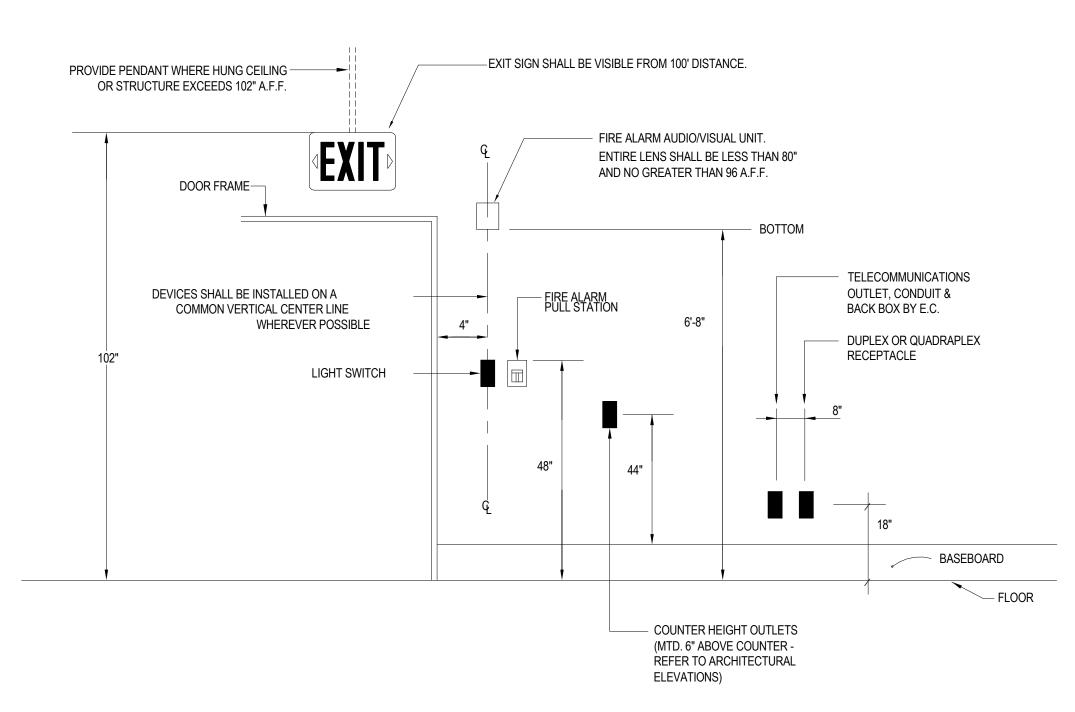


### ■ WALL/FLOOR PENETRATION W/FIRE-SMOKE SEAL DETAIL

NOT TO SCALE

### **GENERAL NOTES:**

- 1. PROVIDE UL LISTED FIRE/SMOKE PENETRATION ASSEMBLY IN ACCORDANCE W/ UL1479, ASTM E814
- REQUIREMENTS FOR WALL TYPE, RATING, PIPE SIZE INSTALLED.
- 2. FIRE STOPPING SHALL HAVE A RATING EQUAL TO OR GREATER THAN THE WALL/FLOOR BEING PENETRATED -SEE SPECIFICATIONS. REFER TO ARCHITECTURAL CODE DRAWINGS FOR WALL/FLOOR RATINGS AND LOCATIONS.
- 3. AT NON-RATED ASSEMBLIES INFILL ANNULAR VOID WITH MINERAL WOOL AND CAP WITH SEALANT.




## OUTLET MOUNTING DETAIL

(TYP. ALL OUTLETS UNLESS OTHERWISE NOTED.)


NOTES:

- 1. ALL MOUNTING HEIGHTS SHALL BE MEASURED FROM FIN. FLOOR TO CENTERLINE OF DEVICE (EXCEPT FOR EXIT SIGNS, FIRE ALARM PULL STATION AND LIGHTING SWITCH).
- 2. DEVICES SHALL BE INSTALLED ON A COMMON VERTICAL CENTERLINE WHEREVER POSSIBLE.
- 3. ALL DEVICES SHALL BE INSTALLED AT THE MOUNTING HEIGHTS INDICATED ON THIS DETAIL, UNLESS OTHERWISE NOTED. REFER TO ARCHITECTURAL INTERIOR ELEVATIONS FOR MOUNTING
- 4. THE LOCATION OF WALL OUTLETS ARE DIRECTLY RELATED TO THE FURNITURE LOCATION. SPECIAL ATTENTION SHALL BE GIVEN TO LOCATING OUTLETS PER THIS DETAIL. DO NOT INSTALL OUTLETS BACK TO

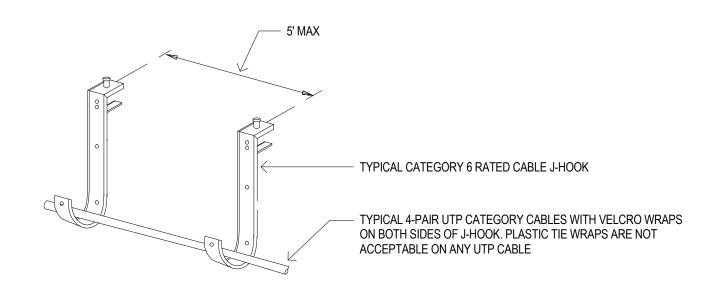


## TYPICAL DATA J-HOOK INSTALLATION


NOTES: J-HOOKS SHALL BE SIZED TO ACCOMMODATE TWICE AS MANY CABLES REQUIRED TO BE SUPPORTED INCLUDING AN ADDITIONAL 40% HEADROOM.

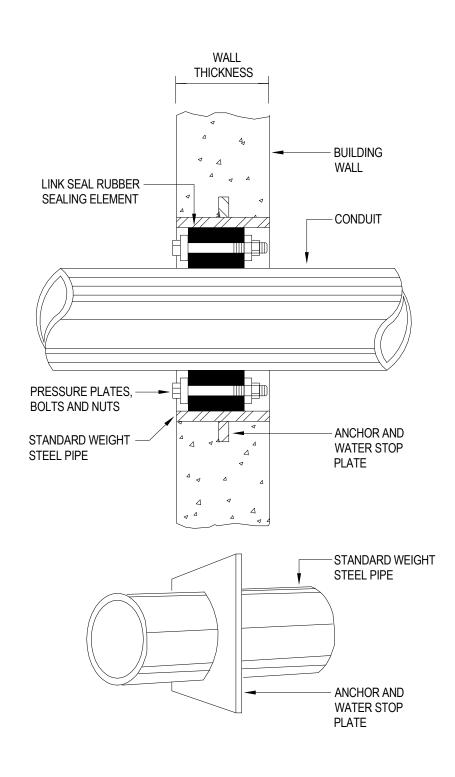


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# DATA OUTLET RECESSED RACEWAY DETAIL

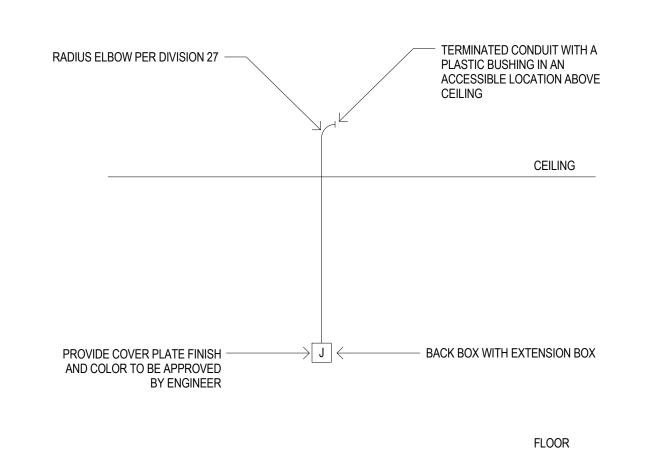

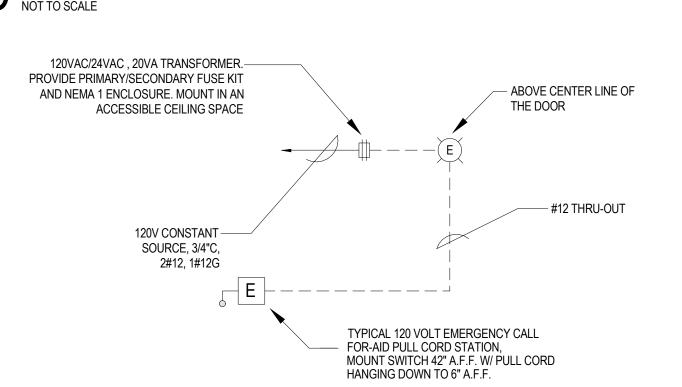


## **7** COMMUNICATION PATCH PANEL - DATA LABELING

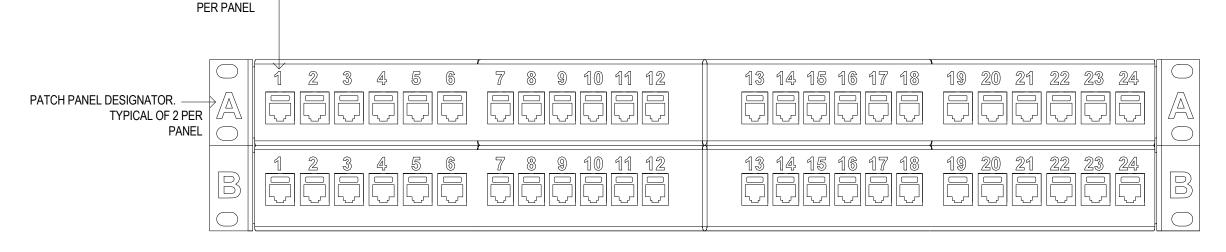
NOT TO SCALE

MANUFACTURER'S PORT — DESIGNATOR TYPICAL OF 24


## NOTES:

- 1. LABEL PATCH PANELS FROM TOP TO BOTTOM AS "A", "B", "C", "D" AS REQUIRED. REQUIRED ON LEFT AND RIGHT SIDE OF PATCH PANEL AS SHOWN.
- 2. CONTRACTOR MUST CONFIRM LABELING SCHEME WITH THE OWNER PRIOR TO TESTING AND FINAL LABELING OF ALL VOICE, DATA CABLING.

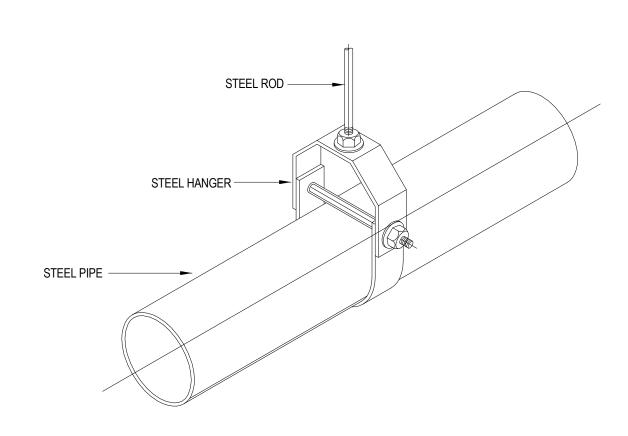

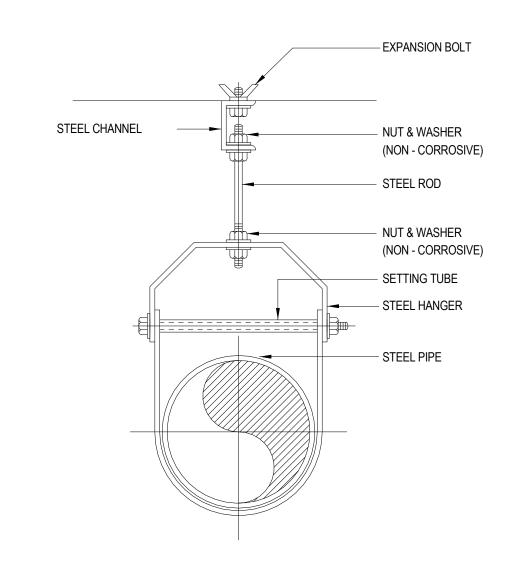

# 8 PIPE HANGER DETAIL NOT TO SCALE

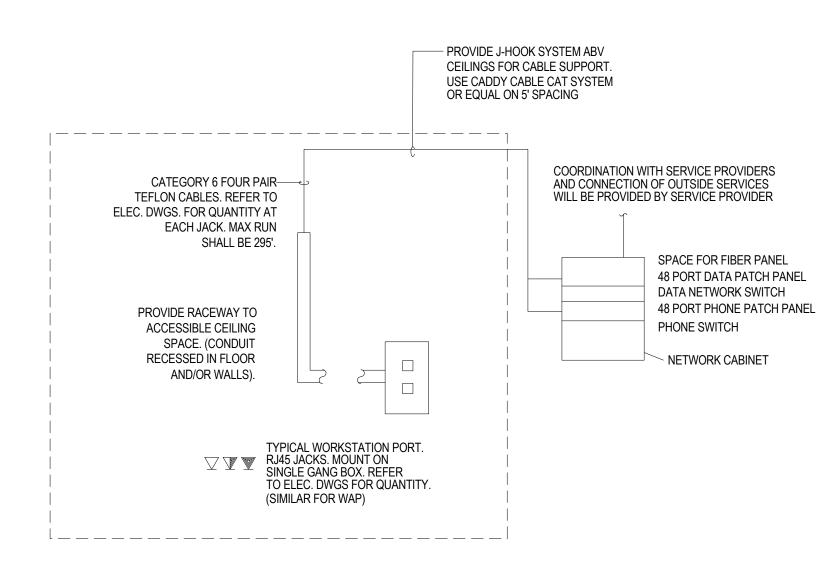

- 1. CONTRACTOR IS RESPONSIBLE FOR SUPPLYING AND INSTALLING ALL EQUIPMENT, CAT6 WIRING, AND WIRING FROM CORRESPONDING I/T CABINET OR
- 2. PHONE AND DATA SYSTEMS SHALL BE INSTALL AND TESTED. TESTING OF CAT 6 CABLES AND INSTALLATION AND IDENTIFICATION OF JACKS AT LOCATIONS SHOWN ON DRAWINGS, TERMINATION OF CABLES AT CABINET MOUNTED PATCH AND SWITCH PANELS. INSTALLATION AS LISTED ABOVE INDICATES RESPONSIBILITY TO FURNISH, INSTALL, TEST AND WARRANTY THE

NEW ANIMAL FACILITY AT: MONTVILLE ANIMAL SHELTER 225 Maple Ave. Parcel ID: 077-041-000 Montville, CT




SILVER PETRUCELLI + ASSOCIATES

silverpetrucelli.com

ELECTRICAL DETAILS

Drawing Number: 09/27/2024 E601 Project Number: 22.130

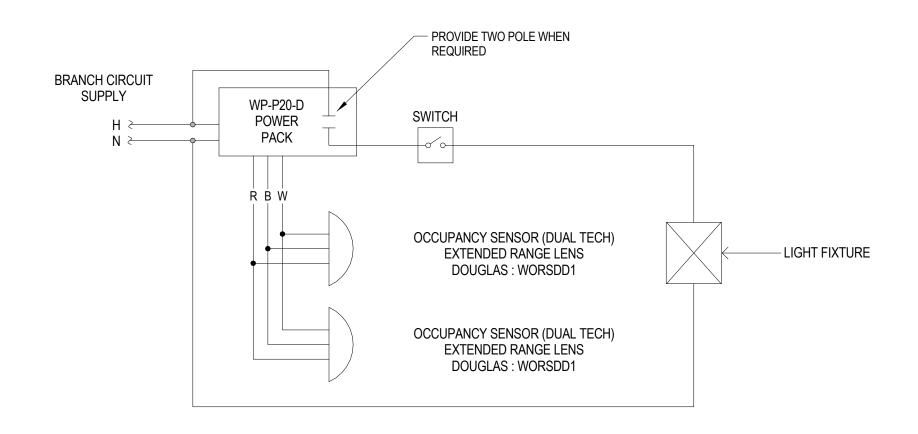


## CEILING MULTIPLE OCCUPANCY SENSOR DETAIL

NOT TO SCALE

NOTE:


- 1. TYPICAL CEILING OCCUPANCY SENSOR SUIT CORRIDORS AND ROOMS WITHOUT DAYLIGHT PHOTOSENSOR AND DIMMING SWITCHES
- 2. EXACT QUANTITY OF DEVICES MAY DIFFER FROM THIS DETAIL CONTRACTOR SHALL PROVIDE ACTUAL QUANTITY REQUIRED. REFER TO LIGHTING FLOOR PLAN.
- 3. OCCUPANCY SENSOR WITH LETTER "W" NEXT TO SYMBOL ARE TO BE CORNER/WALL MOUNTED.

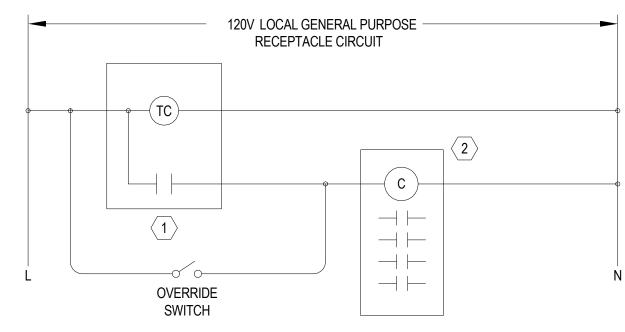

LOCATED ADJACENT TO TIME CLOCK #POLES: 4 CIRCUIT#: REFER TO LIGHTING SITE PLAN SHEET SE-3

<u>TAG</u>	<u>DESCRIPTION</u>	MODEL NO.	REMA
1	DIGITAL PROGRAMMABLE TIME CLOCK 24HR, 7DAY 365DAY, SEASONAL SCHEDULING, 99 ON/OFF POINTS, PERMANENT SCHEDULE RETENTION ON POWER LOSS, POWER OUTAGE BACKUP, AUTOMATIC LEAP YEAR AND DAYLIGHT SAVINGS TIME ADJ., MECHANICALLY HELD CONTACTS, MULTI VOLTAGE INPUT.	TORK DZS100A OR EQUIVALENT INTERMATIC OR SQUARE D	1,2
<b>(2)</b>	CONTACTOR ELECTRICALLY OPERATED, MECHANICALLY HELD, 20A LIGHTING CONTACTOR. CONTROL VOLTAGE AS LISTED, FROM LOCAL GENERAL PURPOSE RECEPTACLE CIRCUIT.	ASCO 917 SERIES WITH 2 WIRE CONTROL OPTION OR EQUIVALENT GE OR SQUARED	


# 2 LIGHTING TIME CLOCK AND CONTACTOR DIAGRAM NOT TO SCALE

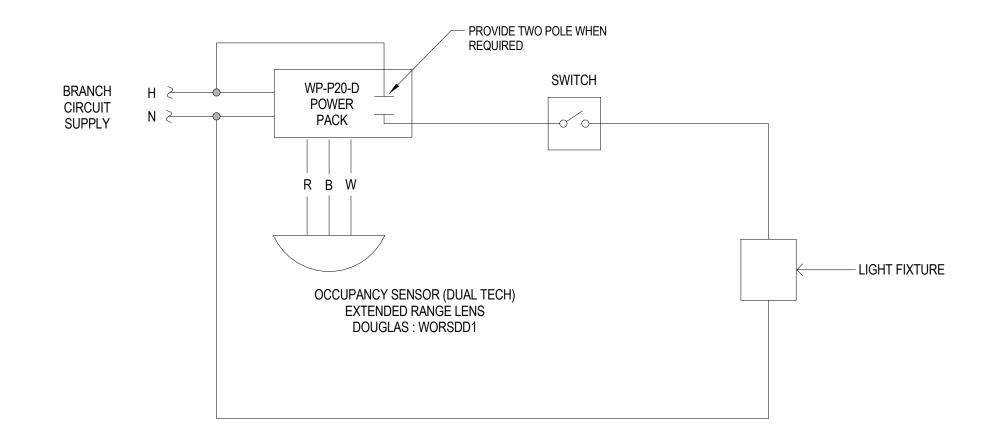

# CEILING OCCUPANCY SENSOR DETAIL

NOT TO SCALE

- 1. TYPICAL CEILING OCCUPANCY SENSOR SUIT CORRIDORS AND ROOMS WITHOUT DAYLIGHT PHOTOSENSOR AND DIMMING SWITCHES
- 2. EXACT QUANTITY OF DEVICES MAY DIFFER FROM THIS DETAIL CONTRACTOR SHALL PROVIDE ACTUAL QUANTITY REQUIRED. REFER TO LIGHTING FLOOR PLAN.
- 3. OCCUPANCY SENSOR WITH LETTER "W" NEXT TO SYMBOL ARE TO BE CORNER/WALL MOUNTED.

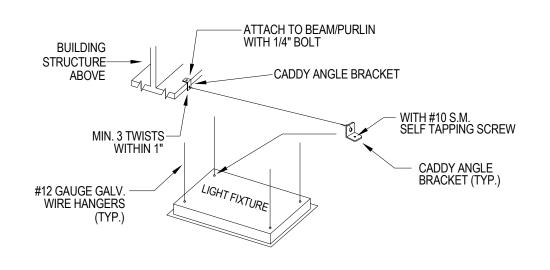

# 4 TYPICAL LAY-IN GRID LIGHTING FIXTURE SUPPORT/MOUNTING DETAIL NOT TO SCALE


1. ALL LIGHTING FIXTURES SHALL BE SECURED TO THE STRUCTURE BY THE


- ELECTRICAL CONTRACTOR. FLUSH OR RECESSED LIGHT FIXTURES LESS THAN 56 POUNDS SHALL HAVE
   12 GA. SLACK SAFETY WIRES FROM DIAGONAL CORNERS TO BUILDING STRUCTURE BY TRADE CONTRACTOR.
- 3. FLUSH OR RECESSED LIGHT FIXTURES MORE THAN 56 POUNDS SHALL HAVE 4 - 12 GA. SLACK SAFETY WIRES FROM DIAGONAL CORNERS TO BUILDING STRUCTURE BY TRADE CONTRACTOR.
- 4. SECURE SURFACE MOUNTED LIGHT FIXTURES W/ MINIMUM OF 2 POSITIVE CLAMPING DEVICES OF 14 GA. MINIMUM STEEL AND W/ 12 GA. WIRE TO

BUILDING STRUCTURE.

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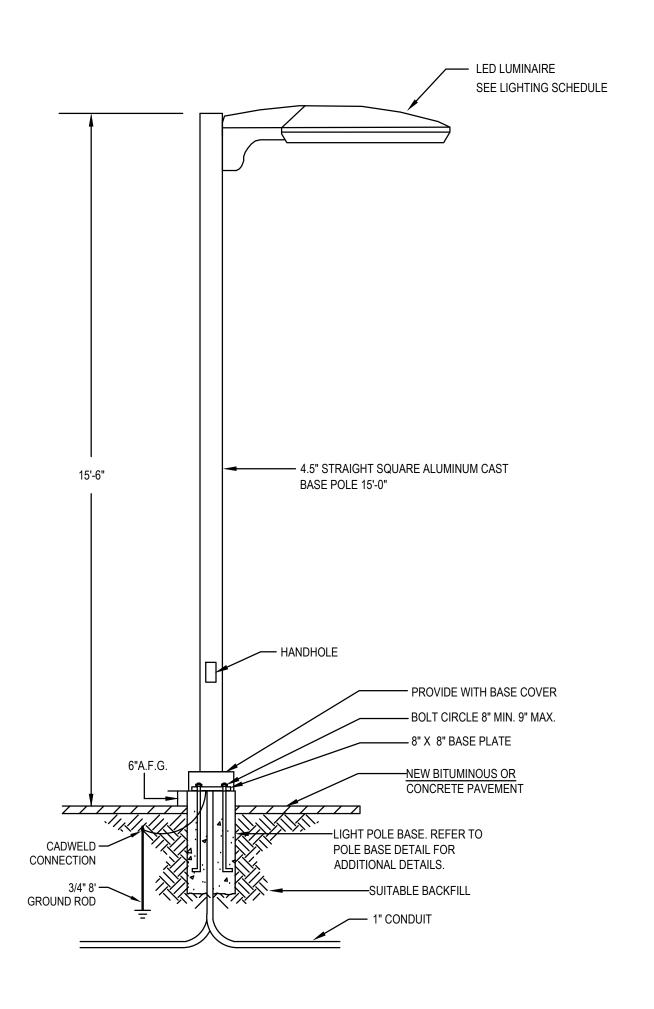



### LIGHTING FIXTURE SCHEDULE

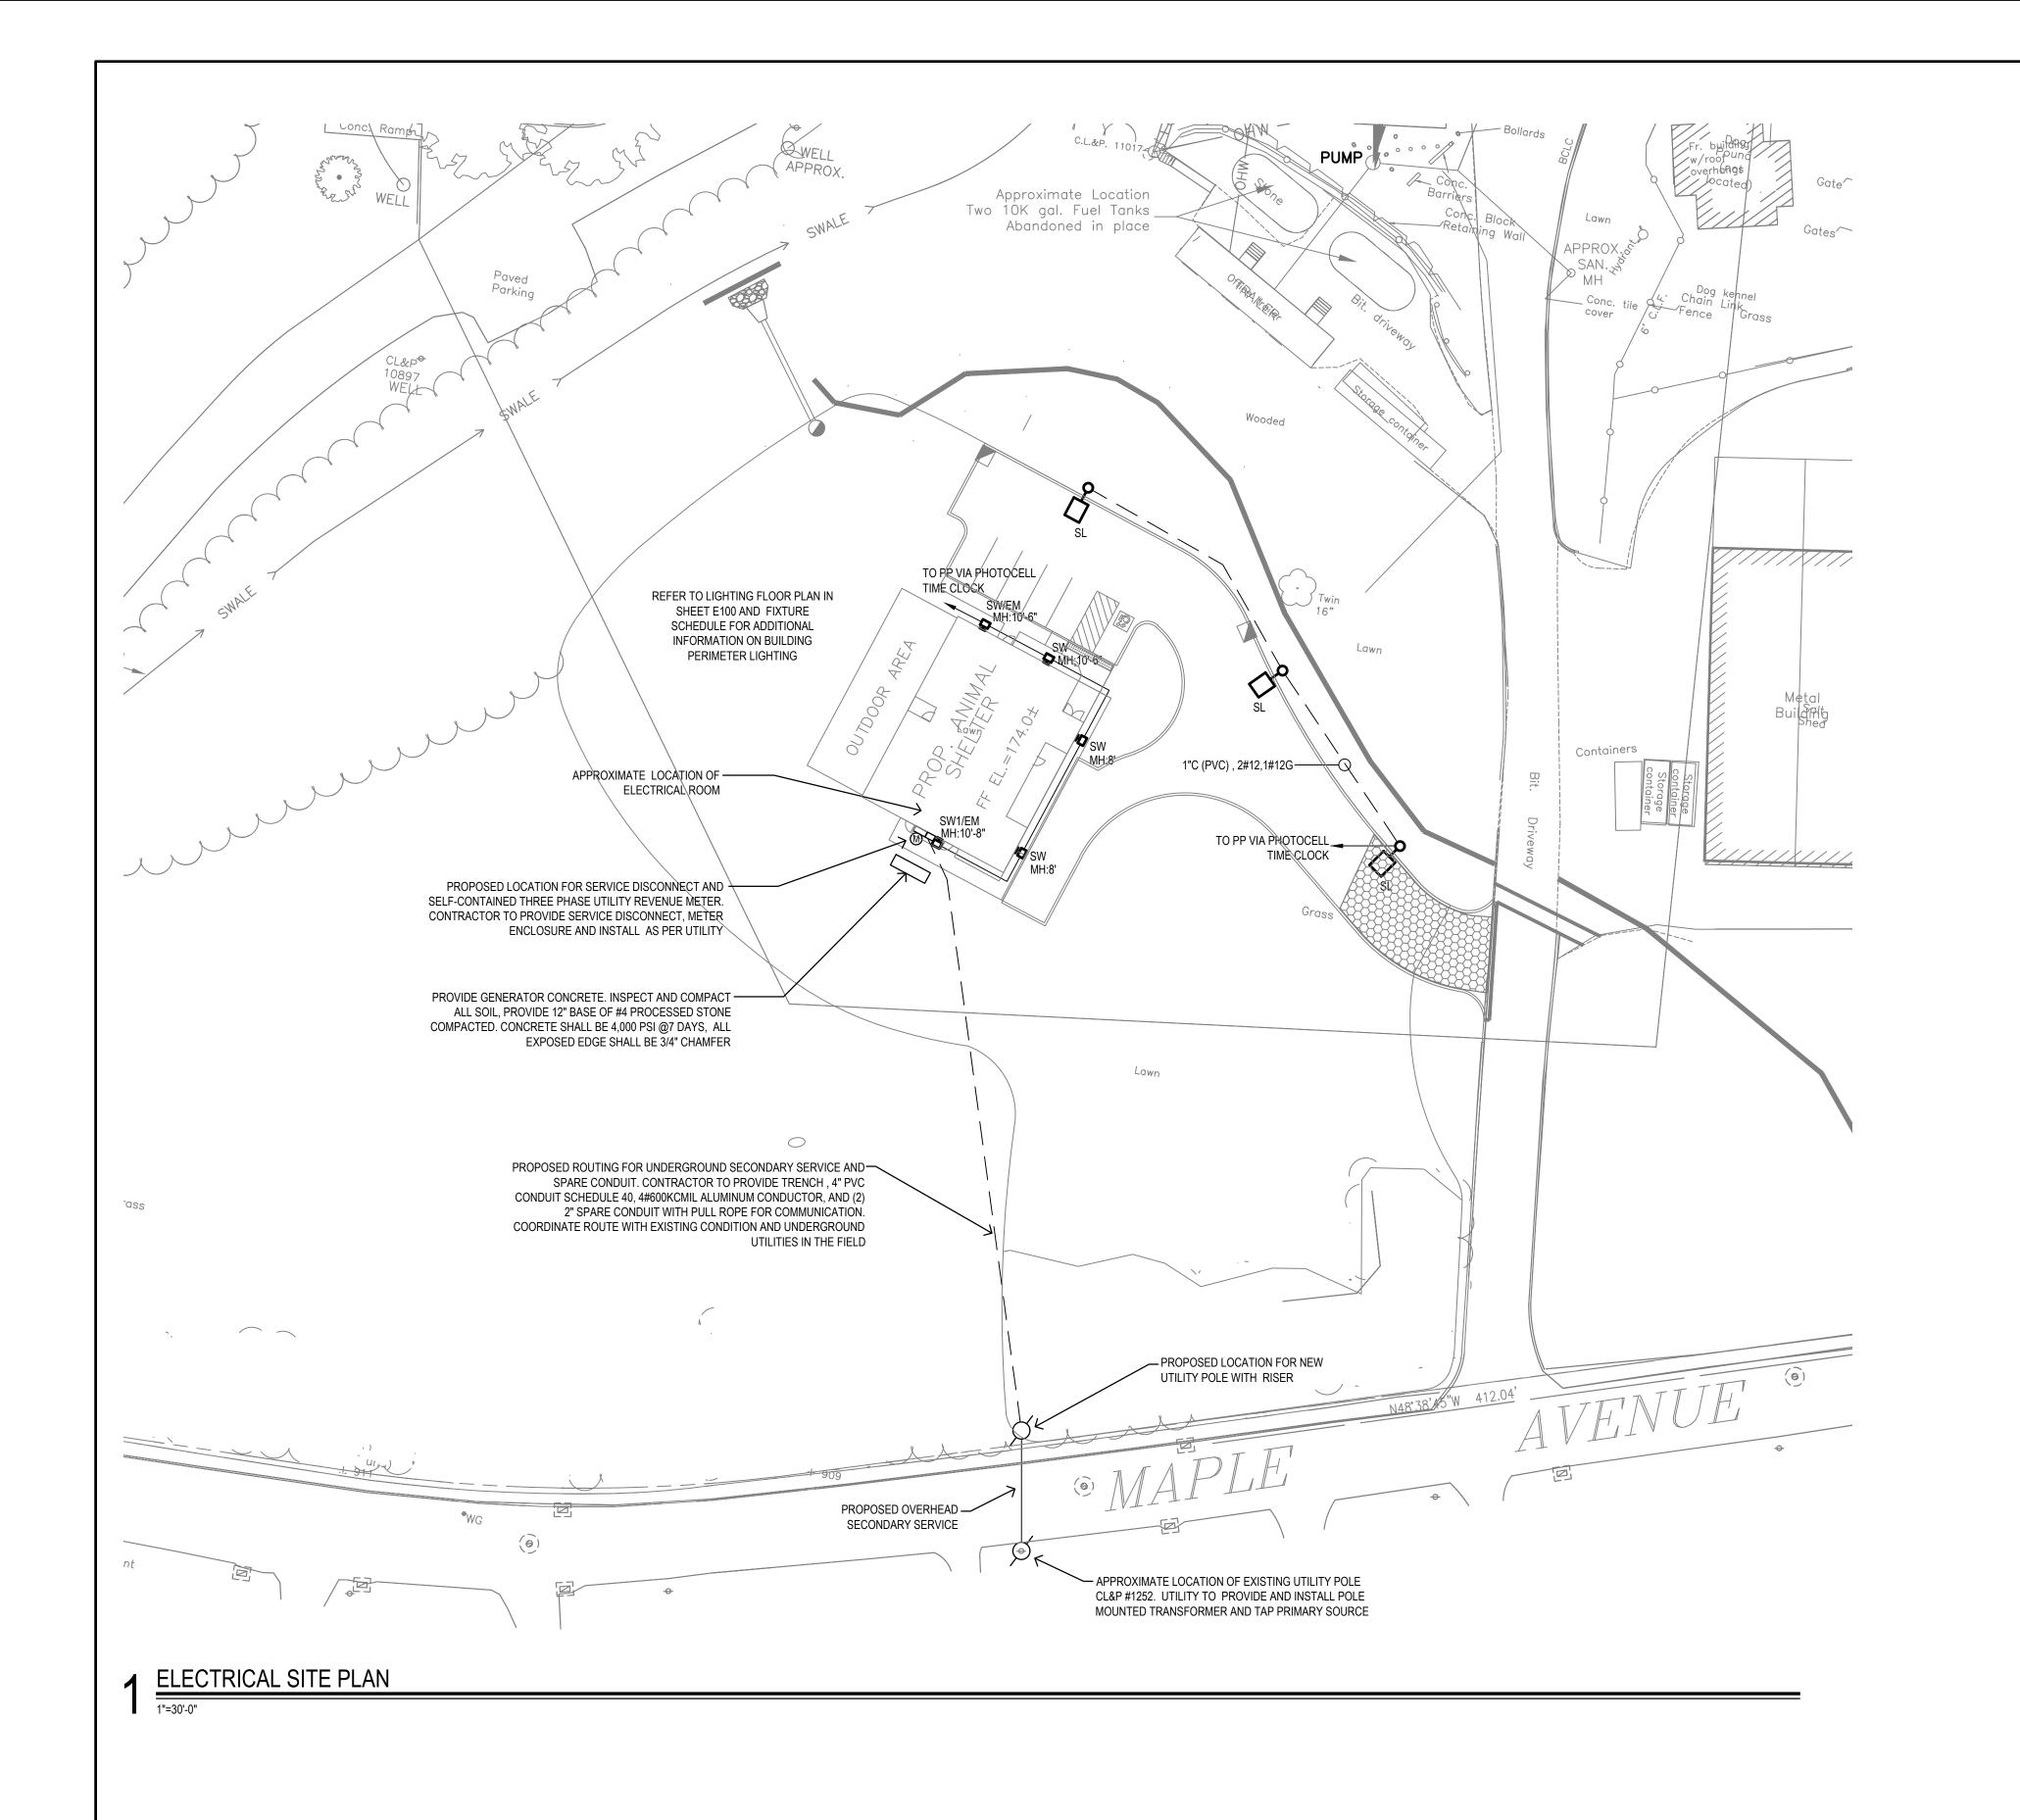- PROVIDE BACKING PLATE, FOAM GASKET, MOUNTING PLATE, ARM ADAPTER, ALL ASSEMBLY REQUIRED, AND ALL ADDITIONAL MATERIALS AND ACCESSORIES REQUIRED FOR COMPLETE INSTALLATION TO BE FULLY OPERATIONAL.
- 2. ALL FIXTURES SHALL BE CAPABLE OF OPERATING IN COLD TEMP (0° F).
- 3. ALL LIGHTING FIXTURE SHALL BE ULLISTED FOR WET LOCATIONS.
- (4.) FIXTURE TO BE PROVIDED WITH INTEGRATED BUTTON PHOTOCONTROL

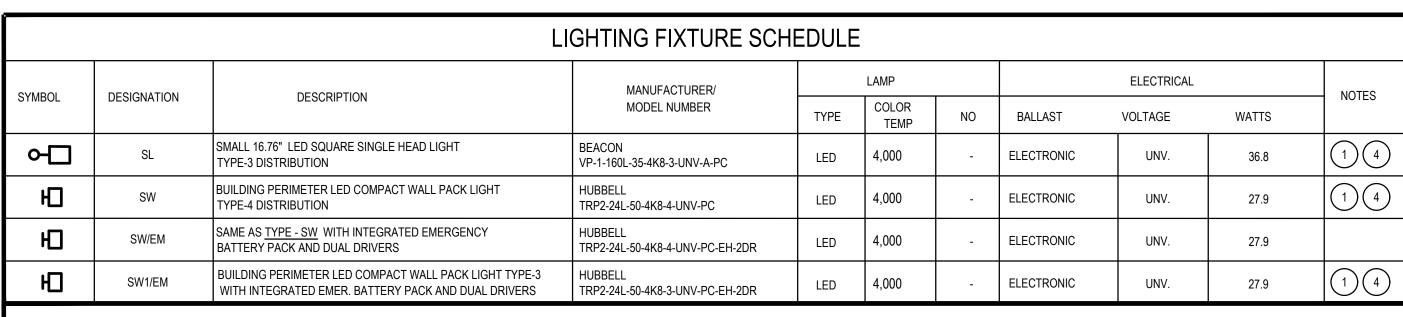SYMBOL AND ABBREVIATION:

MH MOUNTING HEIGHT.




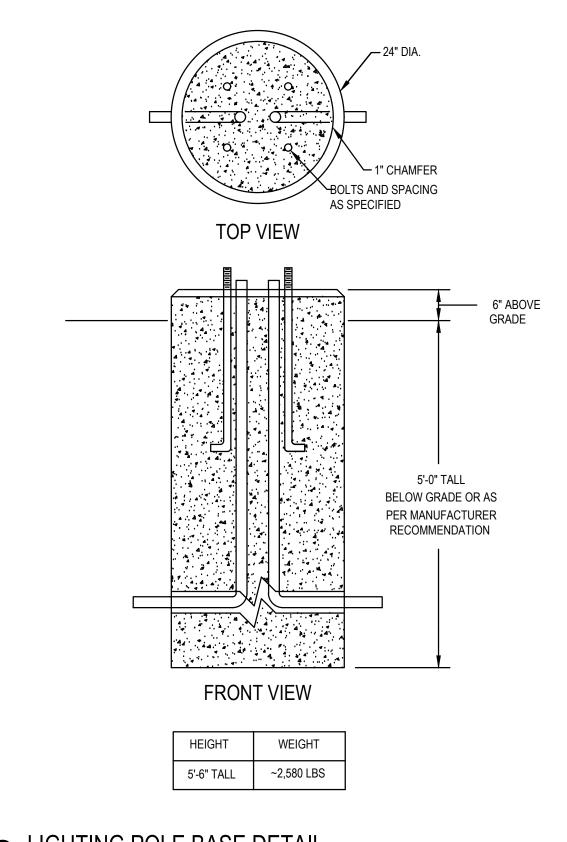

# 2 LIGHTING POLE BASE DETAIL NOT TO SCALE

DESIGN NOTES:

- 1 CONCRETE 4000 PSI AT 28 DAYS.
- 2 REINFORCING IS AS SPECIFIED. (TYP. 4 #5) VERTICALLY AND #3 STIRRUPS 12" O.C. HORIZONTALLY)
- 3 ANCHOR BOLTS AND GROUNDING AS SPECIFIED.
- 4 BALLAST POURED AROUND BASE IF REQUIRED. 5 - BOLT PROJECTION AS SPECIFIED BY POLE MANUFACTURER.

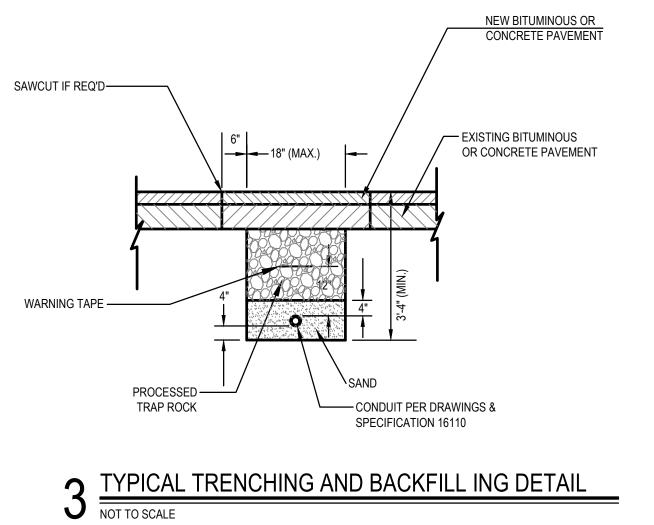

1. FOR NEW BITUMINOUS PROVIDE: 1-1/2" COMPACTED BITUMINOUS CONCRETE CLASS 2 OVER 2-1/2" BITUMINOUS CONCRETE CLASS 1.

WARNING TAPE ----

1 POLE MOUNTED LUMINAIRE DETAIL


NOT TO SCALE

TYPICAL TRENCHING AND BACKFILL ING DETAIL

RETURN LANDSCAPING TO

ORIGINAL CONDITION

CONDUIT PER DRAWINGS & SPECIFICATIONS

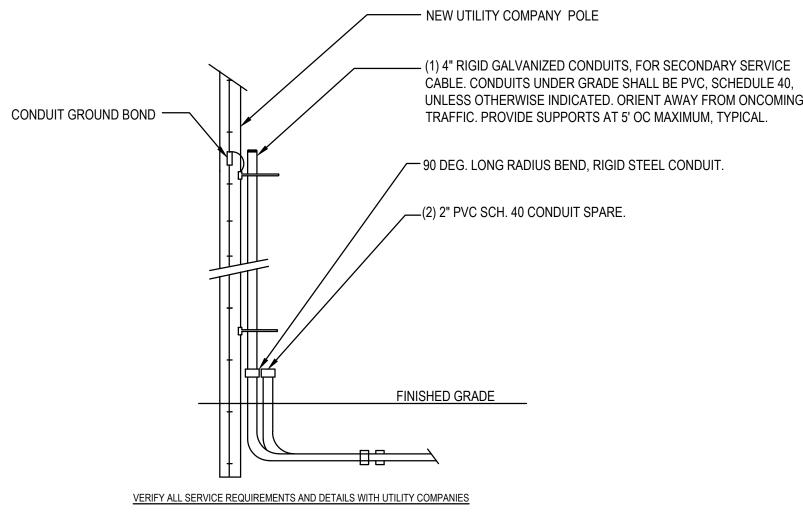

SERVICE POLE DETAILS

CALL BEFORE YOU DIG 1-800-922-4455 OR 811 CALL NO LESS THAN TWO FULL WORKING DAYS AND NO MORE THAN 30 DAYS PRIOR TO START OF EXCAVATION MONDAY THRU FRIDAY, 7AM TO 5PM

23.130

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SILVER PETRUCELLI + ASSOCIATES

3190 WHITNEY AVENUE HAMDEN CT 06518 203 230 9007 silverpetrucelli.com

Date: 09/27/2024

ELECTRICAL SITE PLAN

Drawing Number: ES100