

LEVELING

FINISH PAVEMENT GRADE

- COMPACTED

CONCRETE


BARRIER FREE SIGN BOLLARD DETAIL


GRANULAR BACKFILL


- 18" DIA. SONOTUBE


- UNDISTURBED SUBGRADE

FILLED WITH 3000 PSI

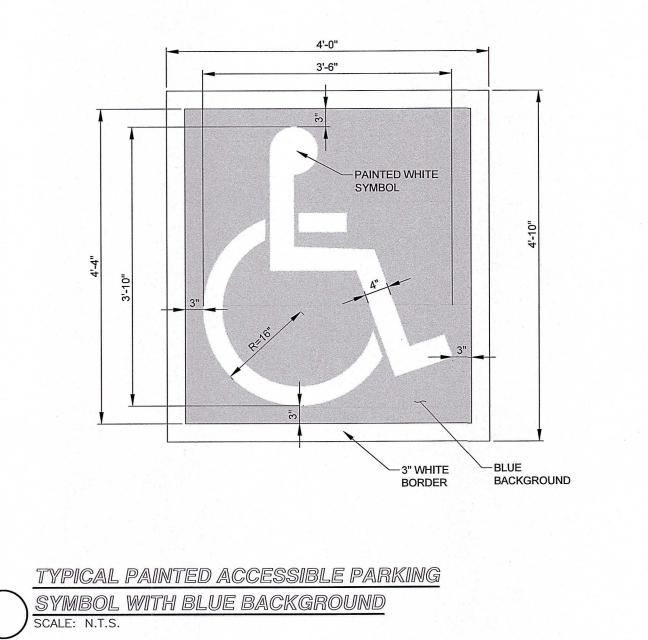

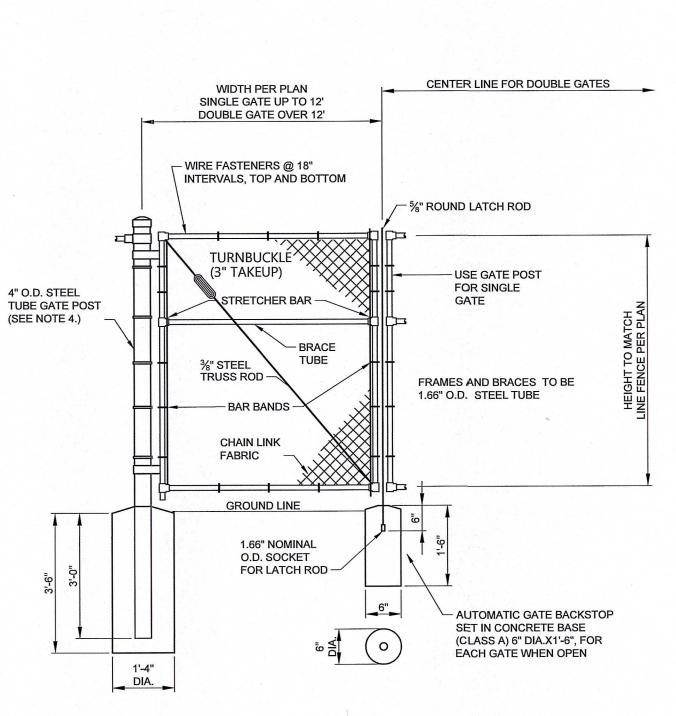

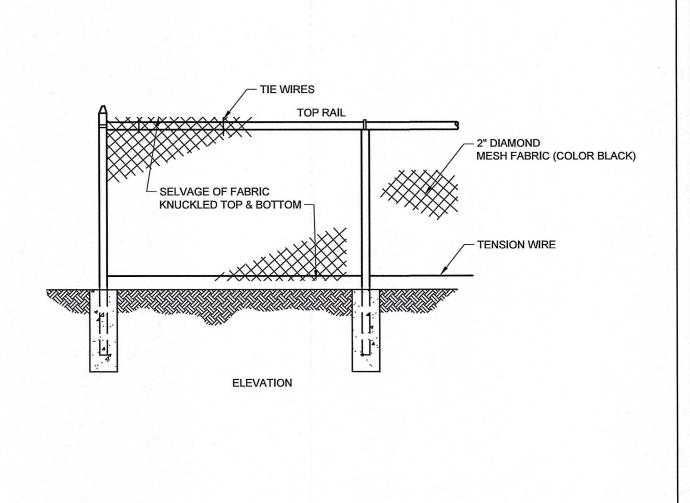


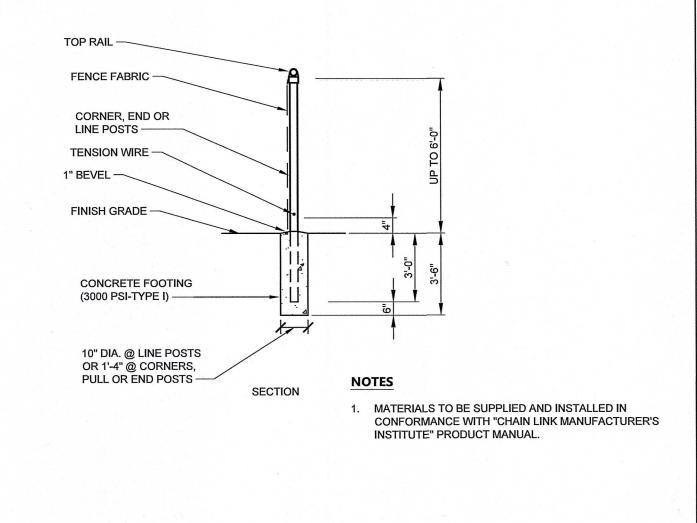

SIGNATURE BLOCK

4' CHAINLINK FENCE

RJOC

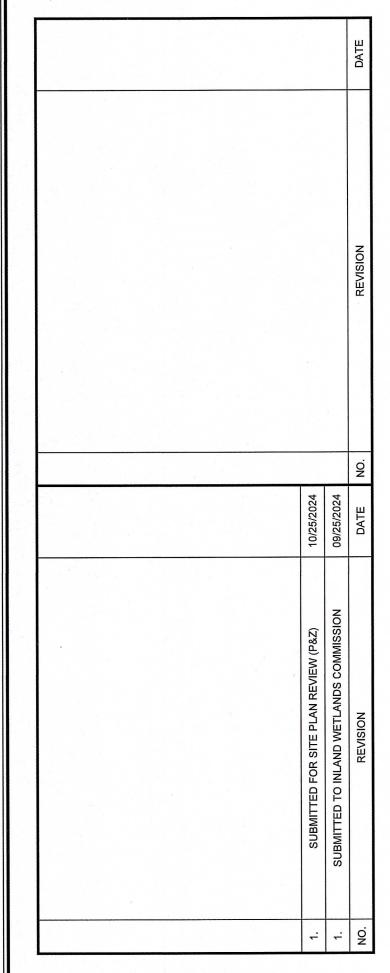

RJO'CONNELL & ASSOCIATES, INC.

CIVIL ENGINEERS, SURVEYORS & LAND PLANNERS
80 MONTVALE AVENUE, SUITE 201 STONEHAM, MA 02180
PHONE: 781.279.0180 RJOCONNELL.COM


PREPARED FOR:



20 AVON MEADOW LANE AVON, CT 06001

PROJECT NAME:

HORIZON VIEW
MONTVILLE, CT

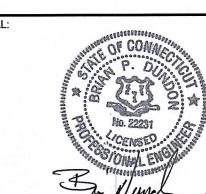

DESIGNED BY:

DRAWN BY:

REVIEWED BY:

SCALE:

DATE:

DRAWING NAME:

PARKING AND TRAFFIC CONTROL DETAILS II

DRAWING NUMBER:

PROJECT NUMBER:

C-10

Copyright © 2024 by R.J. O'Connell & Associates, Inc.

1. CHAIN LINK FABRIC FOR GATES TO BE THE SAME AS REQUIRED FOR FENCE.

GATE POST BASE-PORTLAND CEMENT CONCRETE (3000 PSI).

. GATE POSTS TO BE USED ON EACH SIDE OF SINGLE AND DOUBLE GATE OPENINGS.

CHAINLINK FENCE GATE
SCALE: N.T.S.

VARIES

ENGINEER)

-CRUSHED

STONE LEVELING

1. THE CONTRACTOR IS RESPONSIBLE FOR PAYING ALL COSTS ASSOCIATED

TYPICAL GRAVITY "DESIGN BUILD" WALL

SET OF RETAINING WALL PLANS FOR REVIEW OF DIMENSIONAL REQUIREMENTS PRIOR TO INSTALLATION OF THE WALL. DESIGN OF

(REDI-ROCK OR APPROVED EQUAL)

HIGHWAY ADMINISTRATION CRITERIA.

SCALE: N.T.S.

WITH RETAINING WALL SHOP DRAWINGS THAT HAVE BEEN PREPARED BY A

LICENSED ENGINEER. THE CONTRACTOR WILL SUBMIT TO THE ENGINEER A

RETAINING WALL TO INCLUDE A GLOBAL STABILITY ANALYSIS USING FEDERAL

(AS SPECIFIED BY

PERFORATED SOCK DRAIN

119 GRISWOLD STREET

SUITE 209 GLASTONBURY, CT 06033 t. 203.592.4788

www.m-d-l-a.com

B&B, MULTI-STEM, SPECIMEN

B&B, 6' CLEAR BRANCHING

B&B, SPECIMEN

B&B

B&B

48" O.C.; B&B

48" O.C.; B&B

36" O.C.; B&B

42" O.C.; B&B

48" O.C.; B&B

48" O.C.; B&B

36" O.C.; B&B

7-8' HT.

3-3.5" CAL.

3-3.5" CAL.

6-7' HT.

5 GAL.


3 GAL.

9/25/24 INLAND WETLANDS SUBMISSION

LANDSCAPE PLANTING PLAN

plot date: 9/24/2024

SHEET 1

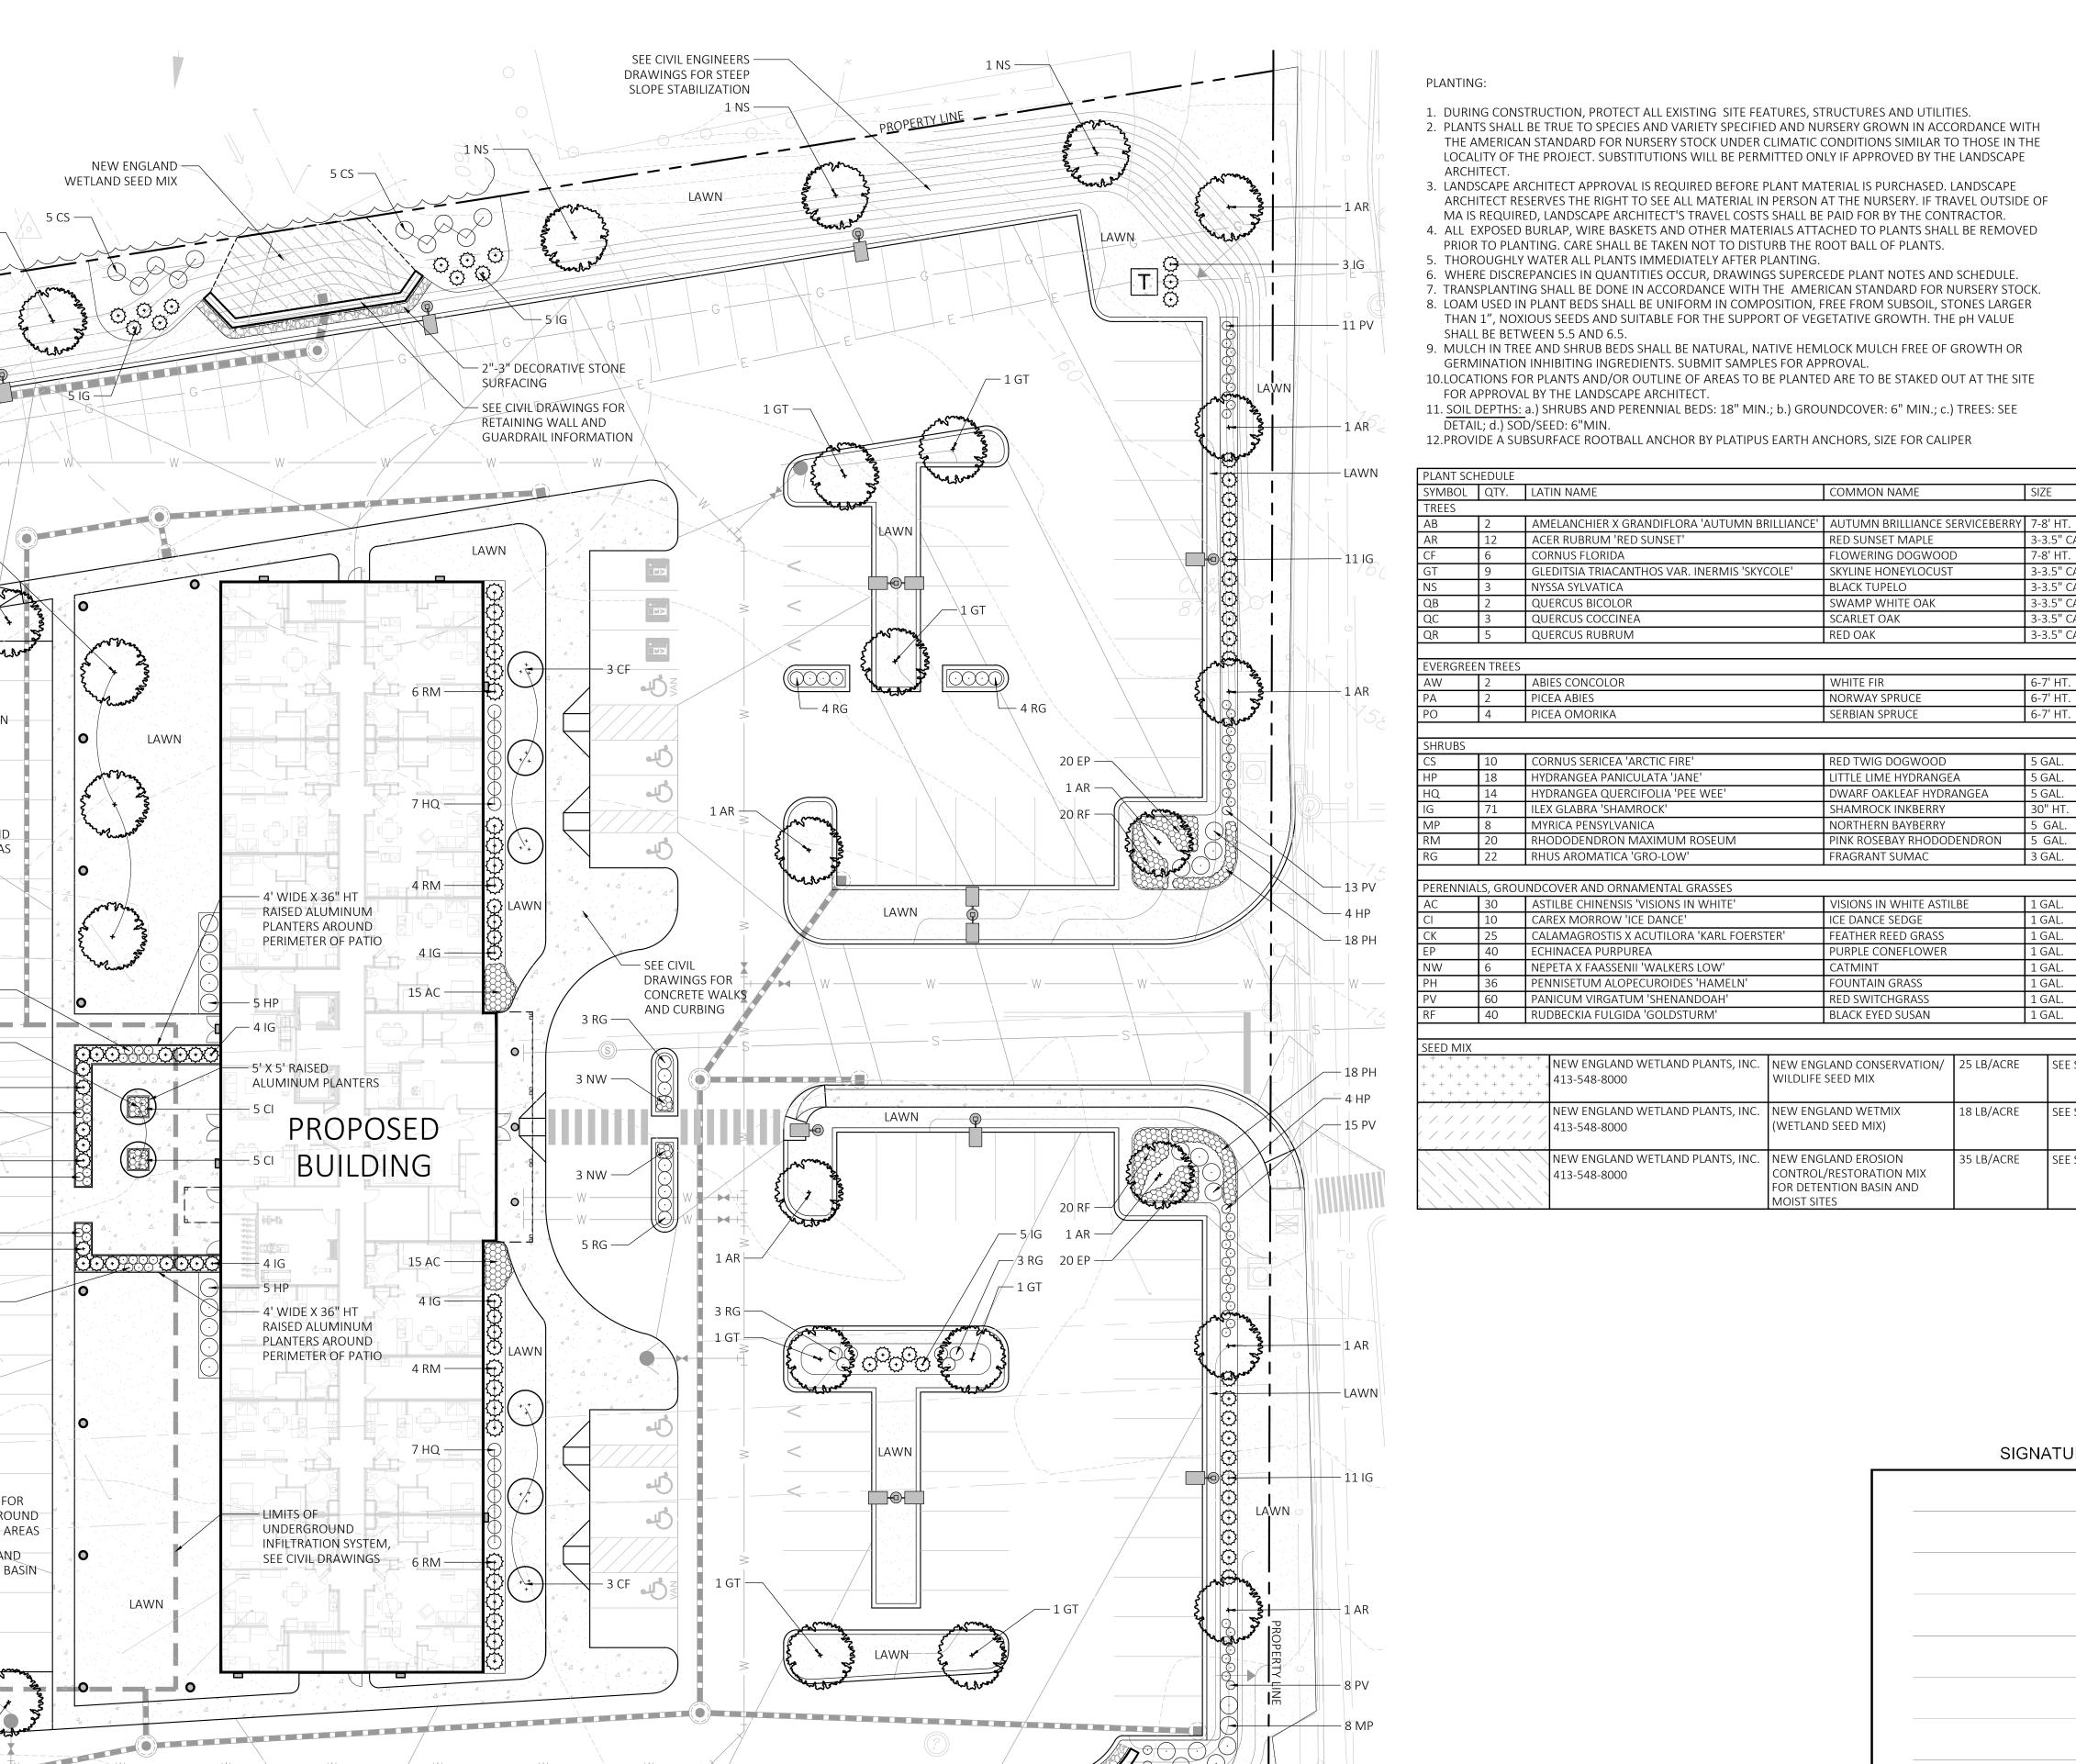

- 2"-3" DECORATIVE STONE

- SEE CIVIL DRAWINGS FOR RETAINING

WALL AND GUARDRAIL INFORMATION

SURFACING

PICEA ABIES PICEA OMORIKA CORNUS SERICEA 'ARCTIC FIRE' IYDRANGEA PANICULATA 'JANE' IYDRANGEA QUERCIFOLIA 'PEE WEE' II FX GLABRA 'SHAMROCK' MYRICA PENSYLVANICA RHODODENDRON MAXIMUM ROSEUM RHUS AROMATICA 'GRO-LOW'

 \mathbb{Z}

GLEDITSIA TRIACANTHOS VAR. INERMIS 'SKYCOLE'

PERENNIALS, GROUNDCOVER AND ORNAMENTAL GRASSES 30 ASTILBE CHINENSIS 'VISIONS IN WHITE' VISIONS IN WHITE ASTILBE 18" O.C.; CONTAINER 18" O.C.; CONTAINER ICE DANCE SEDGE CAREX MORROW 'ICE DANCE' CALAMAGROSTIS X ACUTILORA 'KARL FOERSTER' FEATHER REED GRASS 24" O.C.; CONTAINER PURPLE CONEFLOWER 18" O.C.; CONTAINER ECHINACEA PURPUREA CATMINT 18" O.C.; CONTAINER NEPETA X FAASSENII 'WALKERS LOW' FOUNTAIN GRASS PENNISETUM ALOPECUROIDES 'HAMELN' 24" O.C.; CONTAINER PANICUM VIRGATUM 'SHENANDOAH' RED SWITCHGRASS 24" O.C.; CONTAINER

COMMON NAME

RED SUNSET MAPLE

FLOWERING DOGWOOD

SKYLINE HONEYLOCUST

SWAMP WHITE OAK

SCARLET OAK

RED OAK

WHITE FIR NORWAY SPRUCE

SERBIAN SPRUCE

RED TWIG DOGWOOD

SHAMROCK INKBERRY

NORTHERN BAYBERRY

FRAGRANT SUMAC


TTLE LIME HYDRANGEA

WARF OAKLEAF HYDRANGEA

PINK ROSEBAY RHODODENDRON

. •		1711100111 11100111 311211/11120/111		THE STATE OF THE S		1 0/12.	21 0.0., 001117 1111211	
RF	40 RUDBECKIA FULGIDA 'GOLDSTURM'			BLACK EYED SUSAN		1 GAL.	18" O.C.; CONTAINER	
SEED M	IX							
+ + NEW ENGLAND WETLAND PLANTS, INC. + + + + + 413-548-8000	NEW ENGL WILDLIFE S	AND CONSERVATION/ EED MIX	25 LB/ACRE	SEE SPEC SHI	EET	
		NEW ENGLAND WETLAND PLANTS, INC. 413-548-8000	NEW ENGL (WETLAND	AND WETMIX SEED MIX)	18 LB/ACRE	SEE SPEC SHI	EET	
		NEW ENGLAND WETLAND PLANTS, INC. 413-548-8000	CONTROL/	AND EROSION RESTORATION MIX TION BASIN AND S	35 LB/ACRE	SEE SPEC SHI	EET	

SIGNATURE BLOCK

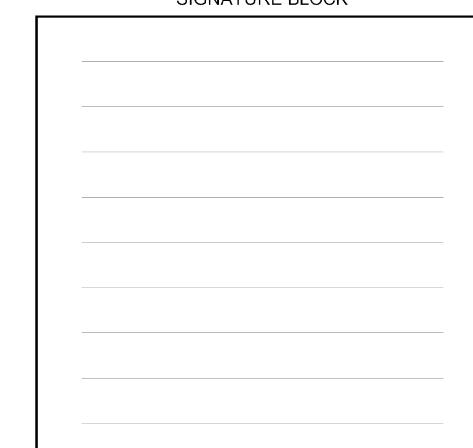

NOT FOR CONSTRUCTION



REMAIN AND BE

PROTECTED

– EXISTING VEGETATION TO 🖰 NEW ENGLAND CONSERVATION/

WILDLIFE SEED MIX

EXISTING TREELINE TO —

NEW ENGLAND

EXISTING —

1 QB -

TREELINE TO

REMAIN AND

BE PROTECTED

CONSERVATION/

WILDLIFE SEED, MIX

REMAIN AND BE

PROTECTED

1 QR —

NEW ENGLAND -

LAWN

LAWN

– 4' WIDE X 36" HT

– 4 IG

- 5' X 5' RAISED

ALUMINUM PLANTERS

RAISED ALUMINUM PLANTERS AROUND PERIMETER OF PATIO

UNDERGROUND INFILTRATION SYSTEM,

SEE CIVIL DRAWINGS

RAISED ALUMINUM

PLANTERS AROUND

PERIMETER OF PATIO

WETLAND SEED MIX

5 IG

— LAWN

- NEW ENGLAND

SEED MIX

SEE CIVIL

DRAWINGS FOR

FENCING AROUND

DETENTION AREAS

7 CK —

2 AB —

FENCING AROUND DETENTION AREAS

NEW ENGLAND

DETENTION BASIN

DETENTION BASIN

MICHAEL D'ANGELO ANDSCAPE ARCHITECTURE LL

119 GRISWOLD STREET SUITE 209 GLASTONBURY, CT 06033 t. 203.592.4788 www.m-d-l-a.com

9/25/24 INLAND WETLANDS SUBMISSION


LANDSCAPE LIGHTING PLAN

L200 SHEET 2 OF 6

plot date: 9/24/2024

NOT FOR CONSTRUCTION

SIGNATURE BLOCK

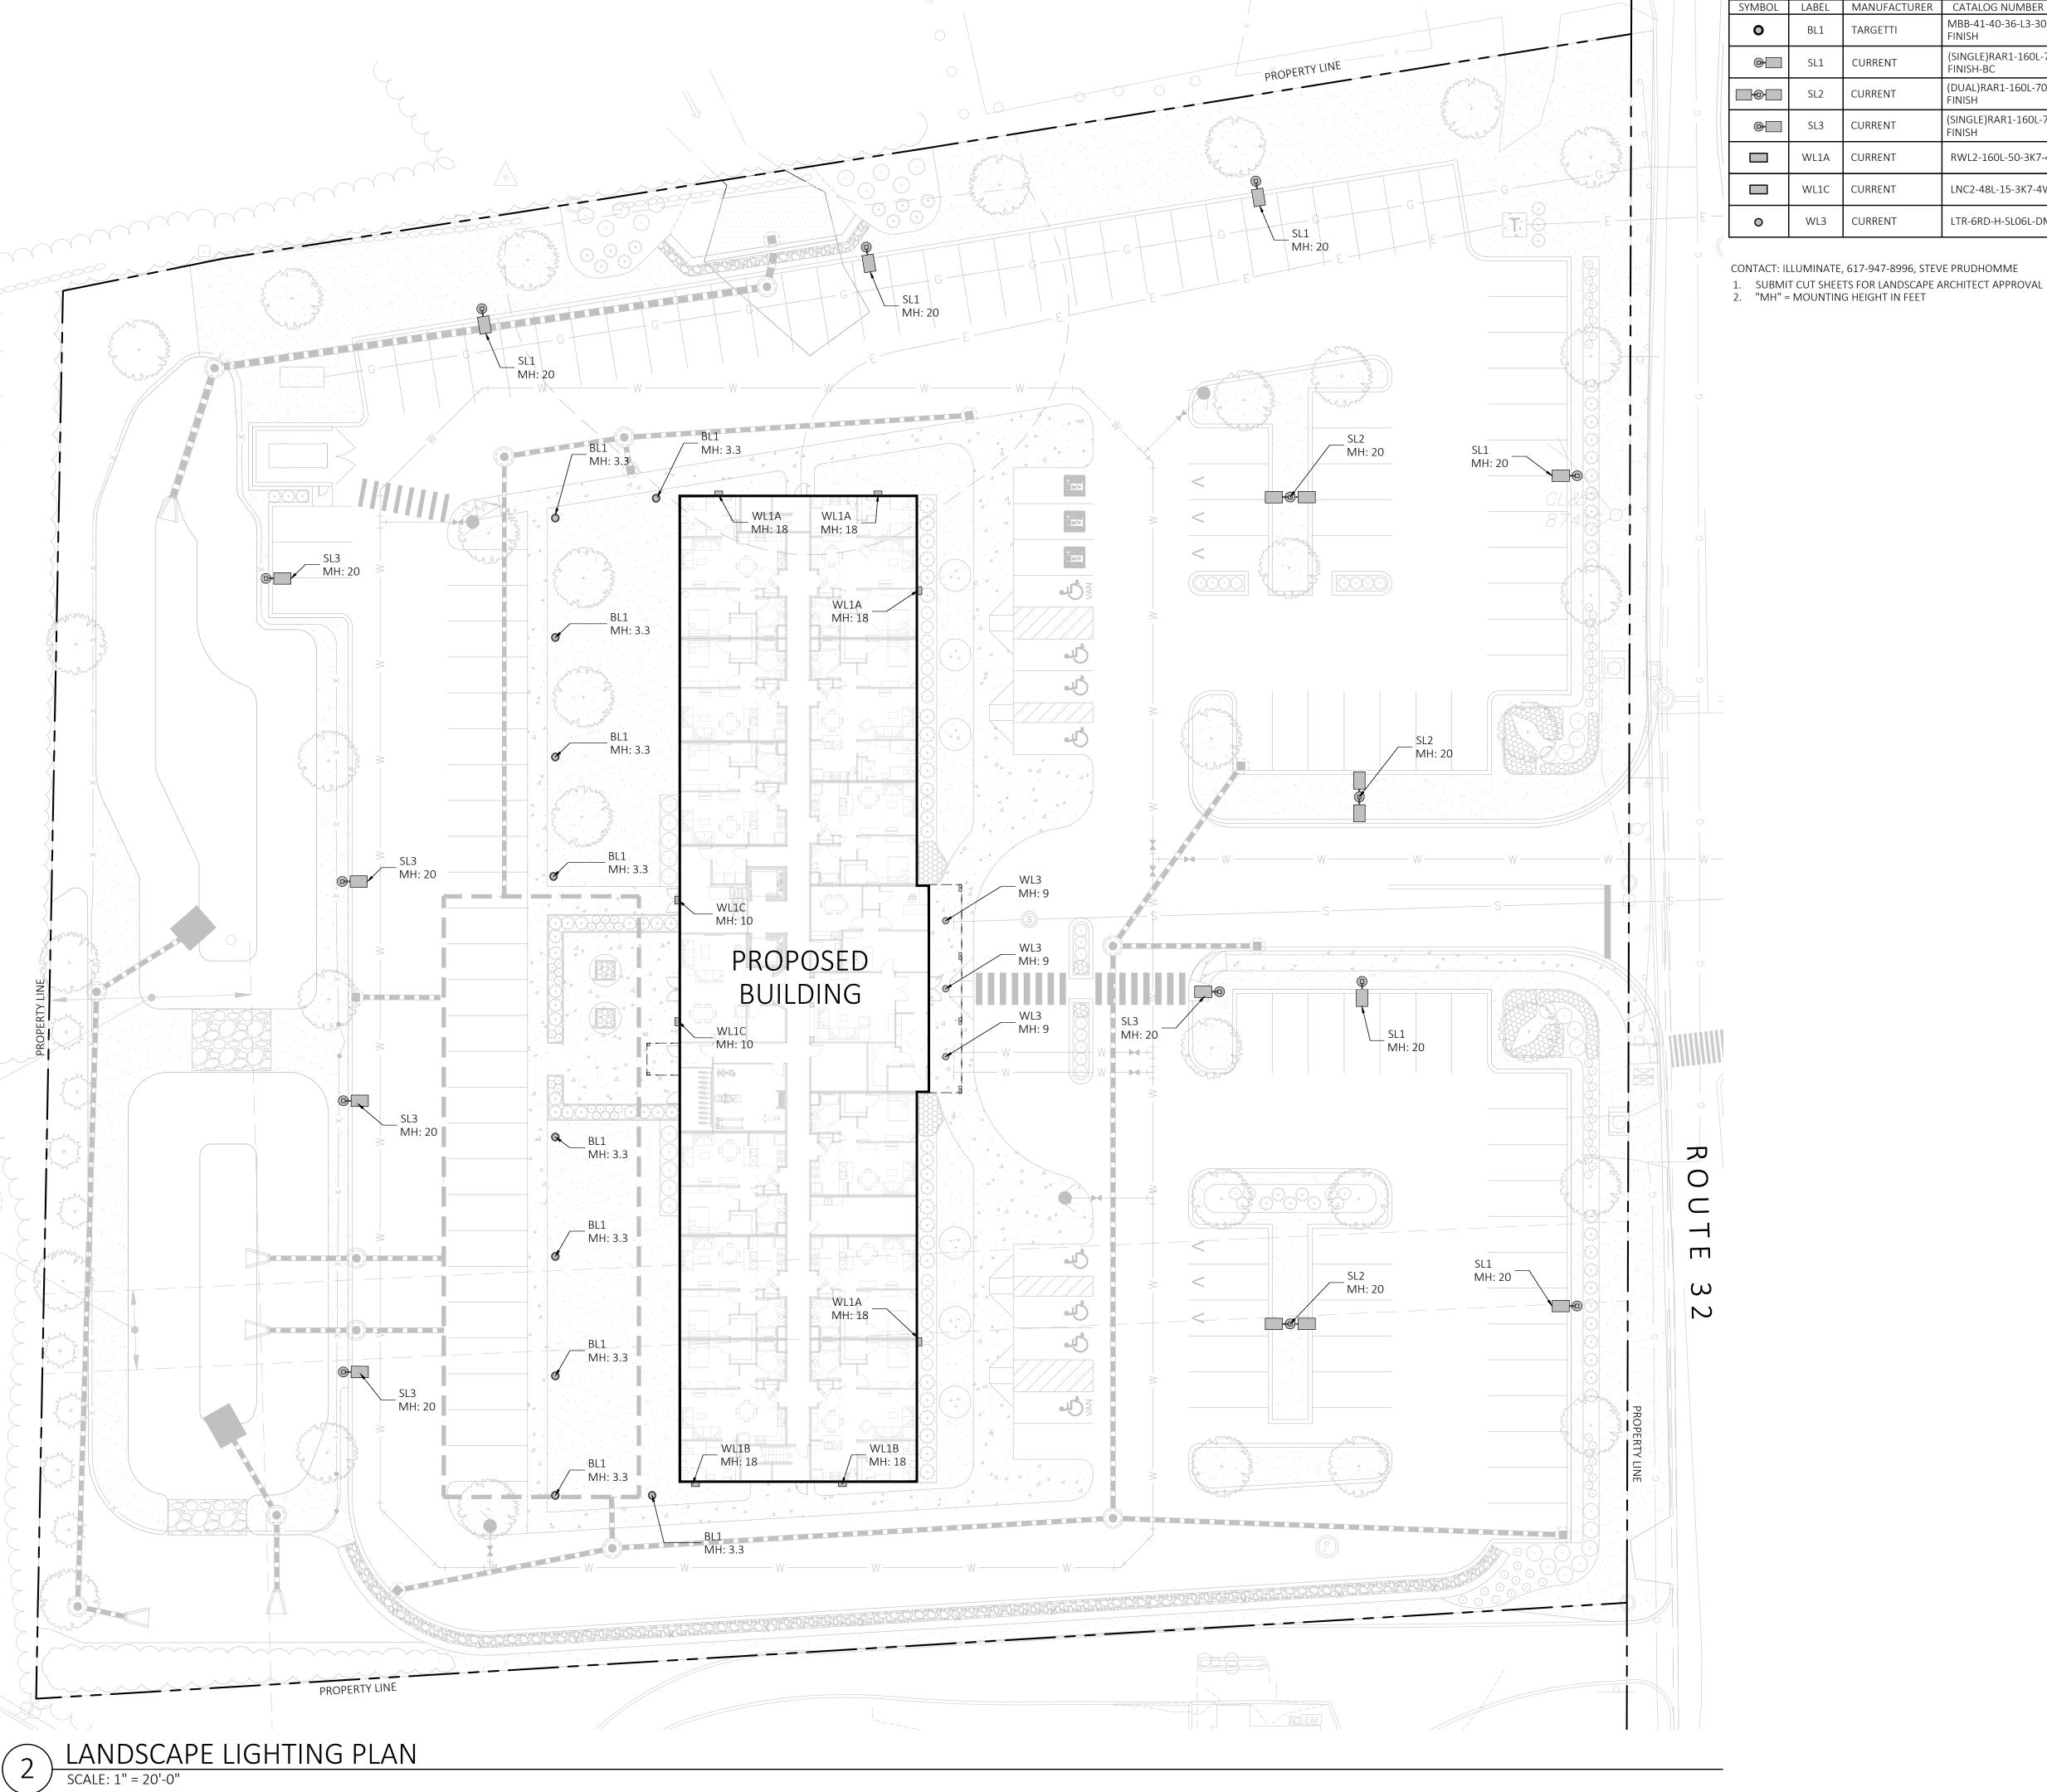

SL1

SL2

SL3

WL1A

WL1C

WL3

CURRENT


CURRENT

CURRENT

CURRENT

CURRENT

CURRENT

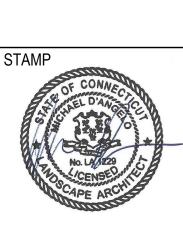


EV. NO.	DATE	DESCRIPTION
	9/25/24	INLAND WETLANDS SUBMISSION

LANDSCAPE LIGHTING |PHOTOMETRICS| PLAN

SHEET 3 OF

NOT FOR CONSTRUCTION

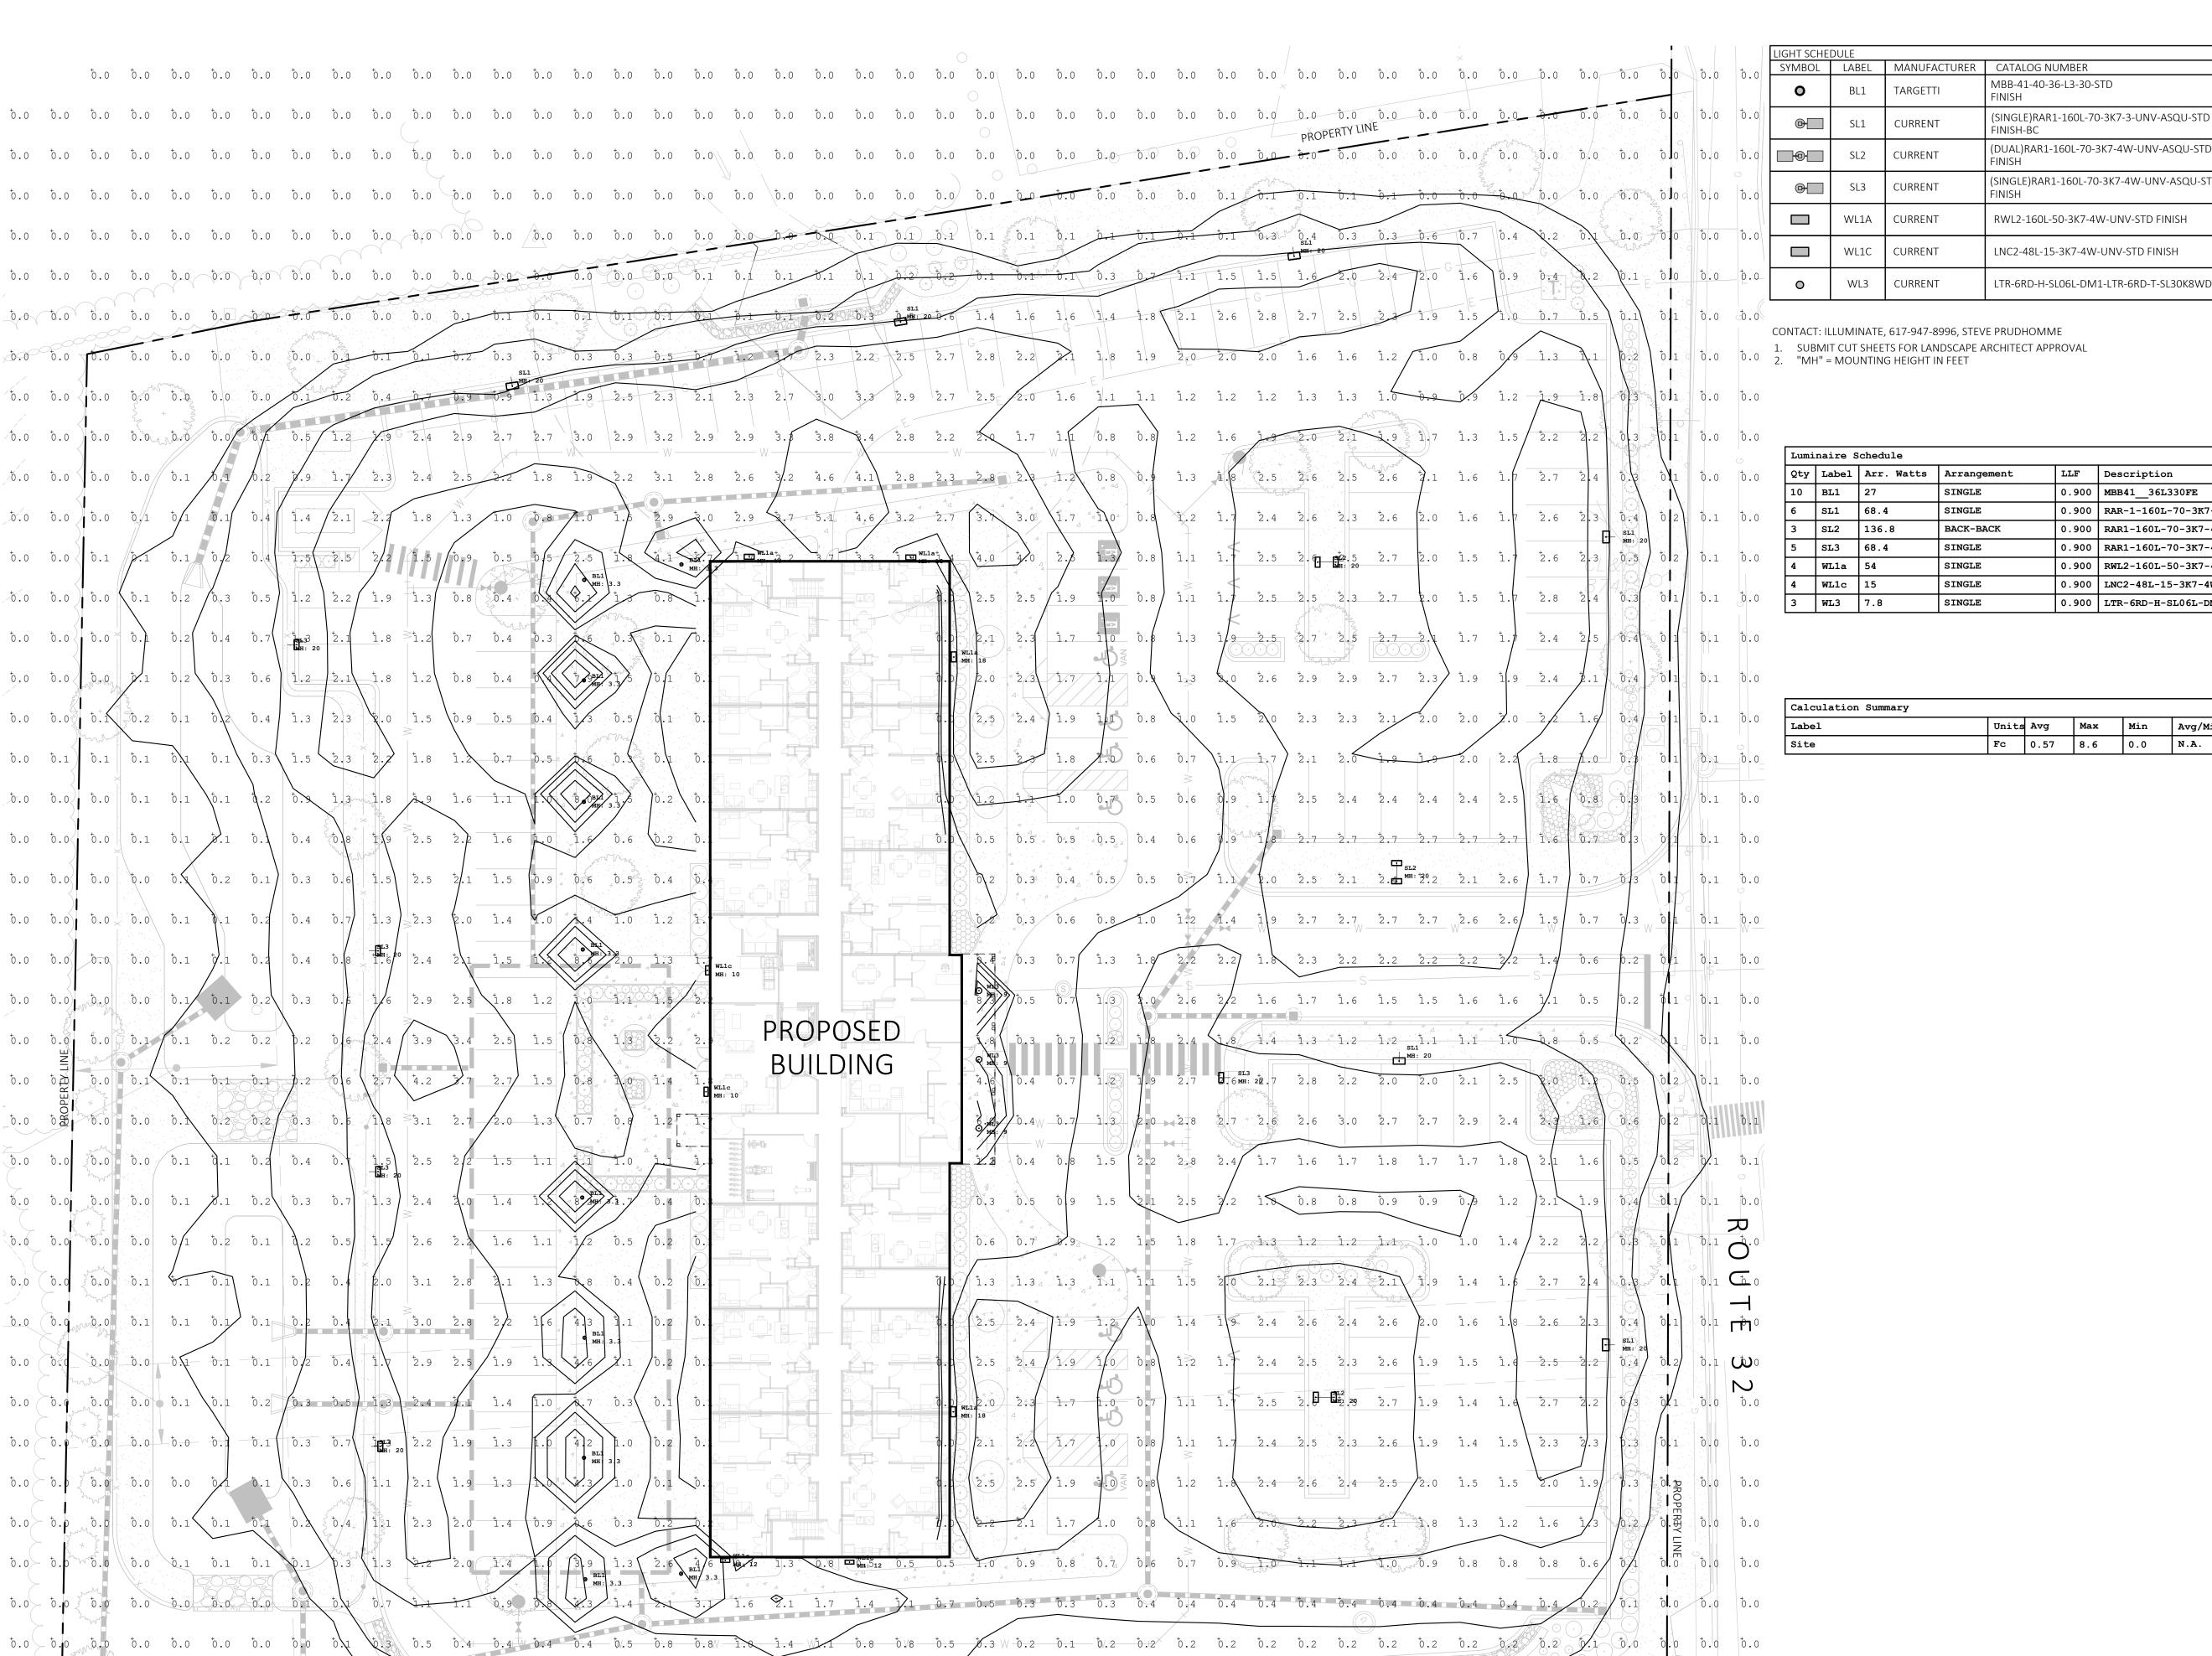

0.3 0.3 0.6 0.7 0.4

 $\frac{1}{2}$ $\frac{1}$

2.8 2.4

 $\frac{1}{1.8}$ $\frac{1}{1.9}$ $\frac{1}{2.0}$ $\frac{1}{2.0}$ $\frac{1}{2.0}$ $\frac{1}{2.0}$ $\frac{1}{1.6}$ $\frac{1}{1.2}$ $\frac{1}{1.0}$ $\frac{1}{0.8}$ $\frac{1}{0.9}$ $\frac{1}{1.3}$ $\frac{1}{1.1}$

1.3 1.8 2.5 2.6 2.5 2.6 2.5 2.6 2.1 1.6 1.6

 $0.8 \ 1.1 \ 1.7 \ 2.5 \ 2.9 \ 2.7 \ 2.0 \ 1.5 \ 1.7$

 $2 \ 0 \ 2.3 \ 2.3 \ 2.1 \ 2.0 \ 2.0$

 $1.2 \quad 1.6 \quad 1.9 \quad 2.0 \quad 2.1$

ō,7 ō.5 ō.6 Ō.9 ī.7

 $0.2 \quad 0.3 \quad 0.4 \quad 0.5 \quad 0.5 \quad 0.7$

√o.3 o.7 o.3 o.8/

/to.8 to.8

DOUBLE HEADED **BLACK CONCRETE FOOTING** SINGLE)RAR1-160L-70-3K7-4W-UNV-ASQU-STE BLACK STREET LIGHT CONCRETE FOOTING WALL MOUNTED WALL MOUNTED **BLACK** RWL2-160L-50-3K7-4W-UNV-STD FINISH WALL MOUNTED BLACK LNC2-48L-15-3K7-4W-UNV-STD FINISH WALL MOUNTED **BUILDING MOUNTED** LTR-6RD-H-SL06L-DM1-LTR-6RD-T-SL30K8WDS **BUILDING MOUNTED BLACK**

BOLLARD

STREET LIGHT

MOUNT

CONCRETE FOOTING

CONCRETE FOOTING

MOUNT HT COLOR

BLACK

BLACK

Qty	Label	Arr. Watts	Arrangement	LLF	Description
10	BL1	27	SINGLE	0.900	MBB4136L330FE
6	SL1	68.4	SINGLE	0.900	RAR-1-160L-70-3K7-3-BC
3	SL2	136.8	BACK-BACK	0.900	RAR1-160L-70-3K7-4W-U
5	SL3	68.4	SINGLE	0.900	RAR1-160L-70-3K7-4W-U
4	WL1a	54	SINGLE	0.900	RWL2-160L-50-3K7-4-U
4	WL1c	15	SINGLE	0.900	LNC2-48L-15-3K7-4W-UNV
3	WL3	7.8	SINGLE	0.900	LTR-6RD-H-SL06L-DM1 LTR-6RD-T-SL35K8WDS

Calculation Summary						
Label	Units	Avg	Max	Min	Avg/Min	Max/Min
Site	Fc	0.57	8.6	0.0	N.A.	N.A.

SIGNATURE BLOCK

LANDSCAPE LIGHTING PHOTOMETRICS PLAN SCALE: 1" = 20'-0"

1.2 1.9 2.4 2.9 2.7 2.7 3.0 2.9 3.2 2.9 2.9 3.8

2.2 3.1 2.8 2.6 3/.2 4.6 4.1 2.8 2.3 2.8 2.8 2.8 0.9

PROPOSED

BUILDING

 $\frac{1}{3.7}$ $\frac{1}{4.6}$ $\frac{1}{3.2}$ $\frac{1}{2.7}$ $\frac{1}{3.7}$ $\frac{1}{3.0}$

 $\frac{1}{3}.4$ $\frac{1}{2}.8$ $\frac{1}{2}.2$ $\frac{1}{2}.0$ $\frac{1}{2}.7$ $\frac{1}{2}.0$

 $\begin{bmatrix} 1 & 2 \\ 2 & 2 \end{bmatrix}$ $\begin{bmatrix} 1 & 9 \\ 1 & 3 \end{bmatrix}$ $\begin{bmatrix} 0 & 8 \\ 5 & 4 \end{bmatrix}$ $\begin{bmatrix} 5 & 4 \\ 4 \end{bmatrix}$

 $1 \quad 1.8 \quad 1.2 \quad 0.7 \quad 0.4$

1.8 1.2 0.7

1.6 1.1

1.6 0 2.4 2 1 1.5 1 8 6 3 2

 $0.2 \quad 0.4 \quad 121 \quad 2.3 \quad 2.0 \quad 1.4 \quad 0.9 \quad 0.3 \quad 0.2$

 $\frac{1}{6}$ $\frac{1}{6}$ $\frac{1}{2}$ $\frac{1}$

 $1\sqrt{9}$ 2.5 2.2

 $0.0 \quad 0.0 \quad 0.0 \quad 0.0 \quad 0.1 \quad 0.2 \quad 0.1 \quad 0.3 \quad 0.6 \quad 0.5 \quad 0.4 \quad 0.4$

 $0.0 \quad 0.0 \quad 0.0 \quad 0.0 \quad 0.1 \quad 0.2 \quad 0.3 \quad 0.6 \quad 0.4 \quad 0.8 \quad 0.4$

 $0.0 \quad 0.0 \quad 0.1 \quad 0.2 \quad 0.1 \quad 0.2 \quad 0.4 \quad 1.3 \quad 2.3 \quad 2.0 \quad 1.5 \quad 0.9 \quad 0.5 \quad 0.4$

 $0.0 \quad 0.0 \quad 0.0 \times \quad 0.0 \quad 0.1 \quad 0.1 \quad 0.2 \quad 0.4 \quad 0.7 \quad 1.3 \times 2.3 \quad 0.0 \quad 1.4 \quad 0.0$

0.0 0.0 0.1

 $\begin{bmatrix} 0.0 & 0.8 \end{bmatrix}$ $\begin{bmatrix} 0.0 & 0.1 \\ 0.0 & 0.2 \end{bmatrix}$ $\begin{bmatrix} 0.2 & 0.2 \\ 0.2 \end{bmatrix}$ $\begin{bmatrix} 0.3 & 0.6 \\ 1 \end{bmatrix}$ $\begin{bmatrix} 1.8 & 3.1 & 2.7 \\ 2.0 & 1.3 \\ 0.7 & 0.8 \end{bmatrix}$

to.0 to.0 to.0 to.0 to.1 to.2 to.3 to.7 1.3 2.4 to.0 to.4 to.2 to.3 to.7

 $0.0 \quad 0.0 \quad 0.1 \quad 0.1 \quad 0.1 \quad 0.1 \quad 0.2 \quad 0.4 \quad 2.0 \quad 3.1 \quad 2.8 \quad 3.1 \quad 1.3 \quad 0.8 \quad 0.4 \quad 0.1 \quad 0.1$

0.0 0.0 0.0 0.1 0.1 0.2 0.3 0.5 0.3 0.5 0.3 0.4 0.4 0.4 0.3

5.0 5.0 5.0 5.0 5.0 5.0 5.1 (5.3 5.7) 10.3 5.7 (1.9 1.3 1.6 (4.2) 1.0

0.0 > 0.0 > 0.0 > 0.0 > 0.0 > 0.0 > 0.1 > 0.3 > 0.6 > 0.1 > 0.1 > 0.3 > 0.6 > 0.1

 $0.0 \quad 0.0 \quad 0.0$

 $[5.0 \quad 5.1] \quad [5.1] \quad [5.1 \quad 5.1] \quad [5.1] \quad [5.3] \quad [5.3] \quad [5.2] \quad [5.2]$

 $[5.0 \quad 5.0] \quad [5.0 \quad 5.1 \quad 5.1 \quad 5.1 \quad 5.2 \quad 5.9 \quad 1.3 \quad 1.8$

 $0.0 \quad 0.0 \quad 0.0 \quad 0.1 \quad 0.1 \quad 0.1 \quad 0.1 \quad 0.4 \quad 0.8$

 $0.0 \quad 0.0 \quad 0.0 \quad 0.0 \quad 0.1 \quad 0.1 \quad 0.4 \quad 0.8$

 $0.0 \quad 0.0 \quad 0.0 \quad 0.0 \quad 0.1 \quad 0.1 \quad 0.2 \quad 0.3 \quad 0.6$

[0.0] 0.0 0.1 0.1 0.2 0.4 0.4

~ 6.0 \ 5.0 \ 5.1 \ 5.1 \ 5.1 \ 5

0.0 0.0 0.0 0.0 0.0 0.0 0.1 0.7

MICHAEL D'ANGELO ANDSCAPE ARCHITECTURE LL

REV. NO. DATE DESCRIPTION 9/25/24 INLAND WETLANDS SUBMISSION

> LANDSCAPE DETAILS

L300

SHEET 4

plot date: 9/24/2024

SPACING VARIES; – BARK MULCH; SEE SPEC. SEE PLANT SCHEDULE, OR AS SHOWN ON PLAN MIN. - MAINTAIN RELATIONSHIP OF ROOTFLARE TO FINISH GRADE AS EXISTED PRIOR TO INSTALL, TYP. – PLANTING MEDIUM; SEE SPEC - ROLL BACK BURLAP 1/3 ROOTBALL HT, MIN; TYP. - SCARIFY SURFACE OF SUBGRADE, TYP. COMPACTED OR UNDISTURBED SUBGRADE


SHRUB PLANTING

SCALE: \(\frac{3}{8}\)" = 1'-0"


– NEVER CUT TREE LEADER – MAINTAIN RELATIONSHIP OF ROOTFLARE TO FINISH GRADE AS EXISTED PRIOR TO INSTALL, TYP. – HOLD MULCH BACK FROM TRUNK OF TREE - BARK MULCH; SEE SPEC – TEMOPARY EARTH SAUCER — PLANTING MEDIUM; SEE SPEC BELOW-GRADE TREE ANCHORING SYSTEM; SEE SPEC. COMPACTED OR UNDISTURBED SUBGRADE - SCARIFY SURFACE OF SUBGRADE, TYP. - REMOVE ROPE / CAGE AND ROLL BACK BURLAP 1/3 EQ. 2' MIN. EQ. 2' MIN. ROOTBALL HT, MIN; TYP.


DECIDUOUS TREE PLANTING

SCALE: \(\frac{3}{8}\)" = 1'-0"

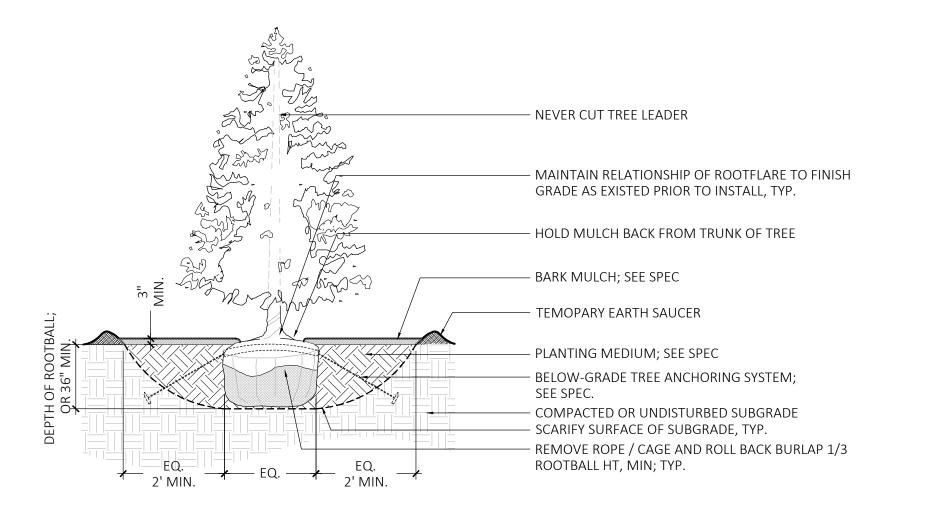

SCALE: 3" = 1'-0"

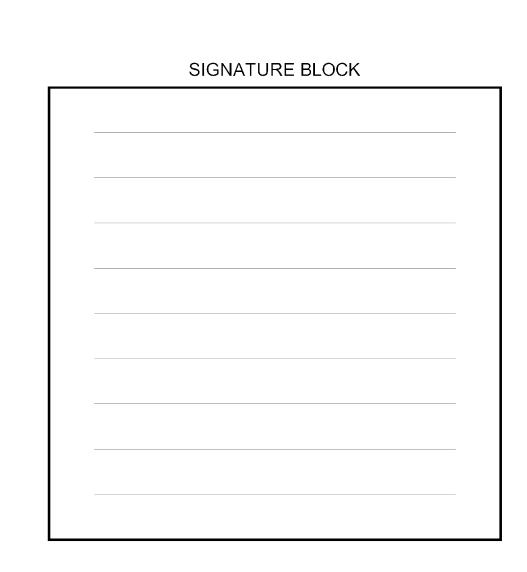

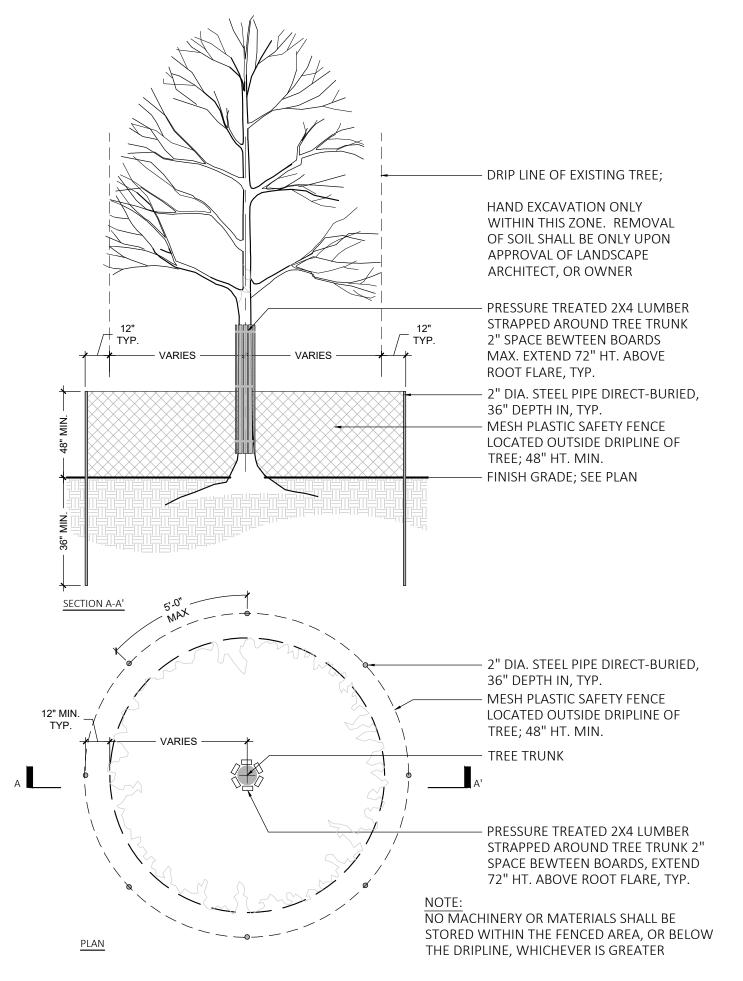

TREE PROTECTION FENCING

SCALE: \(\frac{3}{8}\)" = 1'-0"

- SEE PLANTING SCHEDULE FOR TYPICAL SPACING UNLESS OTHERWISE SHOWN ON PLAN NOTE:

1. INSTALL BARK MULCH PRIOR TO
GROUNDCOVER PLANTING INSTALL TYPICAL PLANT LAYOUT - PLAN BARK MULCH; SEE SPEC. PLANTING MEDIUM; SEE SPEC - SCARIFY SURFACE OF SUBGRADE, COMPACTED OR UNDISTURBED SUBGRADE