
# Site Development Plans

Prepared For Cricket's Corner, LLC 1645 Route 85 Montville, Connecticut February 2025

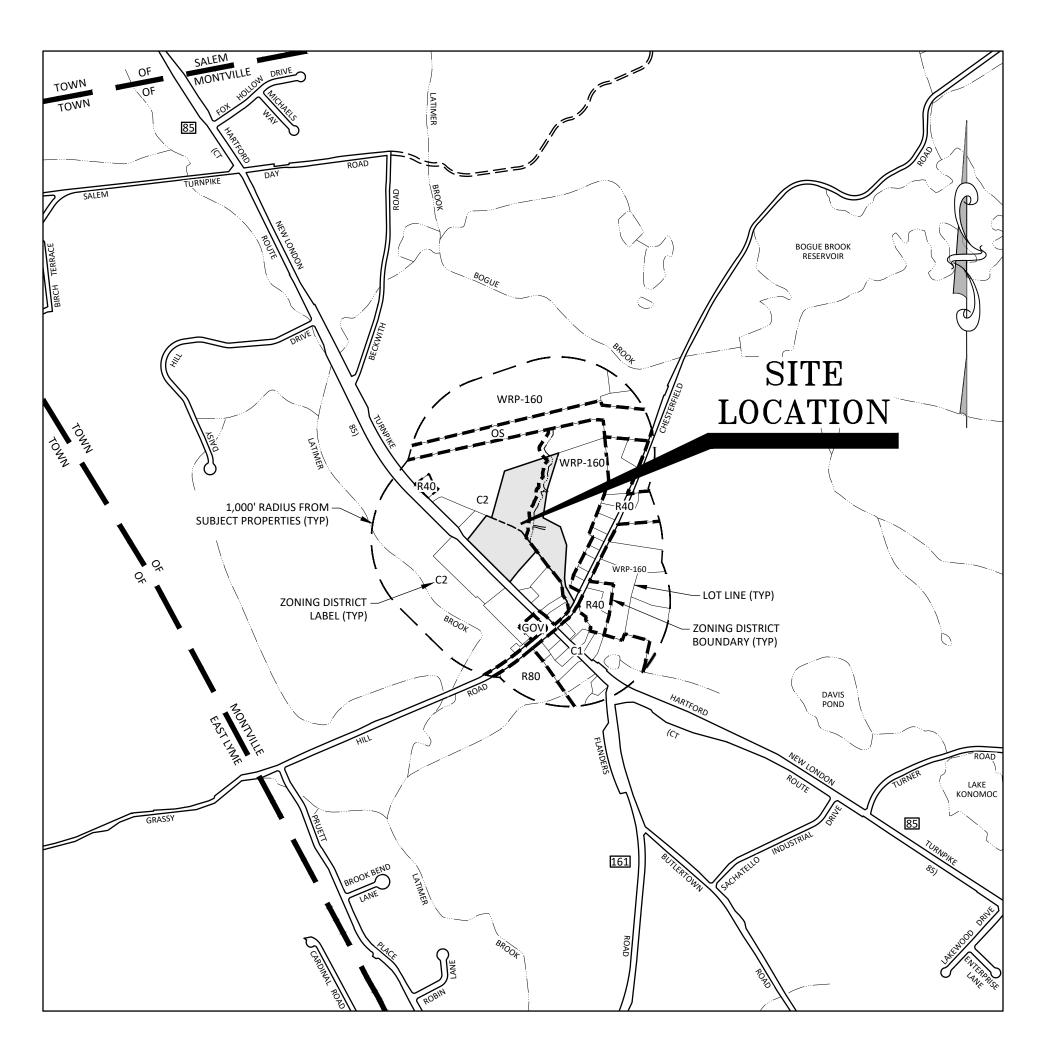

**Location Map** Scale: 1" = 1,000'

FOR REVIEW AND **PERMITTING ONLY** 

Sheet No.	Description
1	Cover Sheet
2	Existing Conditions
3	Existing Conditions
4	Overall Site Development Plan & Key Map
5	Site Layout - South
6	Site Layout - North
7	Subsurface Sewage Disposal System Design Plan
8	Driveway Profile
9	Sight Line Demonstration Plan
10	Lighting & Landscape Plan
11	Notes & Details
12	Notes & Details
13	Notes & Details
Applican	nts/Owners: Cricket's Corner, LLC

c/o Roger L. Phillips

Oakdale, CT 06370

Area: 5.95± Acres

879 Chesterfield Road

Area: 11.15± Acres

Deed Reference: Volume 701, Page 64

Deed Reference: Volume 701, Page 91

1650 Route 85

1645 Route 85

012-009-000

005-015-00C

**Subject Properties:** 



T 860.376.2006 | www.boundariesllc.net

THIS DRAWING IS THE PROPERTY OF BOUNDARIES LLC AND HAS BEEN SPECIFICALLY PREPARED FOR THE OWNER OF THIS PROJECT, AT THIS SITE, AND IS NOT TO BE DUPLICATED OR USED IN PART OR WHOLE FOR ANY OTHER PURPOSE, PROJECT, LOCATION OR OWNER WITHOUT THE EXPRESSED WRITTEN CONSENT OF





APPROVED BY THE TOWN OF MONTVILLE PLANNING AND ZONING COMMISSION


I have delineated the inland wetlands and watercourses as shown on the subject site plans in accordance with the standards and definitions found in the Connecticut General Statutes, Chapter 440, Sections 22a-36 through 22a-45 as amended.




Ian T. Cole, P.W.S. #2006, Registered Soil Scientist

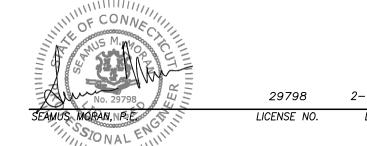

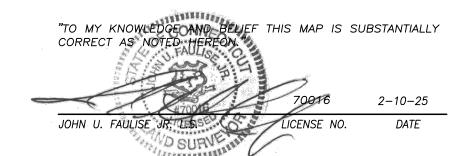

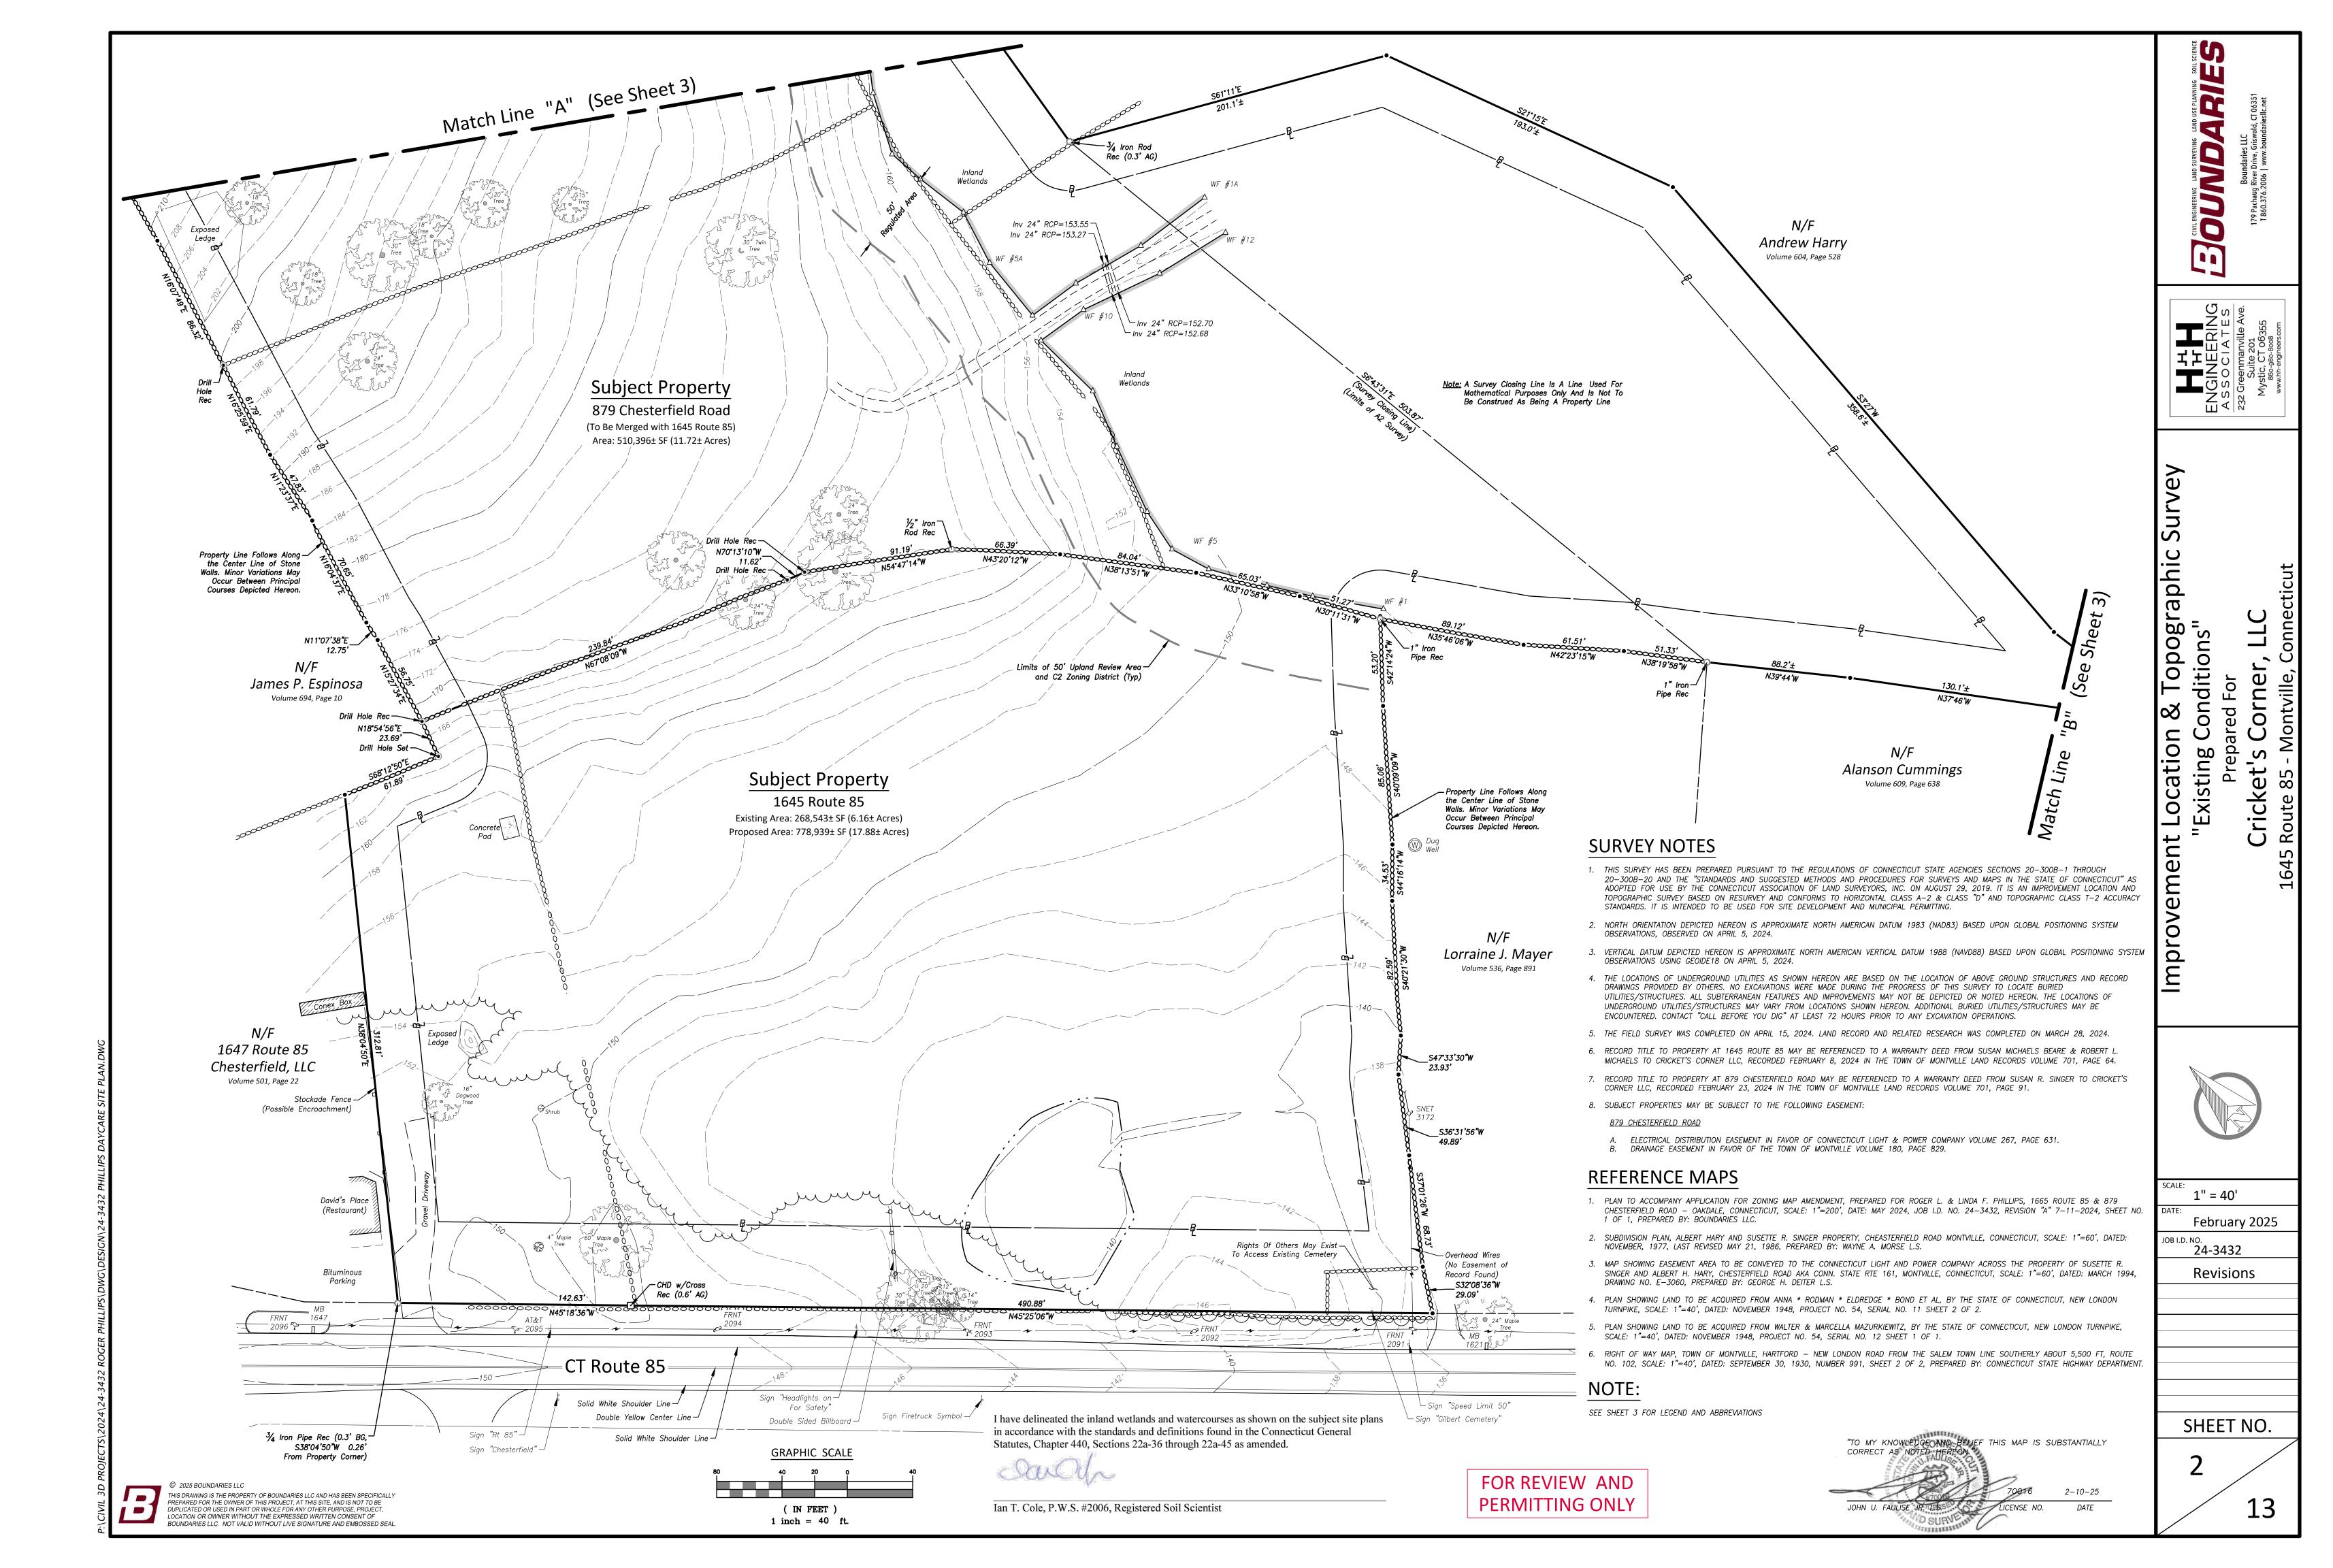

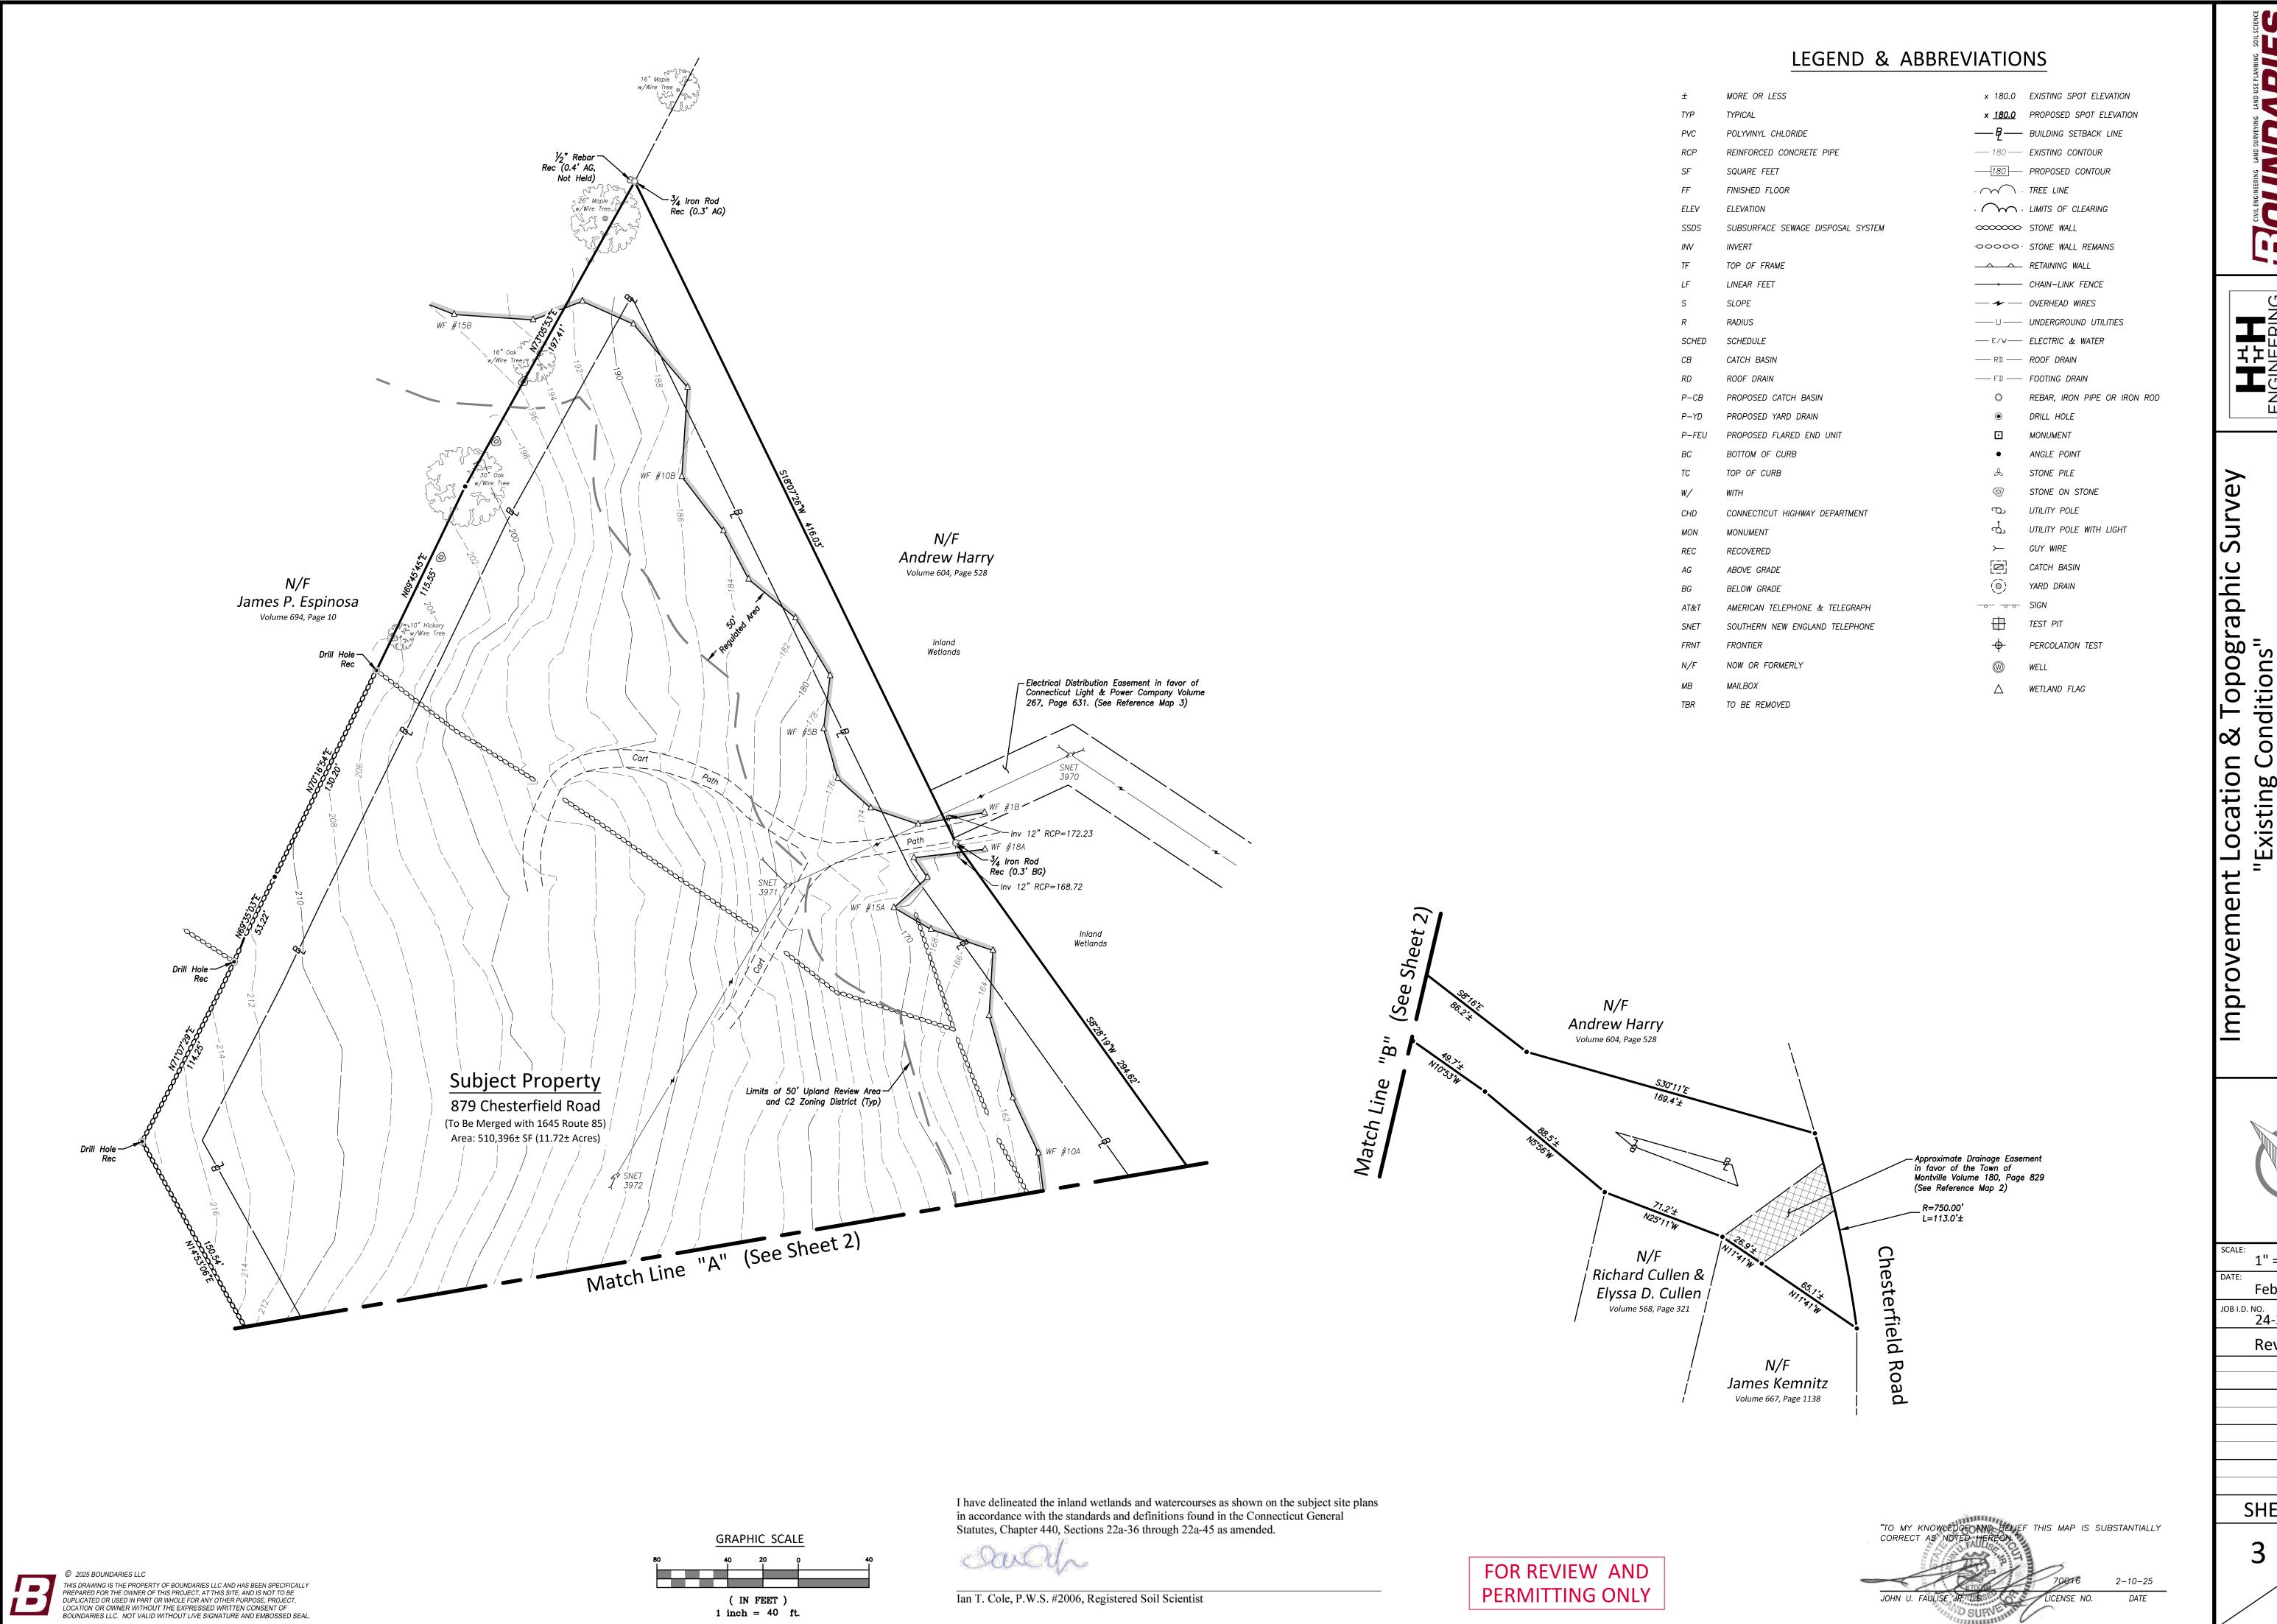

J

m

onditions

orner,

cket

1" = 40'

February 2025

JOB I.D. NO. 24-3432

Revisions

ZONING COMPLIANCE TABLE: COMMERCIAL-2 (C-2)					
ITEM	REQUIRED	1645 ROUTE 85	879 CHESTERFIELD RD		
MINIMUM LOT SIZE	40,000 SF	268,543± SF	510,396± SF		
MINIMUM LOT FRONTAGE	80 FT	633.51 FT	113.0± FT		
MINIMUM FRONT YARD	50 FT	N/A*	1,117.1± FT		
MINIMUM SIDE YARD	30 FT	N/A*	117.9± FT		
MINIMUM REAR YARD	30 FT	N/A*	320.2± FT		
WATER SUPPLY		PRIVATE WELL			
SANITARY		ON-SITE SSDS			


\*PROPOSED BUILDING TO BE LOCATED ON 879 CHESTERFIELD RD ONLY

	PARKING REQUIREMENTS: DAYCARE				
	ITEM	REQUIRED	PROVIDED		
1	51 PUPILS @ 1 SPACE PER 6 STUDENTS*	8 1/2	10		
1	13 EMPLOYEES @ 1 SPACE PER EMPLOYEE	13	13		
$\triangle$	ADA ACCESSIBLE @ 1 SPACE PER 25 SPACES	1	2		
	TOTAL SPACES	22 1/2	25		

\*PER CITY OF NORWICH ZONING REGULATIONS (MONTVILLE DOES NOT SPECIFY DAYCARE REQUIREMENT)


P	ARKING REQUIREMENTS:	2-UNIT A	PARTMENT
	ITEM	REQUIF	RED PROVIDED
1	2-UNITS @ 2.5 SPACES PER UNIT*	5	7
	TOTAL SPACES	5	7

\*PER SECTION 18.3.2 OF TOWN OF MONTVILLE ZONING REGULATIONS

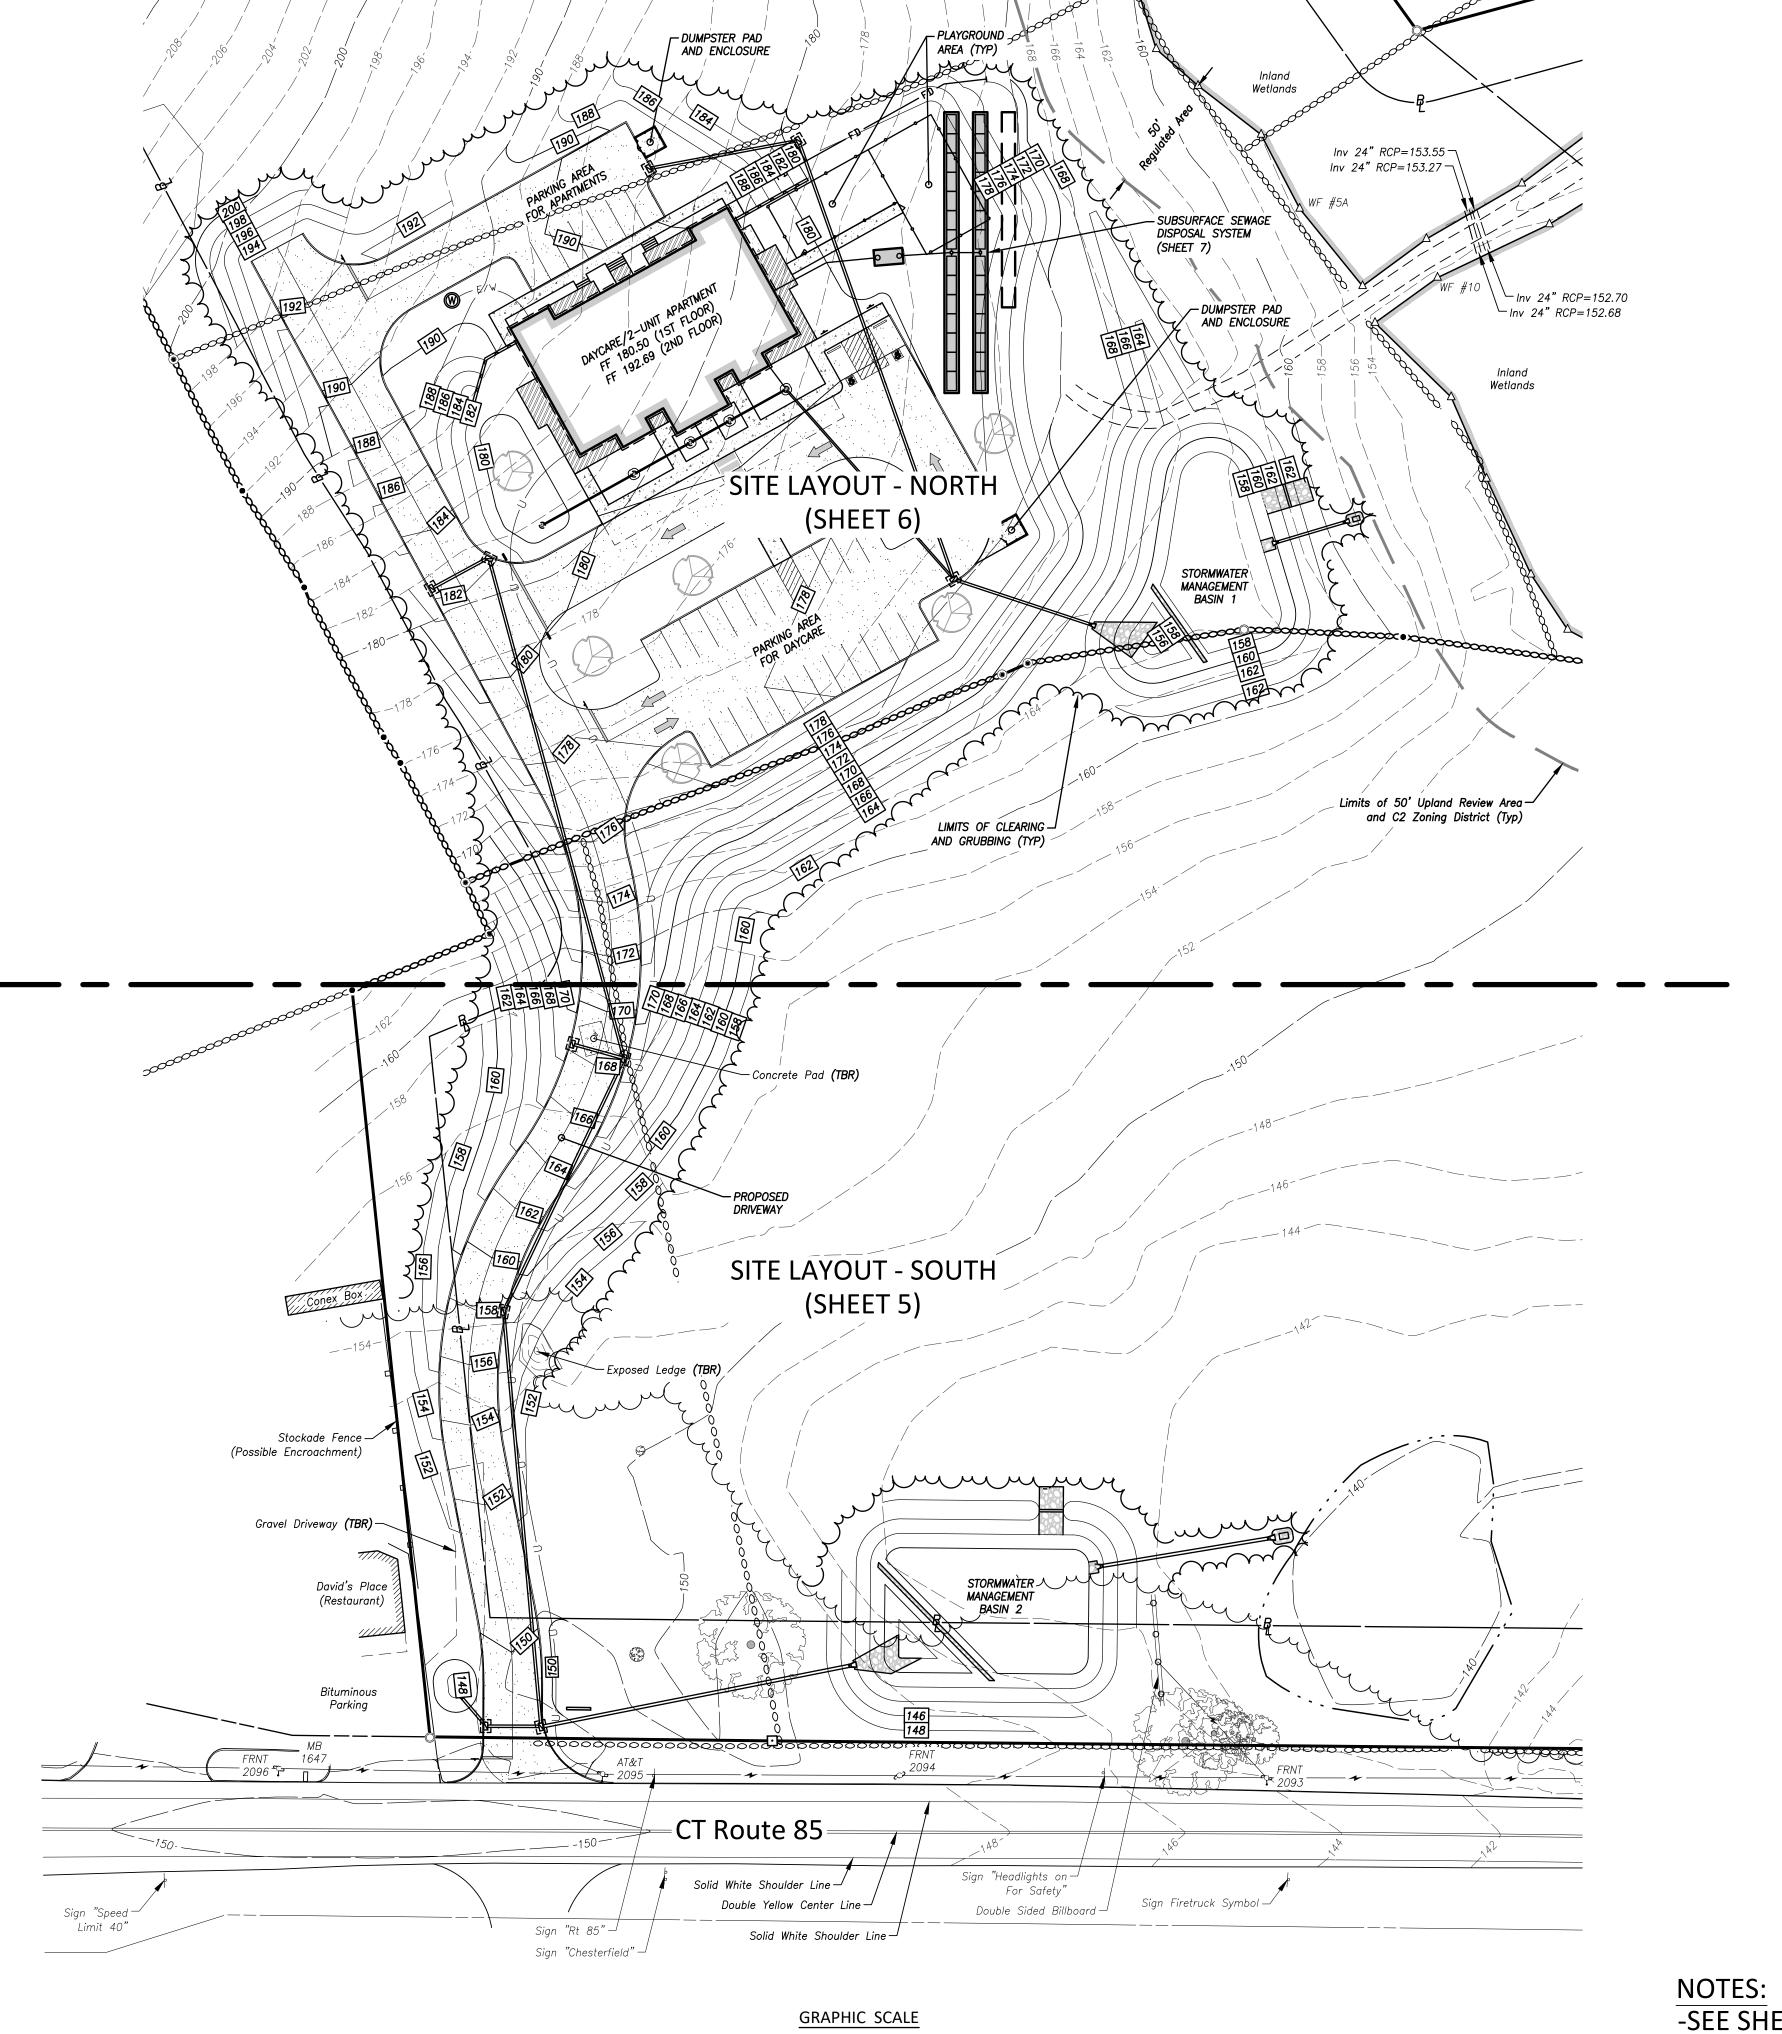

© 2025 BOUNDARIES LLC

THIS DRAWING IS THE PROPERTY OF BOUNDARIES LLC AND HAS BEEN SPECIFICALLY PREPARED FOR THE OWNER OF THIS PROJECT, AT THIS SITE, AND IS NOT TO BE DUPLICATED OR USED IN PART OR WHOLE FOR ANY OTHER PURPOSE, PROJECT, LOCATION OR OWNER WITHOUT THE EXPRESSED WRITTEN CONSENT OF BOUNDARIES LLC. NOT VALID WITHOUT LIVE SIGNATURE AND EMBOSSED SEAL.

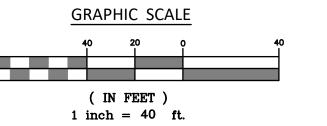

FOR REVIEW AND PERMITTING ONLY

NOTES:
-SEE SHEET 1 FOR ENGINEER, SURVEYOR AND
SOIL SCIENTIST SIGNATURES AND SEALS
-SEE SHEET 3 FOR LEGEND AND ABBREVIATIONS

CIVILENGINEERING LAND SURVEYING LAND USE PLANNING SOIL SCIENCE

Boundaries LLC

170 Pachalle Diver Drive Grickwold (7 06351)

ENGINEEKING
ASSOCIATES
232 Greenmanville Ave.
Suite 201
Mystic, CT 06355
860-8008
www.hh-engineers.com

Improvement Location & Topographic Survey "Overall Site Development Plan & Key Map" Prepared For Cricket's Corner, LLC

SCALE: 1" = 40'
DATE:

February 2025


JOB I.D. NO.
24-3432


Revisions


SHEET NO.

4

1

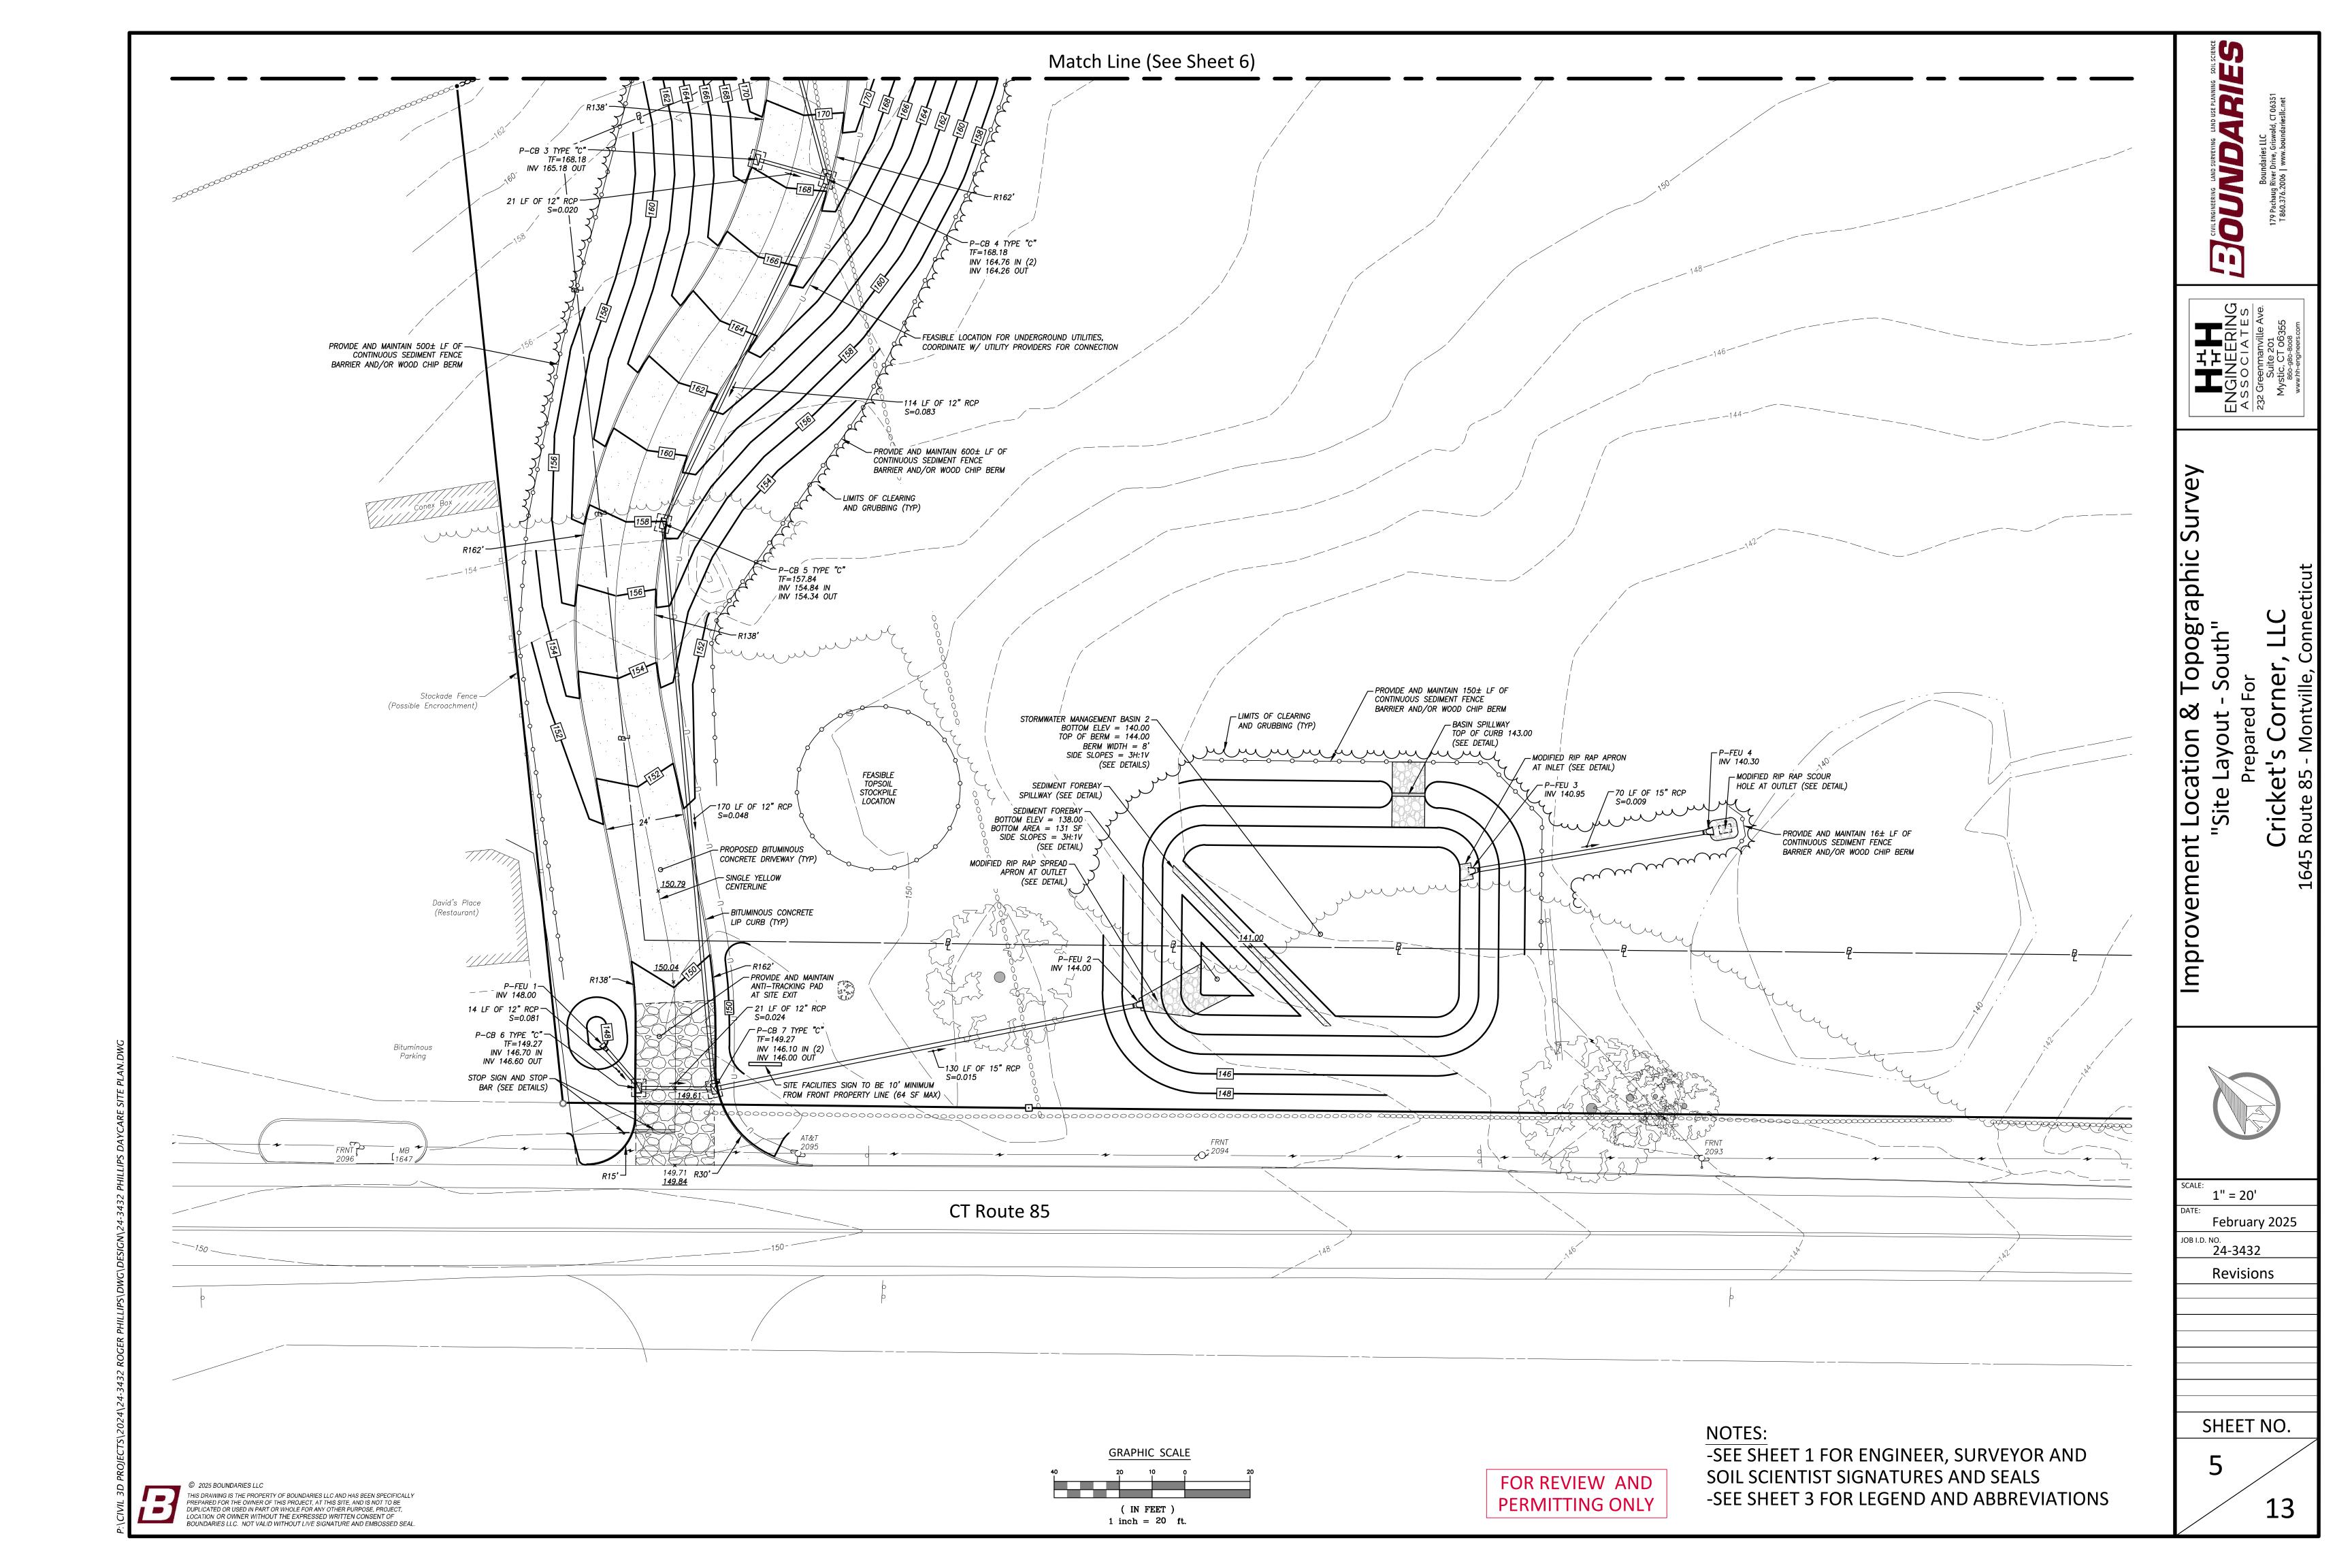

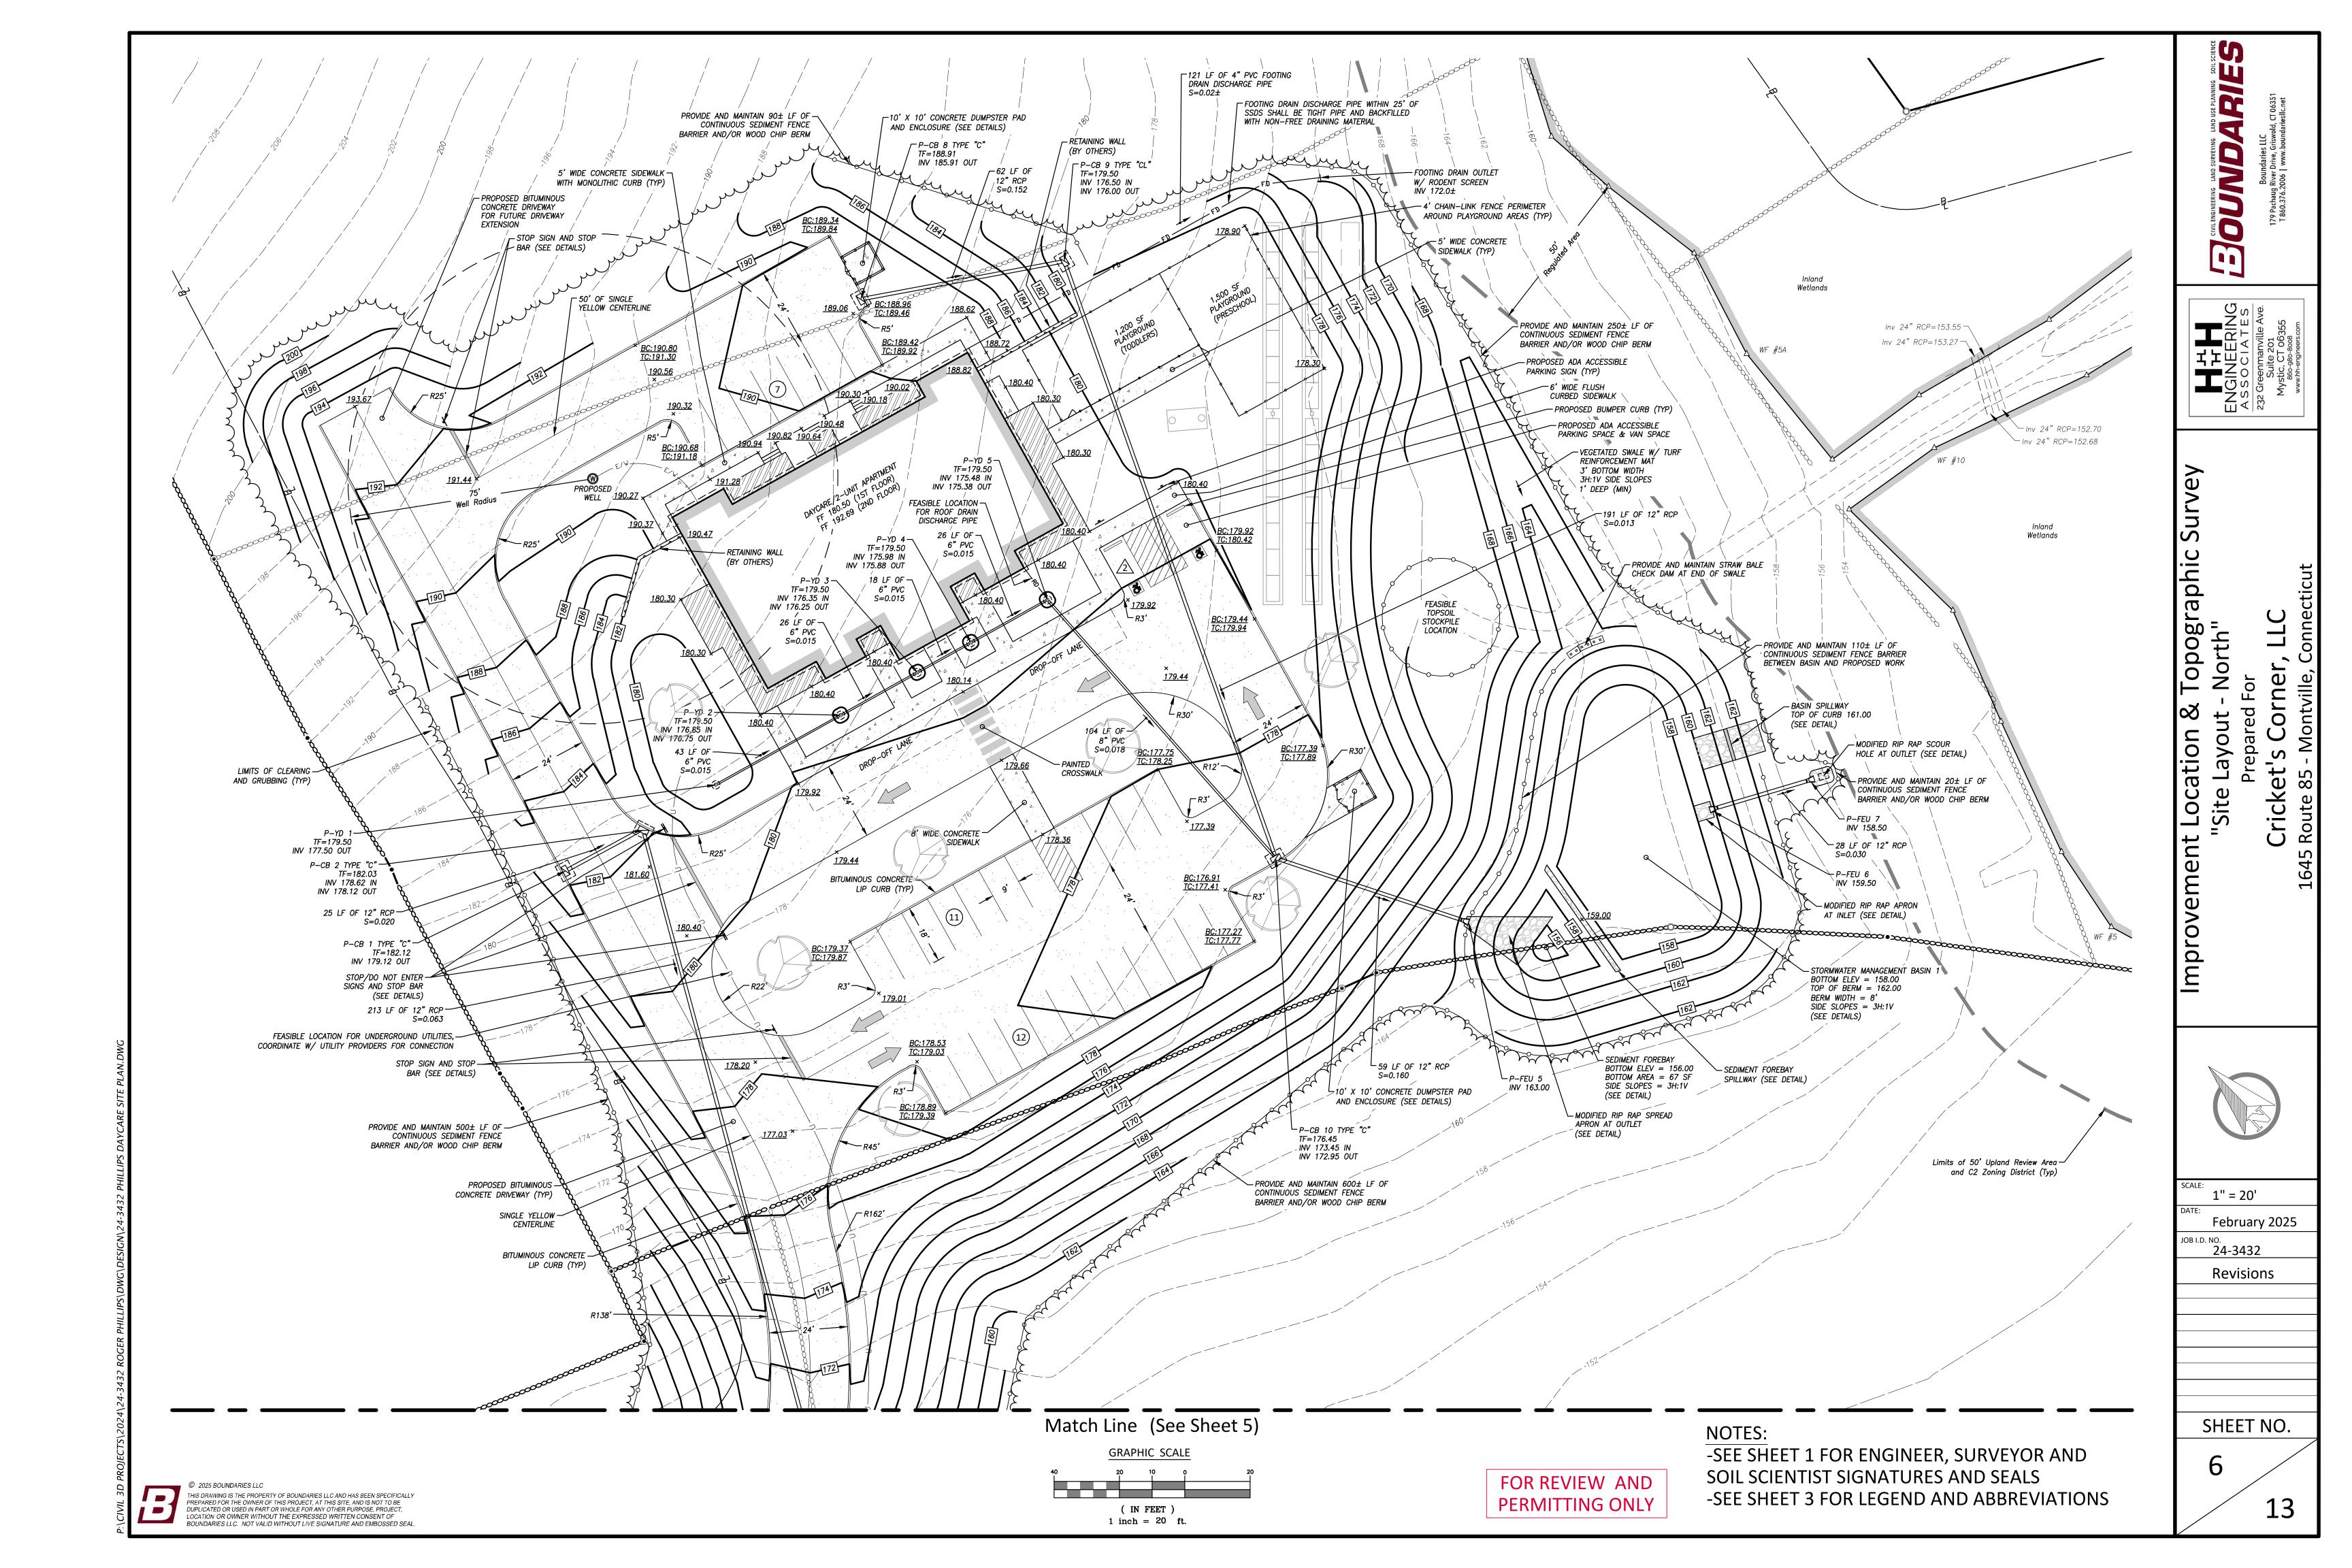

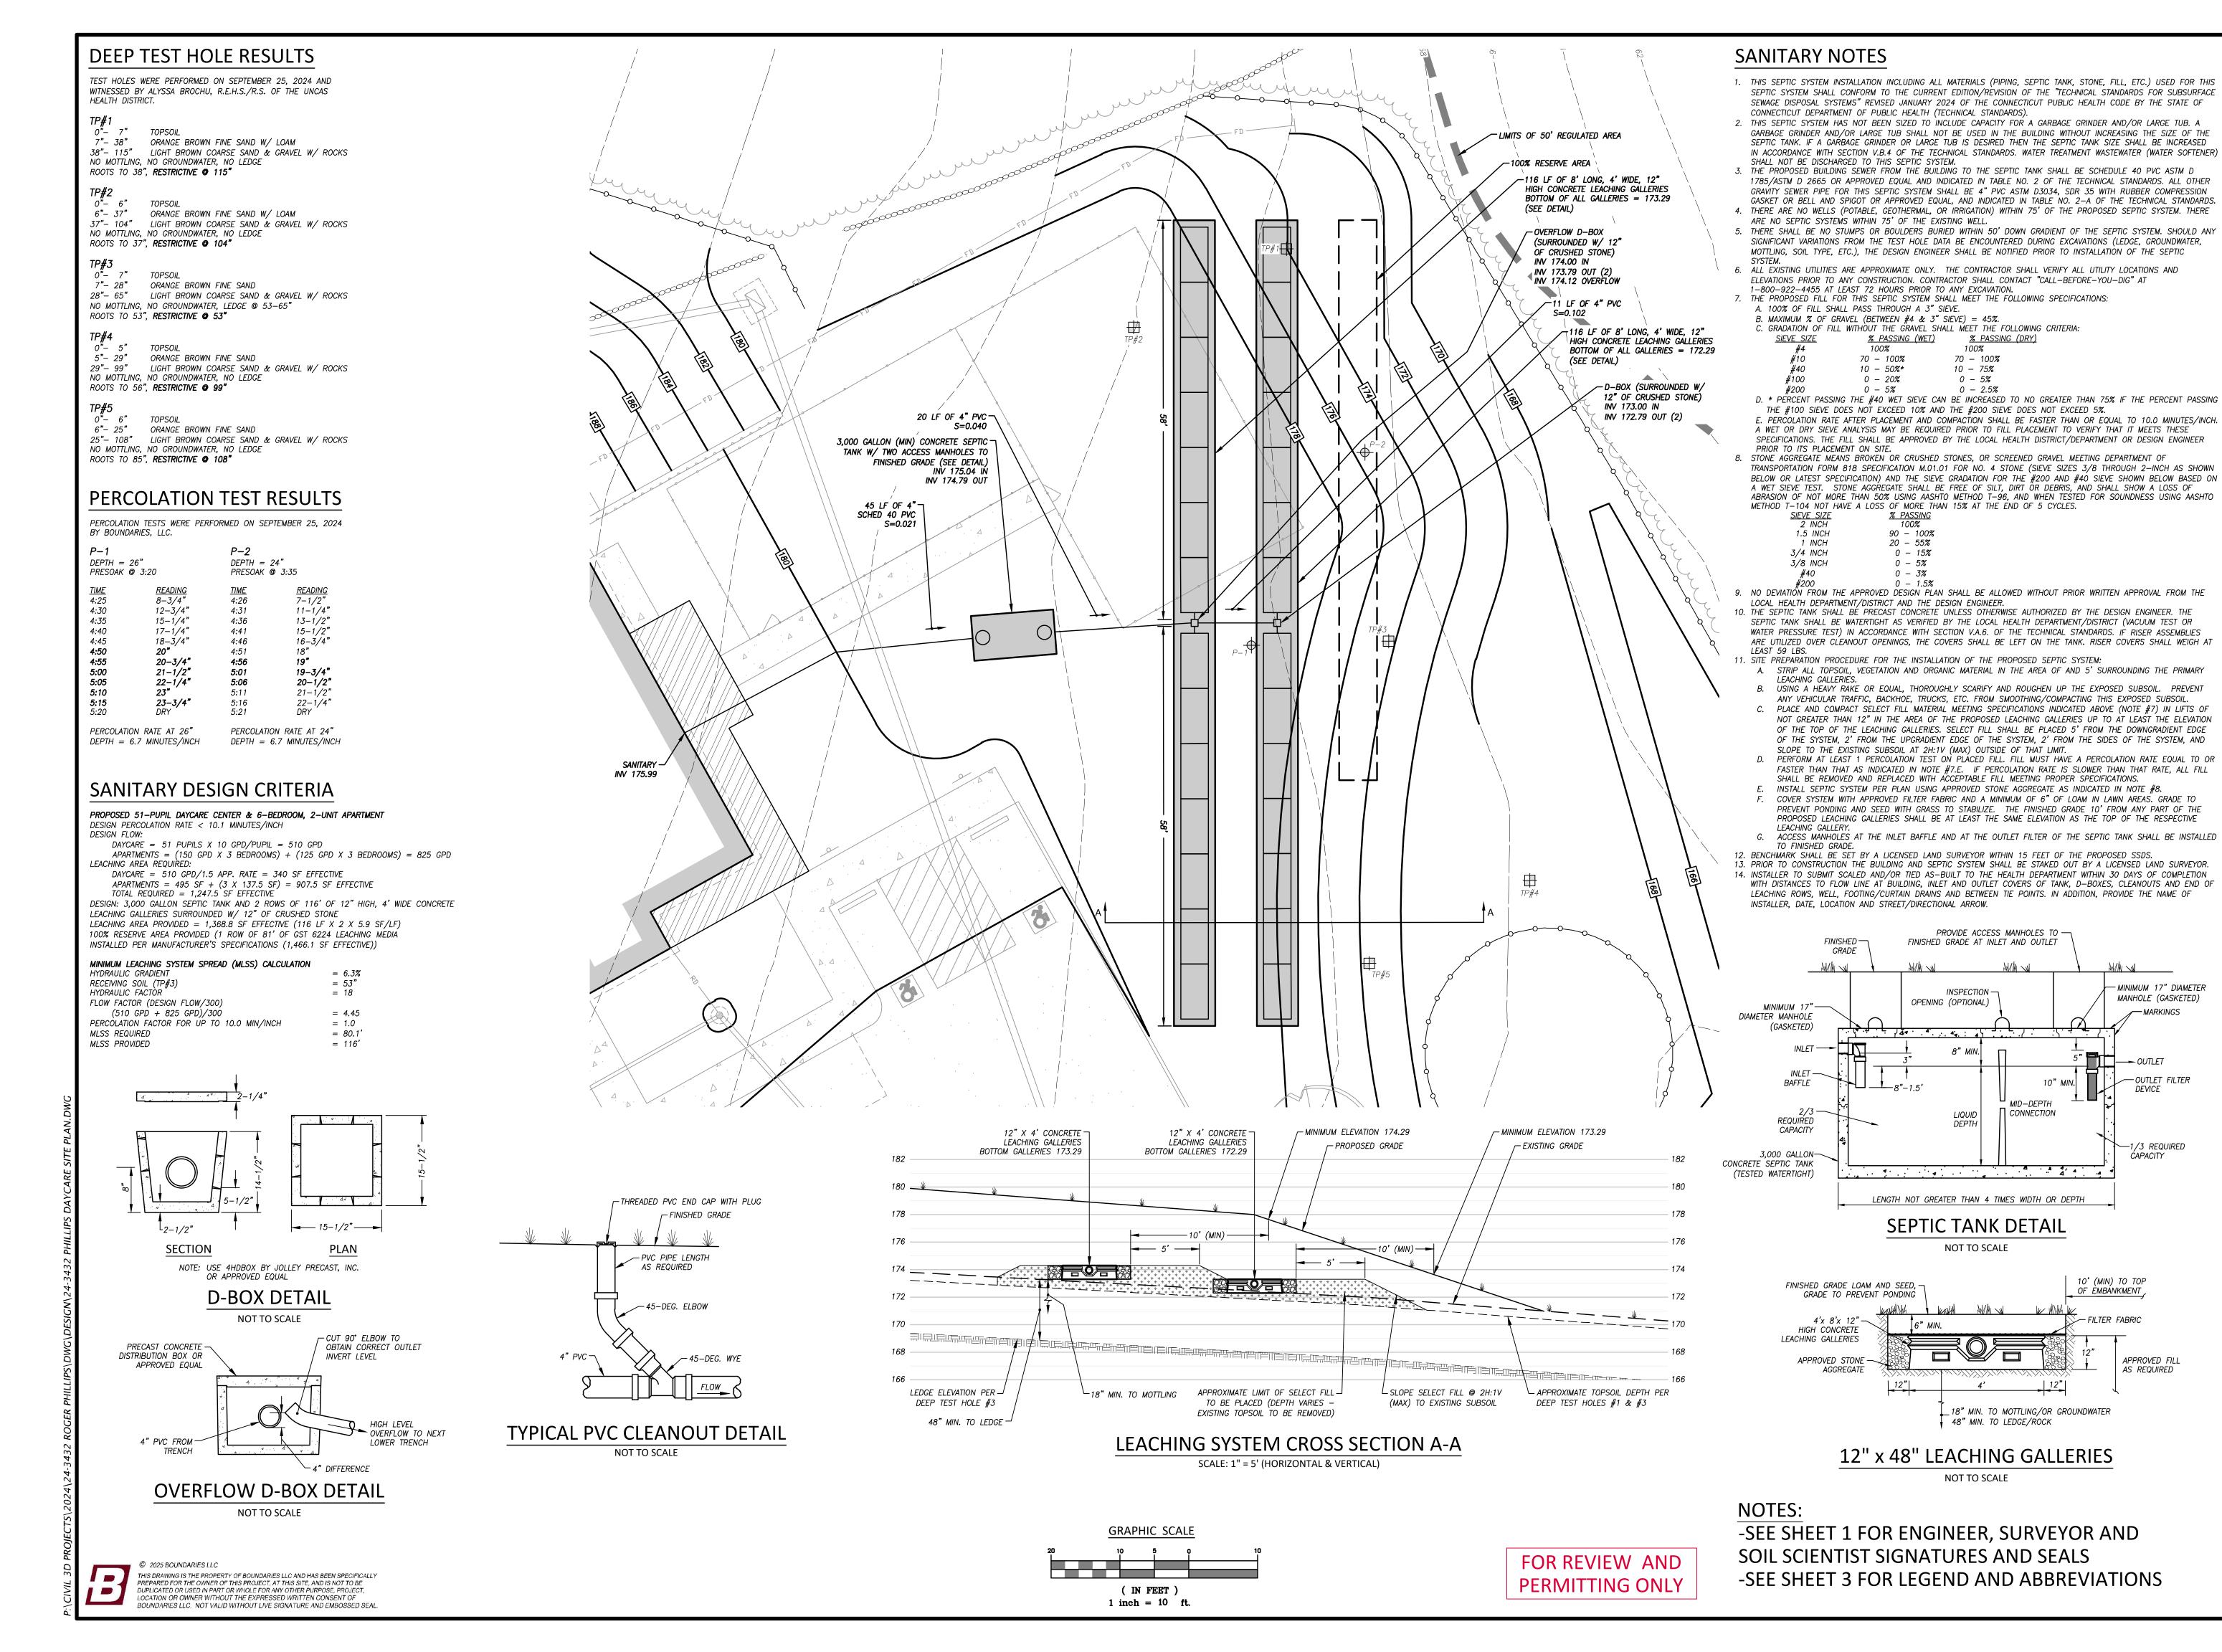

m

Б  $\Phi$ ا م Q 0 **O** S d 0 0 S Q Ø 0  $\sigma$  $\mathbf{C}$ 

mprovem

Sub

1" = 10'

February 2025 24-3432

Revisions

1 inch = 30 ft.

ARI

CIVIL ENGINEERING LAND SURVEYING

Topographic Driveway Profile" Prepared For et's Corner, ocation & icket's ute 85 - M Improvement

1" = 30'


February 2025

JOB I.D. NO. **24-3432** 

Revisions

SHEET NO.

8

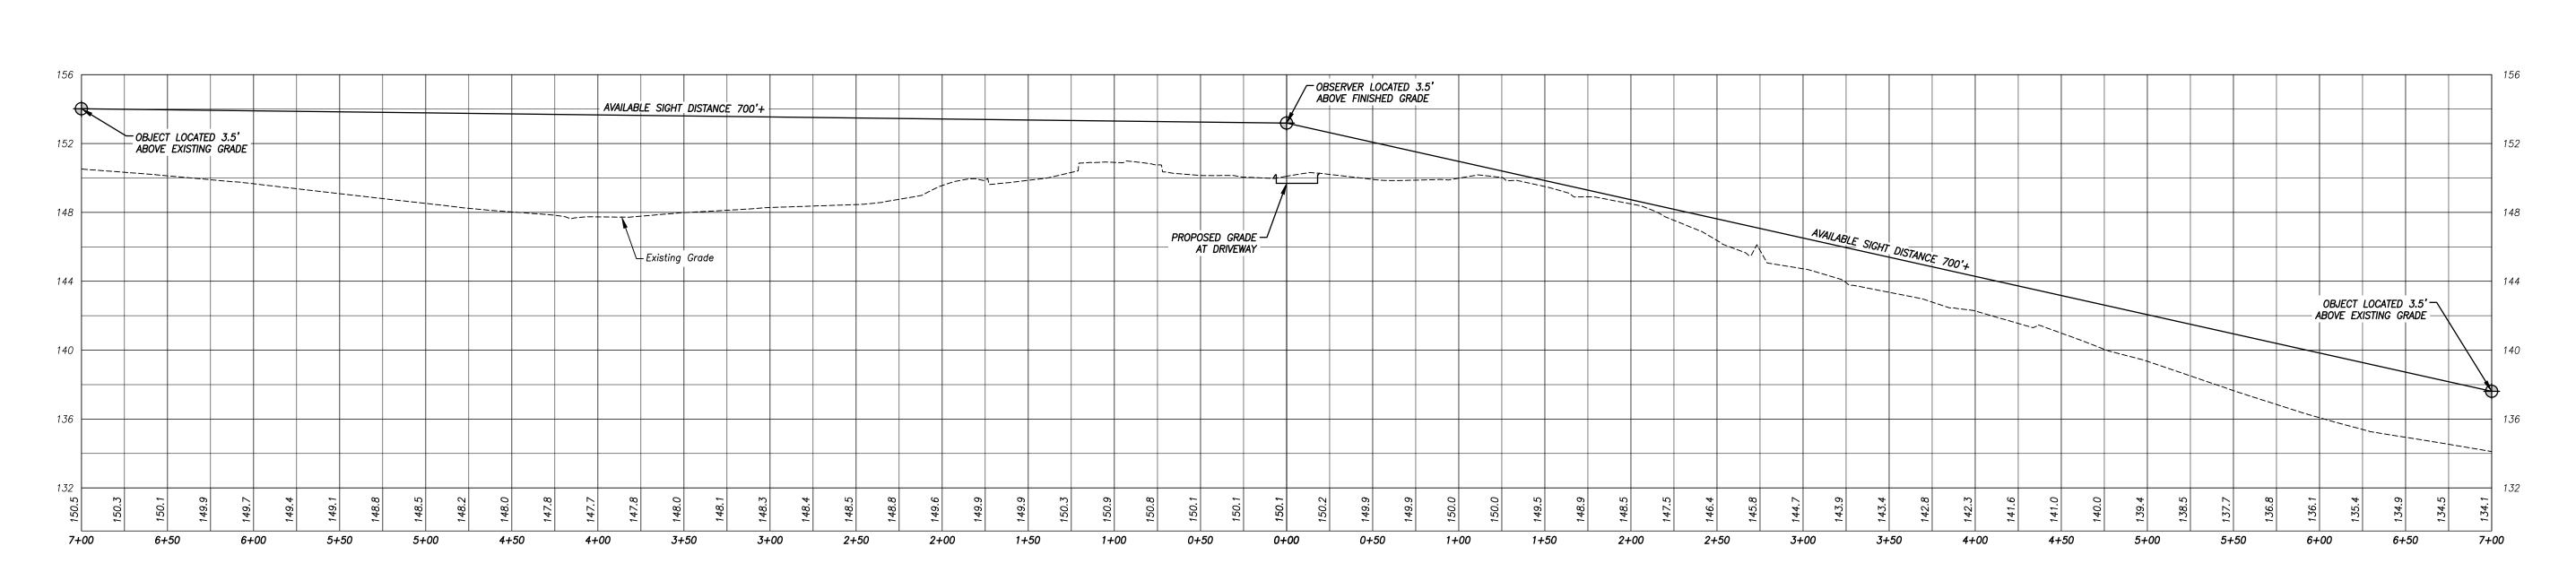

PROFILE - SIGHT LINE NORTHWEST

HORIZONTAL SCALE: 1" = 50' VERTICAL SCALE: 1" = 5'

PROFILE - SIGHT LINE SOUTHEAST HORIZONTAL SCALE: 1" = 50'

FOR REVIEW AND

PERMITTING ONLY

VERTICAL SCALE: 1" = 5'

**GRAPHIC SCALE** ( IN FEET ) 1 inch = 50 ft.

NOTES:

-SEE SHEET 1 FOR ENGINEER, SURVEYOR AND SOIL SCIENTIST SIGNATURES AND SEALS -SEE SHEET 3 FOR LEGEND AND ABBREVIATIONS

9

SHEET NO.

1" = 50'

JOB I.D. NO. 24-3432

Revisions

February 2025

CIVIL ENGINEERING LAND SURVEYING LAND USE PLANNING SOIL

cation & Topographic Survey
le Demonstration Plan"
Prepared For

ocation &

Improvement Lo "Sight Lir

Corner,


cket!sure 85 -

## LIGHTING NOTES

- CATALOG SPECIFICATIONS FOR THE LIGHTING FIXTURES SPECIFIED ON THIS PLAN HAVE BEEN SUBMITTED WITH THE APPLICATION FOR SITE PLAN REVIEW AND ARE INCLUDED IN THE COMMISSION'S PERMANENT FILE.
- ALL SITE LIGHTING SHALL BE FULL CUTOFF STYLE FIXTURES AND INCORPORATE FEATURES THAT MINIMIZE LIGHT TRESPASS ONTO ADJACENT PROPERTIES TO THE GREATEST EXTENT PRACTICABLE. NO SITE FEATURE OR ACTIVITY ASSOCIATED WITH THE OPERATION SHALL CREATE GLARE OR ILLUMINATION WHICH EXTENDS BEYOND THE SITE'S PROPERTY LINES AND CREATES A HAZARD OR NUISANCE TO A NEIGHBORING PROPERTY OR ON THE ADJACENT ROADWAY.
- ALL SITE LIGHTING, EXCEPT THAT DEEMED NECESSARY FOR SECURITY PURPOSES, SHALL BE TURNED OFF WHEN THE FACILITY IS NOT IN USE.

## LIGHTING SCHEDULE

- WL LUXMODE LO049-07804-04(3-4098D) LED OUTDOOR
- PL1 GARDCO ECF-S-32L-700-WW-G2-3-HIS ECOFORM AREA LED ECF SMALL, 32, LED'S, 3000K CCT, TYPE 3-HIS OPTIC, HOUSE-SIDE INTERNAL SHIELDING
- PL2 GARDCO ECF-S-32L-700-WW-G2-4-HIS ECOFORM AREA LED ECF SMALL, 32 LED'S, 3000K CCT, TYPE 4-HIS OPTIC, HOUSE-SIDE INTERNAL SHIELDING

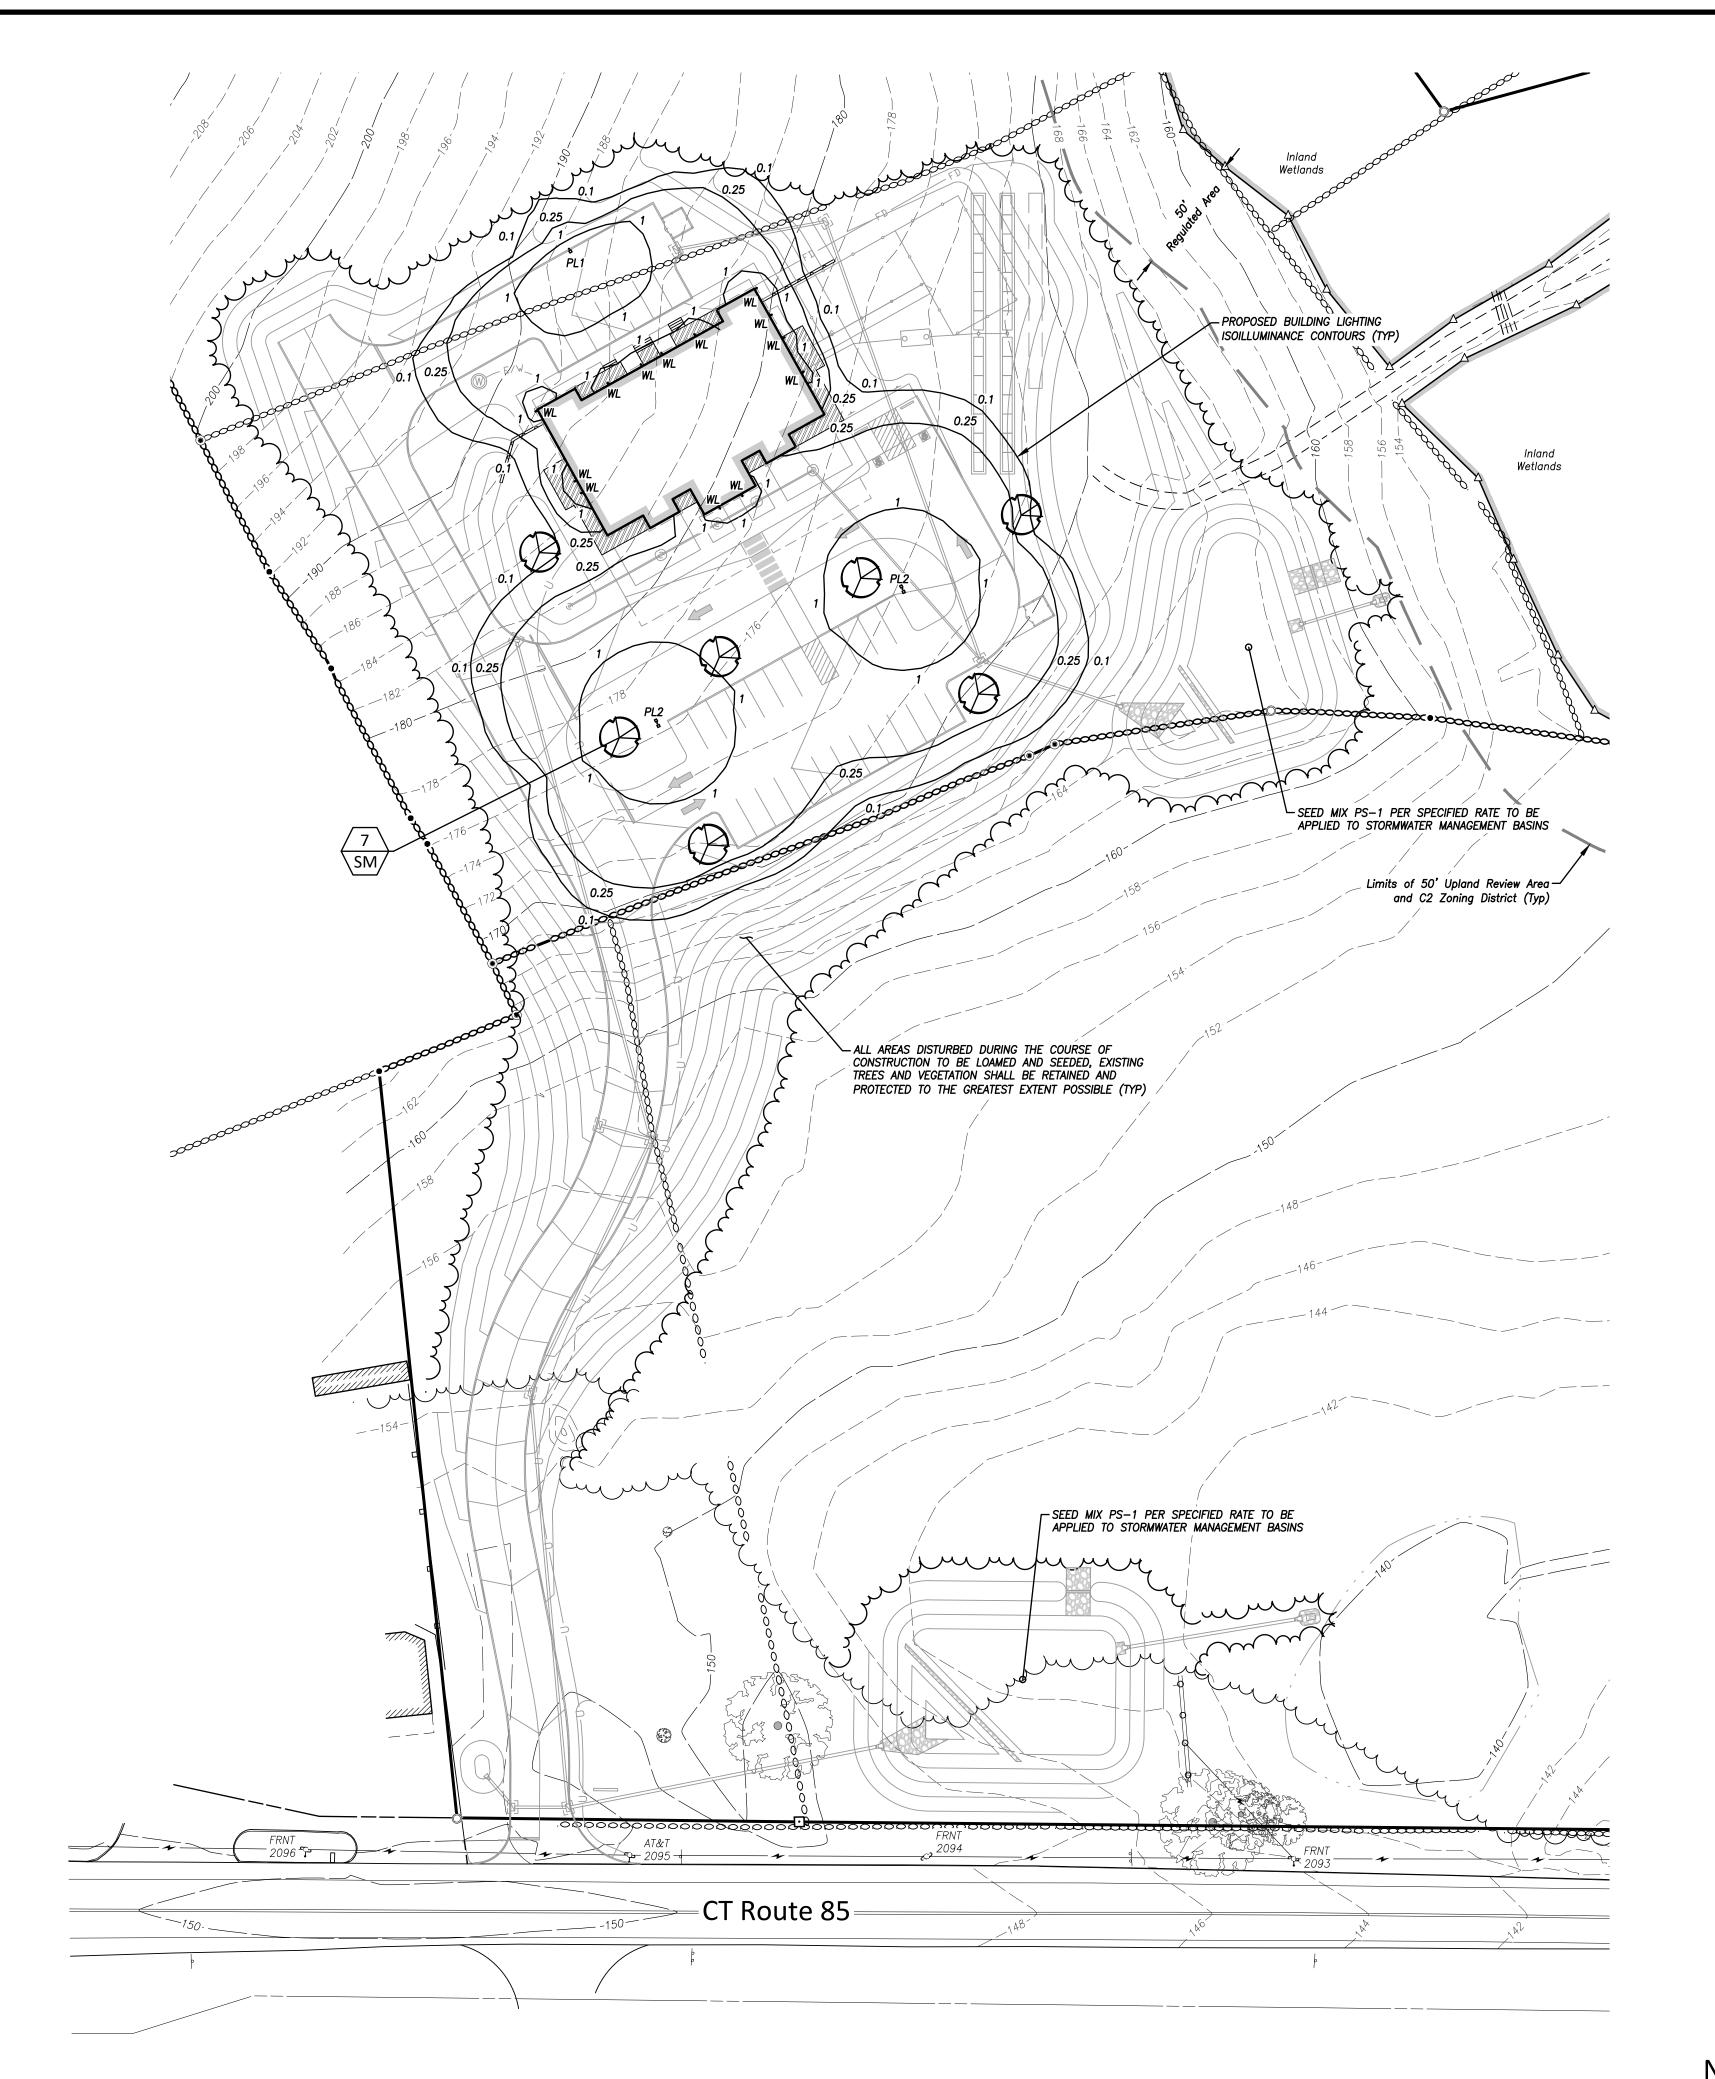

**GRAPHIC SCALE** 


( IN FEET ) 1 inch = 40 ft.

# LANDSCAPING SCHEDULE

DECIDUOUS TREES					
SYM	KEY	QTY.	NAME (BOTANICAL/COMMON)	SIZE	COMMENTS
$\bigcirc$	SM	7	Acer saccharum Sugar Maple	6-8' ht.	B.B.

LANDSCAPE PLANTING MATERIALS AS PROPOSED BY THIS PLAN ARE CONNECTICUT NATIVE AND/OR NON-INVASIVE SPECIES. THIS LANDSCAPE PLAN HAS BEEN DESIGNED TO INCORPORATE SPECIÉS WHICH ARE PROLIFIC IN USDA PLANT HARDINESS ZONE 6B AND WHICH REQUIRE MINIMAL ENERGY INPUT FOR UPKEEP AND MAINTENANCE. REFERENCES UTILIZED FOR CONNECTICUT NATIVE AND NON-INVASIVE SPECIES SELECTION INCLUDE THE CONNECTICUT BOTANICAL SOCIETY, THE CONNECTICUT AGRICULTURAL EXPERIMENT STATION, THE U.S. DEPARTMENT OF TRANSPORTATION FEDERAL HIGHWAY ADMINISTRATION AND OTHER SOURCES.

LANDSCAPE PLANTING MATERIALS AS PROPOSED BY THIS PLAN ARE INTENDED TO BE A MINIMUM. THE APPLICANT RESERVES THE RIGHT TO ADD ADDITIONAL LANDSCAPE MATERIALS AT THEIR DISCRETION.

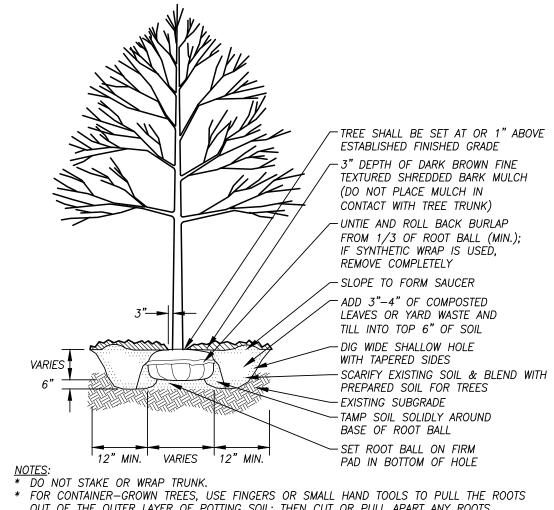

- OUT OF THE OUTER LAYER OF POTTING SOIL: THEN CUT OR PULL APART ANY ROOTS CIRCLING THE PERIMETER OF THE CONTAINER.
- \* FOR RED CEDARS INCORPORATE COMMERCIALLY PREPARED MYCORRHIZA SPORES IN THE SOIL IMMEDIATELY AROUND THE ROOT BALL AT RATES SPECIFIED BY THE MANUFACTURER.

  \* AT PLANTING THOROUGHLY SOAK THE TREE ROOT BALL AND ADJACENT SOIL REPEAT SEVERAL TIMES DURING THE FIRST MONTH AND THROUGHOUT THE FOLLOWING TWO SUMMERS.

TREE PLANTING DETAIL

ING LAND SOUNTERM

m

aph  $\boldsymbol{\sigma}$ Topogra 집 G ocation. ָה מַ  $\mathbf{C}$ ands. Improvement L

orn

1" = 40'

February 2025

JOB I.D. NO. 24-3432

Revisions

SHEET NO.

10

NOTES:

FOR REVIEW AND

**PERMITTING ONLY** 

-SEE SHEET 1 FOR ENGINEER, SURVEYOR AND SOIL SCIENTIST SIGNATURES AND SEALS -SEE SHEET 3 FOR LEGEND AND ABBREVIATIONS

#### **NARRATIVE**

THIS PROPOSAL INVOLVES IMPROVEMENTS TO AN EXISTING 6.16± ACRE PROPERTY LOCATED AT 1685 ROUTE 85 AND AN EXISTING 11.72± ACRE PROPERTY LOCATED AT 879
CHESTERFIELD ROAD, BOTH IN THE TOWN OF MONTVILLE, CONNECTICUT. 1685 ROUTE 85 PREVIOUSLY CONTAINED A RESIDENCE THAT HAS SINCE BEEN DEMOLISHED AND REMOVED AND
BOTH PROPERTIES ARE CURRENTLY VACANT. THE PROPERTIES ARE MOSTLY WOODED WITH THE EXCEPTION OF A GRASSED AREA ALONG THE FRONTAGE OF 1685 ROUTE 85. THE CURRENT
ZONING DESIGNATION OF BOTH PROPERTIES IS COMMERCIAL-2 (C-2). 879 CHESTERFIELD ROAD IS TO BE MERGED WITH 1685 ROUTE 85.

THE PROPOSED USE OF THESE PROPERTIES IS TO SERVE AS A DAYCARE WITH A 2—UNIT APARTMENT ABOVE, A USE PERMITTED IN THE C—2 ZONE PER SECTION 11.2 OF THE MONTVILLE ZONING REGULATIONS BY SITE PLAN APPROVAL.

IMPROVEMENTS TO THE SITE REQUIRED TO SUPPORT THE PROPOSED USE INCLUDES: CONSTRUCTION OF A 2-STORY WOOD FRAMED BUILDING HAVING A 6,300± SF FOOTPRINT TO CONTAIN A 6-CLASSROOM DAYCARE FACILITY CONTAINING 6,103 SF ON THE GROUND FLOOR AND 2 3-BEDROOM APARTMENTS CONTAINING 2,362 SF EACH ON THE SECOND FLOOR, CONSTRUCTION OF 2 PLAYGROUND AREAS TO SUPPORT THE DAYCARE FACILITY, CONSTRUCTION OF A NEW BITUMINOUS CONCRETE ACCESS DRIVEWAY AND REQUIRED PARKING INCLUDING ADA ACCESSIBLE SPACES MEETING THE ZONING REQUIREMENTS, INSTALLATION OF A SUBSURFACE SEWAGE DISPOSAL SYSTEM TO SERVE THE BUILDING, INSTALLATION OF A NEW DRILLED WELL, AND STORMWATER MANAGEMENT FEATURES.

ACCORDING TO THE UNITED STATES DEPARTMENT OF AGRICULTURE (USDA), NATURAL RESOURCES CONSERVATION SERVICE (NRCS) WEB SOIL SURVEY FOR THE STATE OF CONNECTICUT, THE SOILS LOCATED UPON THE SUBJECT PROPERTY CONSIST OF:

- RIDGEBURY, LEICESTER, AND WHITMAN SOILS, 0-8% SLOPES, EXTREMELY STONY, HYDROLOGIC SOIL GROUP D
- 29B AGAWAM FINE SANDY LOAM, 3-8% SLOPES, HYDROLOGIC SOIL GROUP B
  62C CANTON AND CHARLTON FINE SANDY LOAMS, 3-15% SLOPES, EXTREMELY SONY, HYDROLOGIC SOIL GROUP B
- 73C CHARLTON—CHATFIELD COMPLEX, 0—15% SLOPES, VERY ROCKY, HYDROLOGIC SOIL GROUP B 75E HOLLIS—CHATFIELD—ROCK OUTCROP COMPLEX, 15—45% SLOPES, HYDROLOGIC SOIL GROUP D

THERE ARE INLAND WETLANDS LOCATED ON THE EASTERN PORTION OF 879 CHESTERFIELD ROAD. THERE ARE NO INLAND WETLANDS LOCATED ON 1685 ROUTE 85. INLAND WETLANDS WERE DELINEATED BY IAN T. COLE, A REGISTERED SOIL SCIENTIST, ON MARCH 27, 2024. NO ACTIVITY WITHIN DELINEATED WETLANDS OR THE 50 FOOT UPLAND REVIEW AREA IS PROPOSED BY THIS PLAN.

TOPSOIL SHALL BE STOCKPILED ON SITE FOR REUSE IN CONJUNCTION WITH FINAL GRADING AND STABILIZATION, FOR STABILIZING AREAS OUTSIDE OF BUILDING, CIRCULATION AND PARKING AREAS AFTER GRADING IS COMPLETED, A 4" MINIMUM DEPTH OF TOPSOIL SHALL BE PLACED AND SEEDED WITH GRASS AND MULCHED FOR PERMANENT STABILIZATION.

SEDIMENT FENCE AND/OR WOOD CHIP BERMS WILL BE INSTALLED AT LOCATIONS SHOWN PRIOR TO ANY EARTHWORK OPERATIONS. THESE MEASURES WILL BE MAINTAINED UNTIL ALL DISTURBED AREAS HAVE BEEN PERMANENTLY STABILIZED.

### **CONSTRUCTION SEQUENCE**

- SECURE ALL NECESSARY LOCAL, STATE AND FEDERAL PERMITS.
  . CLEAR VEGETATION IN THE PROPOSED DEVELOPMENT AREA. PROPERLY DISPOSE OF VEGETATION.
- 2. CLEAR VEGETATION IN THE PROPOSED DEVELOPMENT AREA. PROPERLY DISPOSE OF VEGETATION. 3. REMOVE EXISTING GRAVEL DRIVEWAY, PAVED APRON AND CONCRETE PAD PER PLANS.
- 4. INSTALL SEDIMENT FENCE AND/OR WOOD CHIP BERMS AS SHOWN DOWNGRADIENT OF PROPOSED DEVELOPMENT AREA. STRIP TOPSOIL FROM DEVELOPMENT AREA AND STOCKPILE AT AN APPROVED LOCATION FOR LATER REUSE. SEED TOPSOIL STOCKPILE WITH RYEGRASS FOR TEMPORARY STABILIZATION. REMOVE AND DISPOSE OF STUMPS AT AN APPROVED
- 5. CONSTRUCT PROPOSED IMPROVEMENTS, INSTALL PROPOSED SITE UTILITIES AND SUBSURFACE DISPOSAL SYSTEM, GRADE PROPOSED PARKING AREA AND CIRCULATION DRIVES, AND CONSTRUCT PROPOSED BUILDING.
- 6. AFTER STABILIZATION OF THE CIRCULATION DRIVES AND OTHER UPGRADIENT AREAS EXCAVATE AND INSTALL THE PROPOSED STORMWATER INFILTRATION SYSTEMS.
  7. AT COMPLETION OF CONSTRUCTION, LOAM ALL DISTURBED AREAS (4" MINIMUM), SEED WITH GRASS. AFTER ALL AREAS HAVE BEEN PERMANENTLY STABILIZED, REMOVE EROSION
- CONTROL MEASURES.

## **OPERATION & MAINTENANCE OF EROSION CONTROLS**

NO CONSTRUCTION SHALL PROCEED UNTIL PROPER SEDIMENTATION AND EROSION CONTROL METHODS HAVE BEEN INSTALLED AS THE SEQUENCE OF CONSTRUCTION NECESSITATES.

ALL TEMPORARY FILL, STORAGE OR STOCKPILE AREAS SHALL BE PROPERLY STABILIZED TO PREVENT EROSION AND SUITABLY CONTAINED TO PREVENT TURBID RUNOFF. ALL AREAS AFFECTED BY TEMPORARY FILLS MUST BE RESTORED TO THEIR ORIGINAL CONTOURS, AND REVEGETATED WITH SUITABLE VEGETATION. THE USE OF TEMPORARY FILL AND/OR EXCAVATION SHALL BE MINIMIZED TO ONLY THAT AREA REQUIRED TO PERFORM THE WORK.

DUMPING OF OIL OR OTHER DELETERIOUS MATERIALS ON THE GROUND IS FORBIDDEN. THE DEVELOPER OR CONTRACTOR SHALL PROVIDE A MEANS OF CATCHING, RETAINING AND PROPERLY DISPOSING OF DRAINED OIL, REMOVED OIL FILTERS, OR OTHER DELETERIOUS MATERIAL FROM EQUIPMENT USED ON SITE. VEHICLE MAINTENANCE SHALL BE COMPLETED OFF SITE. ALL OIL SPILLS SHALL BE IMMEDIATELY REPORTED TO THE DEPARTMENT OF ENERGY AND ENVIRONMENTAL PROTECTION/HAZARDOUS MATERIALS OFFICE. FAILURE TO DO SO MAY RESULT IN THE IMPOSITION OF FINES UNDER THE APPLICABLE CONNECTICUT GENERAL STATUTES.

EVERY PRECAUTION SHALL BE USED DURING CONSTRUCTION TO PREVENT AND MINIMIZE THE DEGRADATION OF THE EXISTING WATER QUALITY. ALL ACTIVITIES SHALL BE IN CONFORMANCE TO AND CONSISTENT WITH ALL APPLICABLE WATER QUALITY STANDARDS AND MANAGEMENT PRACTICES AS SET FORTH BY LOCAL, STATE AND FEDERAL AGENCIES.

DURING THE PERIOD OF CONSTRUCTION, THE CONTRACTOR IS RESPONSIBLE FOR ALL EROSION AND SEDIMENT CONTROL MEASURES. SAID MEASURES SHALL BE INSPECTED WEEKLY AND AFTER EACH RAINSTORM WITH GREATER THAN 0.5—INCHES OF RAINFALL. ACCUMULATED DEPOSITS OF SEDIMENT AND SILT SHALL BE PERIODICALLY REMOVED FROM THE UPSTREAM SIDE OF THE EROSION AND SEDIMENT CONTROL BARRIERS, AND UPON ESTABLISHMENT OF PERMANENT VEGETATIVE COVER. SUCH MATERIALS REMOVED SHALL BE SPREAD AND STABILIZED IN NON—WETLAND AREAS WHICH ARE NOT SUBJECT TO EROSION, OR WHICH ARE NOT TO BE PAVED OR BUILT UPON.

SEDIMENT FENCE, WOOD CHIP BERMS AND OTHER EROSION AND SEDIMENT CONTROL MEASURES SHALL BE REPAIRED, CLEANED AND/OR REPLACED AS NECESSARY THROUGHOUT THE CONSTRUCTION PERIOD IN ORDER TO MAINTAIN COMPLETE AND INTEGRAL EROSION AND SEDIMENT CONTROL PROTECTION. ONCE IN PLACE, ALL EROSION AND SEDIMENT CONTROL FACILITIES AND MEASURES ARE TO REMAIN IN PLACE AND IN PROPER CONDITION AND BE CONTINUOUSLY MAINTAINED UNTIL FINAL GRADING HAS BEEN COMPLETED, ALL DISTURBED AREAS UPGRADIENT OF SAID FACILITIES HAVE BEEN PERMANENTLY STABILIZED, AND ALL NEWLY GRASSED AREAS HAVE HAD AT LEAST TWO MOWINGS. FOLLOWING SUCH PERMANENT STABILIZATION, THE FACILITIES SHALL BE DISMANTLED, REMOVED, AND DISPOSED OF IN AN APPROVED MANNER. ADDITIONAL EROSION AND SEDIMENT CONTROL MEASURES BEYOND THOSE SHOWN ON THE PLANS OR PRESCRIBED HEREIN SHALL BE PUT IN PLACE, WHENEVER NECESSARY, TO ADDRESS FIELD CONDITIONS AND/OR AS ORDERED BY TOWN STAFF.

DISTURBANCE OF THE LAND SHALL BE LIMITED TO THE MINIMUM EXTENT NECESSARY TO COMPLETE THE PROPOSED DEVELOPMENT. ALL EXISTING TREES AND SHRUBS SHALL BE CONSERVED WHERE POSSIBLE, EXCEPT THOSE WHOSE REMOVAL IS REQUIRED TO PERFORM THE PROPOSED WORK. THE LIMITS OF DISTURBANCE SHALL BE ESTABLISHED IN THE FIELD PRIOR TO STARTING ANY ACTUAL CONSTRUCTION ACTIVITIES AND SHALL BE GENERALLY AS DEPICTED ON THIS PLAN.

THE SITE CONTRACTOR SHALL BE RESPONSIBLE TO INSPECT THE SITE IN ACCORDANCE WITH THE PROCEDURES AS OUTLINED IN THE "GENERAL PERMIT FOR THE DISCHARGE OF STORMWATER AND DEWATERING WASTEWATERS FROM CONSTRUCTION ACTIVITIES" AS ADOPTED BY THE DEPARTMENT OF ENERGY AND ENVIRONMENTAL PROTECTION, EFFECTIVE ON DECEMBER 31 2020

THE CONTRACTOR SHALL INSPECT ALL DISTURBED AREAS OF CONSTRUCTION ACTIVITY THAT HAVE NOT BEEN FINALLY STABILIZED, STRUCTURAL CONTROL MEASURES, AND LOCATIONS WHERE VEHICLES ENTER OR EXIT THE SITE AT LEAST ONCE EVERY SEVEN CALENDAR DAYS AND WITHIN 24 HOURS OF THE END OF ALL RAIN EVENTS. WHERE SITES HAVE BEEN TEMPORARILY OR FINALLY STABILIZED, SUCH INSPECTION SHALL BE CONDUCTED AT LEAST ONCE EVERY MONTH FOR THREE CONSECUTIVE MONTHS.

DURING CONSTRUCTION AND IMMEDIATELY FOLLOWING CONSTRUCTION, THE CONTRACTOR SHALL BE RESPONSIBLE FOR SITE INSPECTION AND MAINTENANCE TO ASSURE PROPER PERFORMANCE OF THE SEDIMENTATION AND EROSION CONTROL SYSTEM. INSPECTING AND MAINTAINING SHALL INCLUDE, AT A MINIMUM, THE FOLLOWING:

\* INSPECTION OF ALL SEDIMENT FENCE/WOOD CHIP BERMS, REMOVE ACCUMULATED SEDIMENT IF REQUIRED (GREATER THAN 4" DEPTH)
\* INSPECTION OF ANTI-TRACKING PAD, REMOVE, DISPOSE AND REPLACE IF PAD IS NO LONGER FUNCTIONAL IN THE COLLECTION OF SEDIMENTS FROM VEHICULAR/TRUCK TRAFFIC.

\* INSPECTION OF ANTI-TRACKING PAD, REMOVE, DISPOSE AND REPLACE IF PAD IS NO LONGER FUNCTIONAL IN THE COLLECTION OF SEDIMENTS FROM VEHICULAR/TRUCK TRAFFIC.

\* INSPECTION OF ALL DRIVEWAY AND PARKING AREAS AFTER PAVING, REMOVE ACCUMULATED SEDIMENT AND ANY LITTER/DEBRIS.

DISTURBED AREAS AND AREAS USED FOR STORAGE OF MATERIALS THAT ARE EXPOSED TO PRECIPITATION SHALL BE INSPECTED FOR EVIDENCE OF, OR THE POTENTIAL FOR, POLLUTANTS ENTERING THE DRAINAGE SYSTEM. EROSION AND SEDIMENT CONTROL MEASURES IDENTIFIED IN THE PLAN SHALL BE INSPECTED TO INSURE THAT THEY ARE OPERATING CORRECTLY. DISCHARGE LOCATIONS OR POINTS SHALL BE INSPECTED TO ASCERTAIN WHETHER EROSION CONTROL MEASURES ARE EFFECTIVE IN PREVENTING SIGNIFICANT IMPACTS TO DOWNSTREAM WATERS. LOCATIONS WHERE VEHICLES ENTER OR EXIT THE SITE SHALL BE INSPECTED FOR EVIDENCE OF OFF—SITE SEDIMENT TRACKING.

ADDITIONAL EROSION AND SEDIMENT CONTROL MEASURES BEYOND THOSE DEPICTED HEREIN SHALL BE PUT IN PLACE WHENEVER NECESSARY TO ADDRESS FIELD CONDITIONS AND/OR AS ORDERED BY TOWN STAFF, OR THEIR DESIGNATED AGENT.

THE SITE CONTRACTOR SHALL APPOINT AN AGENT WHO SHALL BE PERSONALLY RESPONSIBLE FOR IMPLEMENTING THIS EROSION AND SEDIMENT CONTROL PLAN AND ENFORCING THE PRESCRIBED SAFEGUARDS DURING THE CONSTRUCTION PERIOD.

THIS RESPONSIBILITY INCLUDES THE INSTALLATION AND MAINTENANCE OF CONTROL MEASURES THROUGHOUT THE CONSTRUCTION PERIOD, INFORMING ALL PARTIES ENGAGED ON THE CONSTRUCTION SITE OF THE REQUIREMENTS AND OBJECTIVES OF THE PLAN, NOTIFYING THE PROPER TOWN AGENCIES AND OFFICIALS OF ANY TRANSFER OF THIS RESPONSIBILITY, AND CONVEYING A COPY OF THE APPROVED EROSION AND SEDIMENT CONTROL PLAN IF THE TITLE OF THE LAND IS TRANSFERRED TO A THIRD PARTY.

## **EROSION CONTROL NOTES**

- 1. ALL UTILITIES ARE APPROXIMATE. CONTRACTOR TO VERIFY ALL UTILITIES PRIOR TO CONSTRUCTION. CONTACT "CALL—BEFORE—YOU—DIG" AT 1—800—922—4455 AT LEAST 72 HOURS PRIOR TO ANY EXCAVATION.
- 2. THE RESPONSIBLE PARTY WITH RESPECT TO THE INSTALLATION AND MAINTENANCE OF ALL EROSION CONTROL MEASURES SHALL BE THE SITE CONTRACTOR (TO BE DETERMINED).

  3. THE "CONNECTICUT GUIDELINES FOR SOIL EROSION AND SEDIMENT CONTROL" BY THE COUNCIL ON SOIL AND WATER CONSERVATION IN COLLABORATION WITH THE CONNECTICUT
- 3. THE "CONNECTICUT GUIDELINES FOR SOIL EROSION AND SEDIMENT CONTROL" BY THE COUNCIL ON SOIL AND WATER CONSERVATION IN COLLABORATION WITH THE CONNECTICUT

  DEPARTMENT OF ENERGY AND ENVIRONMENTAL PROTECTION PUBLICATION DATE: SEPTEMBER 30, 2023, SHALL BE USED FOR INSTALLING AND MAINTAINING ALL EROSION CONTROL

  MEASURES. THE SITE CONTRACTOR SHALL INSTALL ADDITIONAL MEASURES AS NECESSARY IF DIRECTED BY THE ENGINEER OR TOWN STAFF.
- 4. SEEDING FOR PERMANENT STABILIZATION SHALL BE DONE BETWEEN APRIL 15 THROUGH JUNE 15 OR BETWEEN AUGUST 15 THROUGH SEPTEMBER 15. IF SEEDING CANNOT BE DONE WITHIN THESE TIMES, APPLICATION OF TEMPORARY MULCH WILL BE CONDUCTED UNTIL THE NEXT SEEDING PERIOD. SEED MIXTURE SHALL BE AS FOLLOWS:


  KENTUCKY BLUEGRASS

  20 LBS/ACRE OR 0.45 LBS/1,000 SF
- CREEPING RED FESCUE 20 LBS/ACRE OR 0.45 LBS/1,000 SF
  PERENNIAL RYEGRASS 5 LBS/ACRE OR 0.10 LBS/1,000 SF
- MULCH SHALL BE A GOOD QUALITY HAY OR STRAW AND SHALL BE APPLIED AT A RATE OF APPROXIMATELY 2-3 BALES/1,000 SF.
   ALL EROSION CONTROL MEASURES SHALL BE INSPECTED WITHIN 24 HOURS AFTER RAIN EVENTS WITH GREATER THAN 0.5" OF RAINFALL IN A 24-HOUR PERIOD, AND REPAIRED OR REPLACED AS NECESSARY TO INSURE COMPLIANCE WITH THE APPROVED SOIL EROSION AND SEDIMENT CONTROL PLAN.

# STORMWATER SYSTEM OPERATION AND MAINTENANCE


- 1. THE PROPOSED STORMWATER MANAGEMENT SYSTEM INCLUDES DEEP SUMP CATCH BASINS, STORMWATER BASINS, SPILLWAYS, AND RIP RAP APRONS.
- 1.1. CATCH BASINS SHALL BE INSPECTED ANNUALLY, AS SOON AS POSSIBLE FOLLOWING THE SNOW AND ICE REMOVAL SEASON, PREFERABLY PRIOR TO SPRING RAINFALL EVENTS.

  CATCH BASIN CLEANING SHOULD OCCUR IF SEDIMENT HAS FILLED ONE HALF OF THE TOTAL SUMP DEPTH (I.E. LESS THAN TWO FEET FROM THE INVERT OF THE OUTLET PIPE TO THE SEDIMENT DEPOSIT.) SEDIMENT SHALL BE DISPOSED OF IN ACCORDANCE WITH APPLICABLE REGULATIONS.
- 1.2. THE STORMWATER BASINS SHALL BE INSPECTED SEMI—ANNUALLY FOR SIGNS OF SCOUR/EROSION, EVIDENCE OF STORMWATER PONDING GREATER THAN 48—HOURS AFTER THE END
  OF A STORM EVENT, ACCUMULATION OF DEBRIS AND SEDIMENT IN THE BASINS AND AT THE SPILLWAYS. AREAS OF EROSION SHALL BE REPAIRED BY LOAMING AND SEEDING OR
  REPLACING GRAVEL AND RIP RAP AS APPROPRIATE. SEDIMENT AND DEBRIS SHALL BE REMOVED AND DISPOSED OF AS REQUIRED. VEGETATION WITHIN THE BASIN SHALL BE
  MOWED ANNUALLY AND ALL WOODY BRUSH SHALL BE REMOVED.
- 1.3. THE SPILLWAYS SHALL BE INSPECTED SEMI—ANNUALLY FOR SIGNS OF SCOUR/EROSION. IF SCOUR HAS OCCURRED THE RIP RAP AND GRAVEL SHALL BE REPLACED AND THE SPILLWAY SHALL BE EVALUATED FOR POSSIBLE MODIFICATIONS TO PREVENT FUTURE SCOUR.
- 1.4. RIP RAP APRONS SHALL BE INSPECTED SEMI—ANNUALLY FOR SIGNS OF SCOUR AND ACCUMULATION OF DEBRIS AND SEDIMENT. IF SCOUR HAS OCCURRED THE RIP RAP AND GRAVEL SHALL BE REPLACED. DEBRIS SHALL BE DISPOSED OF AS REQUIRED.
- 2. STORMWATER MANAGEMENT SYSTEM MAINTENANCE COSTS MAY BE REDUCED BY IMPLEMENTING A STREET SWEEEPING PROGRAM, TO BE PERFORMED AT LEAST ANNUALLY IMMEDIATELY FOLLOWING THE SNOW AND ICE REMOVAL SEASON.

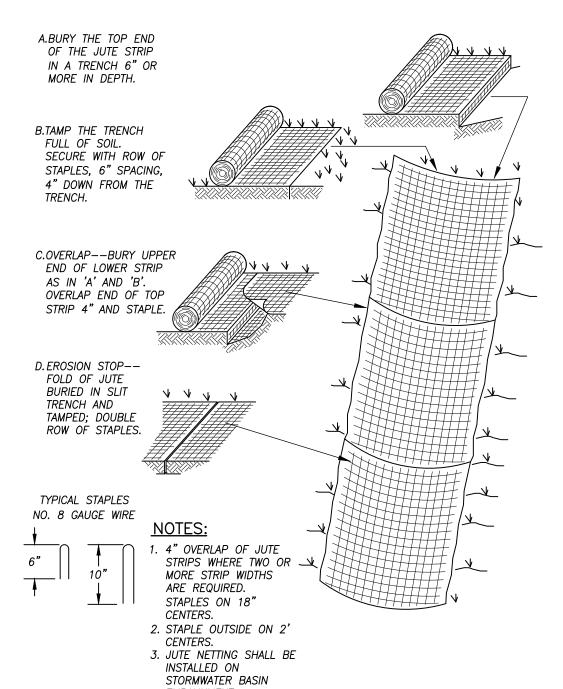


JUTE NETTING DETAIL

NOT TO SCALE

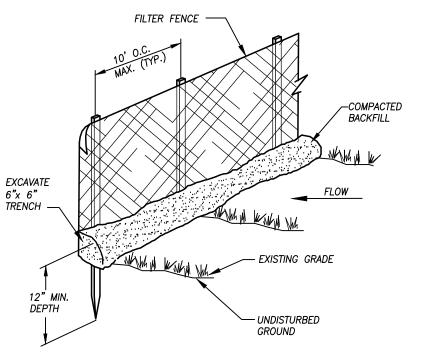


SEDIMENT FENCE DETAIL


NOT TO SCALE

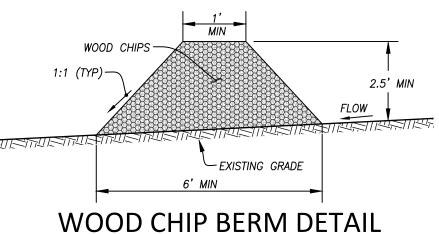

NOT TO SCALE

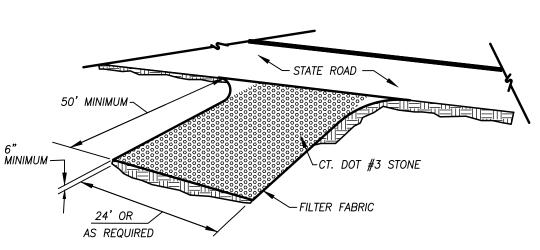


ANTI-TRACKING PAD AT DRIVEWAY

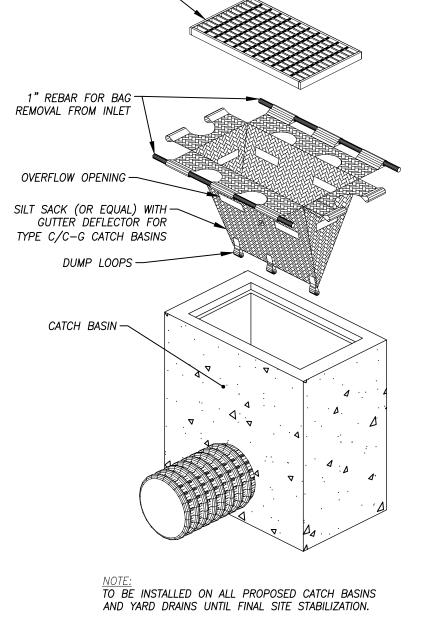

CATCH BASIN INLET PROTECTION

NOT TO SCALE

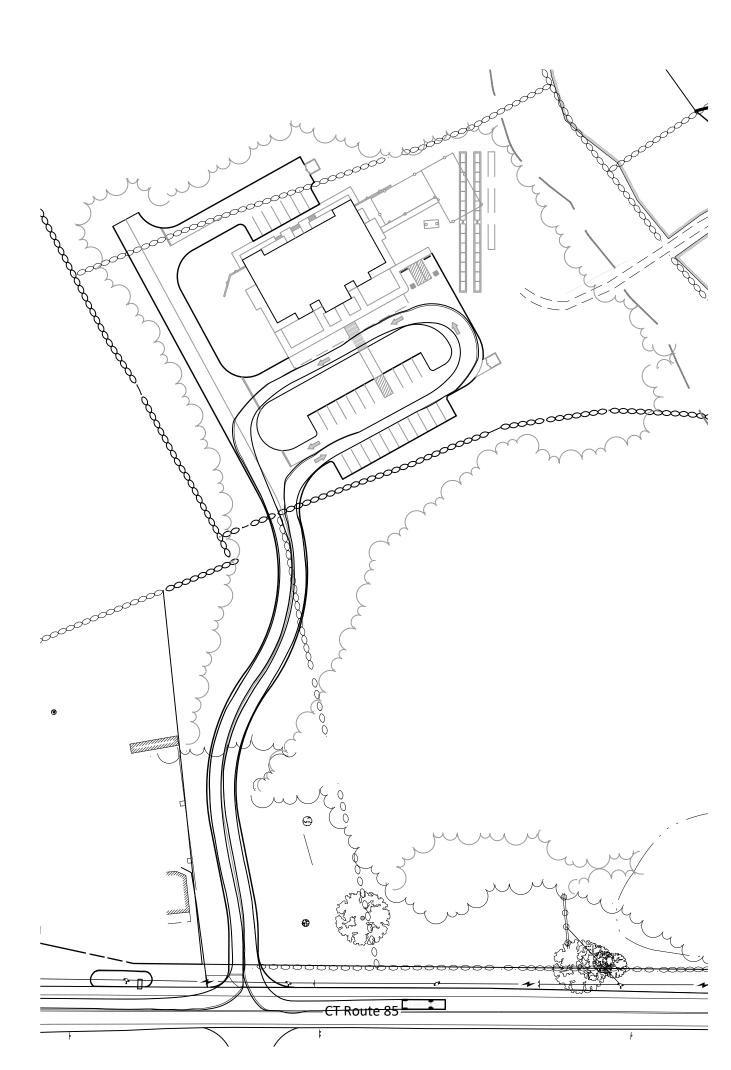

S-BUS 36 DESIGN VEHICLE TURNING MOVEMENT

**NOTES:** 

-SEE SHEET 1 FOR ENGINEER, SURVEYOR AND SOIL SCIENTIST SIGNATURES AND SEALS -SEE SHEET 3 FOR LEGEND AND ABBREVIATIONS

© 2025 BOUNDARIES LLC

THIS DRAWING IS THE PROPERTY OF BOUNDARIES LLC AND HAS BEEN SPECIFICALLY PREPARED FOR THE OWNER OF THIS PROJECT, AT THIS SITE, AND IS NOT TO BE DUPLICATED OR USED IN PART OR WHOLE FOR ANY OTHER PURPOSE, PROJECT, LOCATION OR OWNER WITHOUT THE EXPRESSED WRITTEN CONSENT OF BOUNDARIES LLC. NOT VALID WITHOUT LIVE SIGNATURE AND EMBOSSED SEAL.

FOR REVIEW AND PERMITTING ONLY

VEERING

VETATES

Than a superior of the super

ENGINEERIN ASSOCIATES 232 Greenmanville Av Suite 201 Mystic, CT 06355 Boo-980-9808

Improvement Location & Topographic "Notes & Details" Prepared For Cricket's Corner, LLC


As Noted
ATE:
February 2025

24-3432 Revisions

SHEET NO.

11\_\_

1

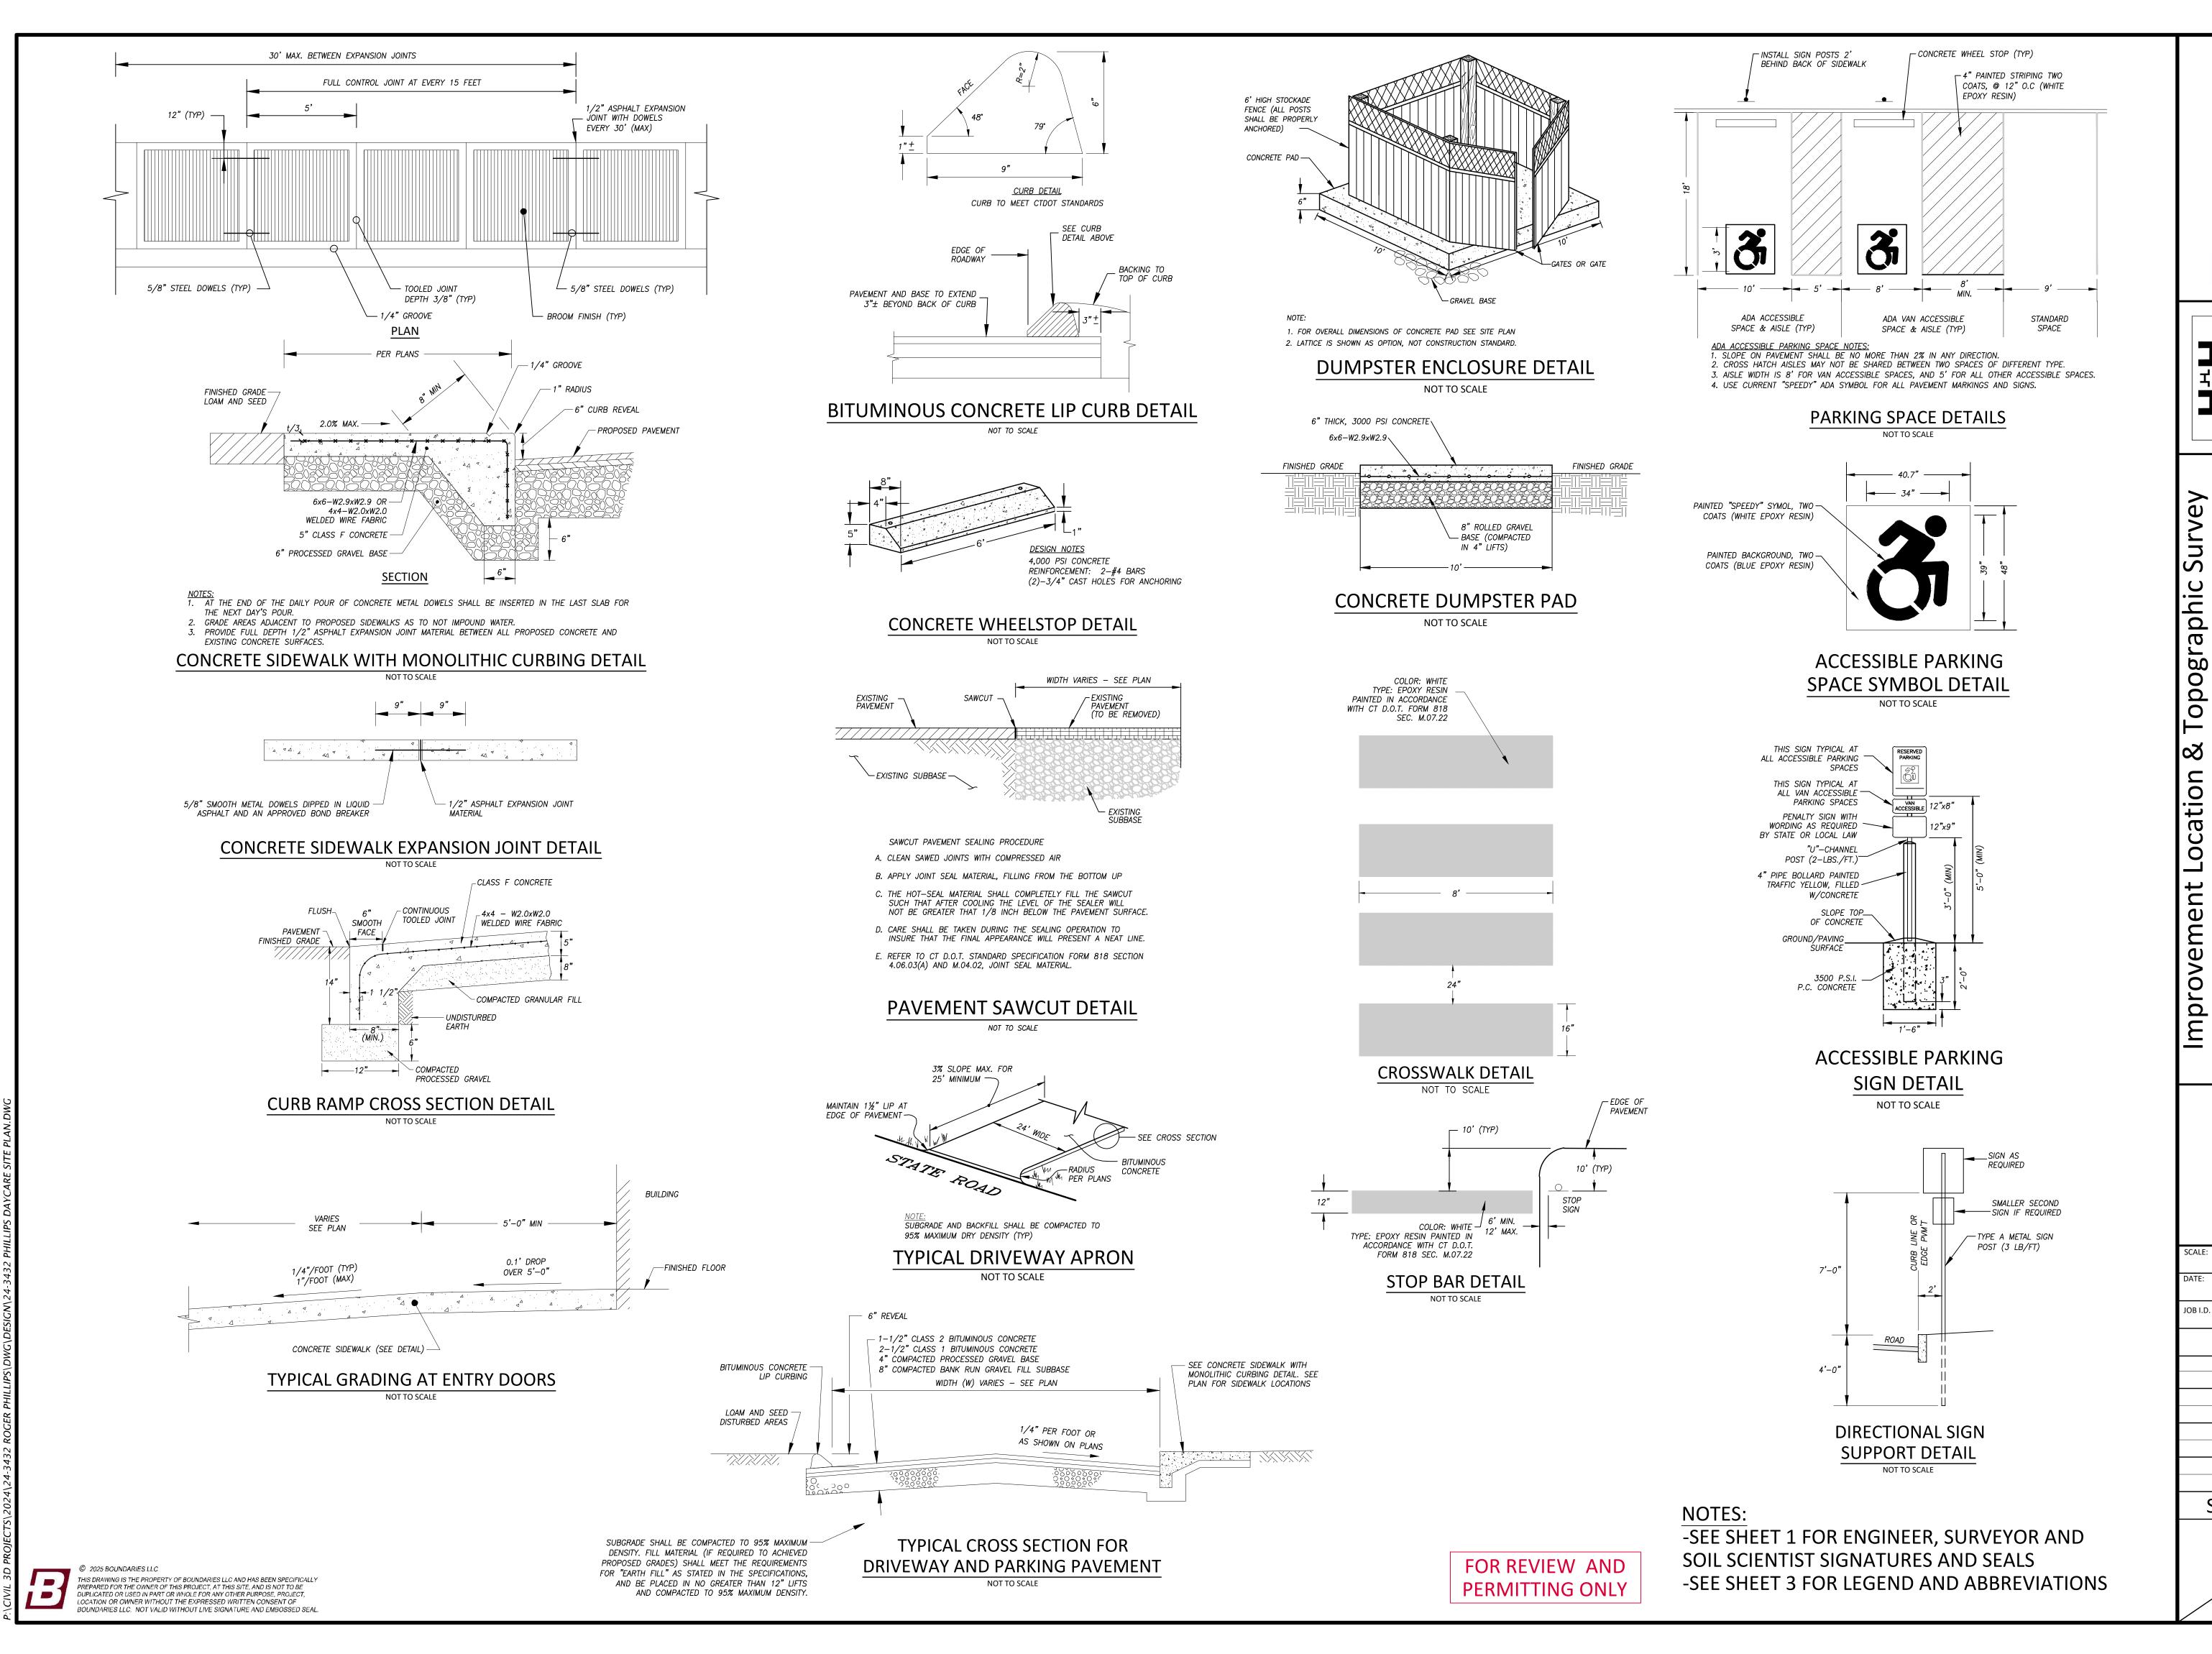


m

orn Prep

As Noted

February 2025 24-3432

Revisions

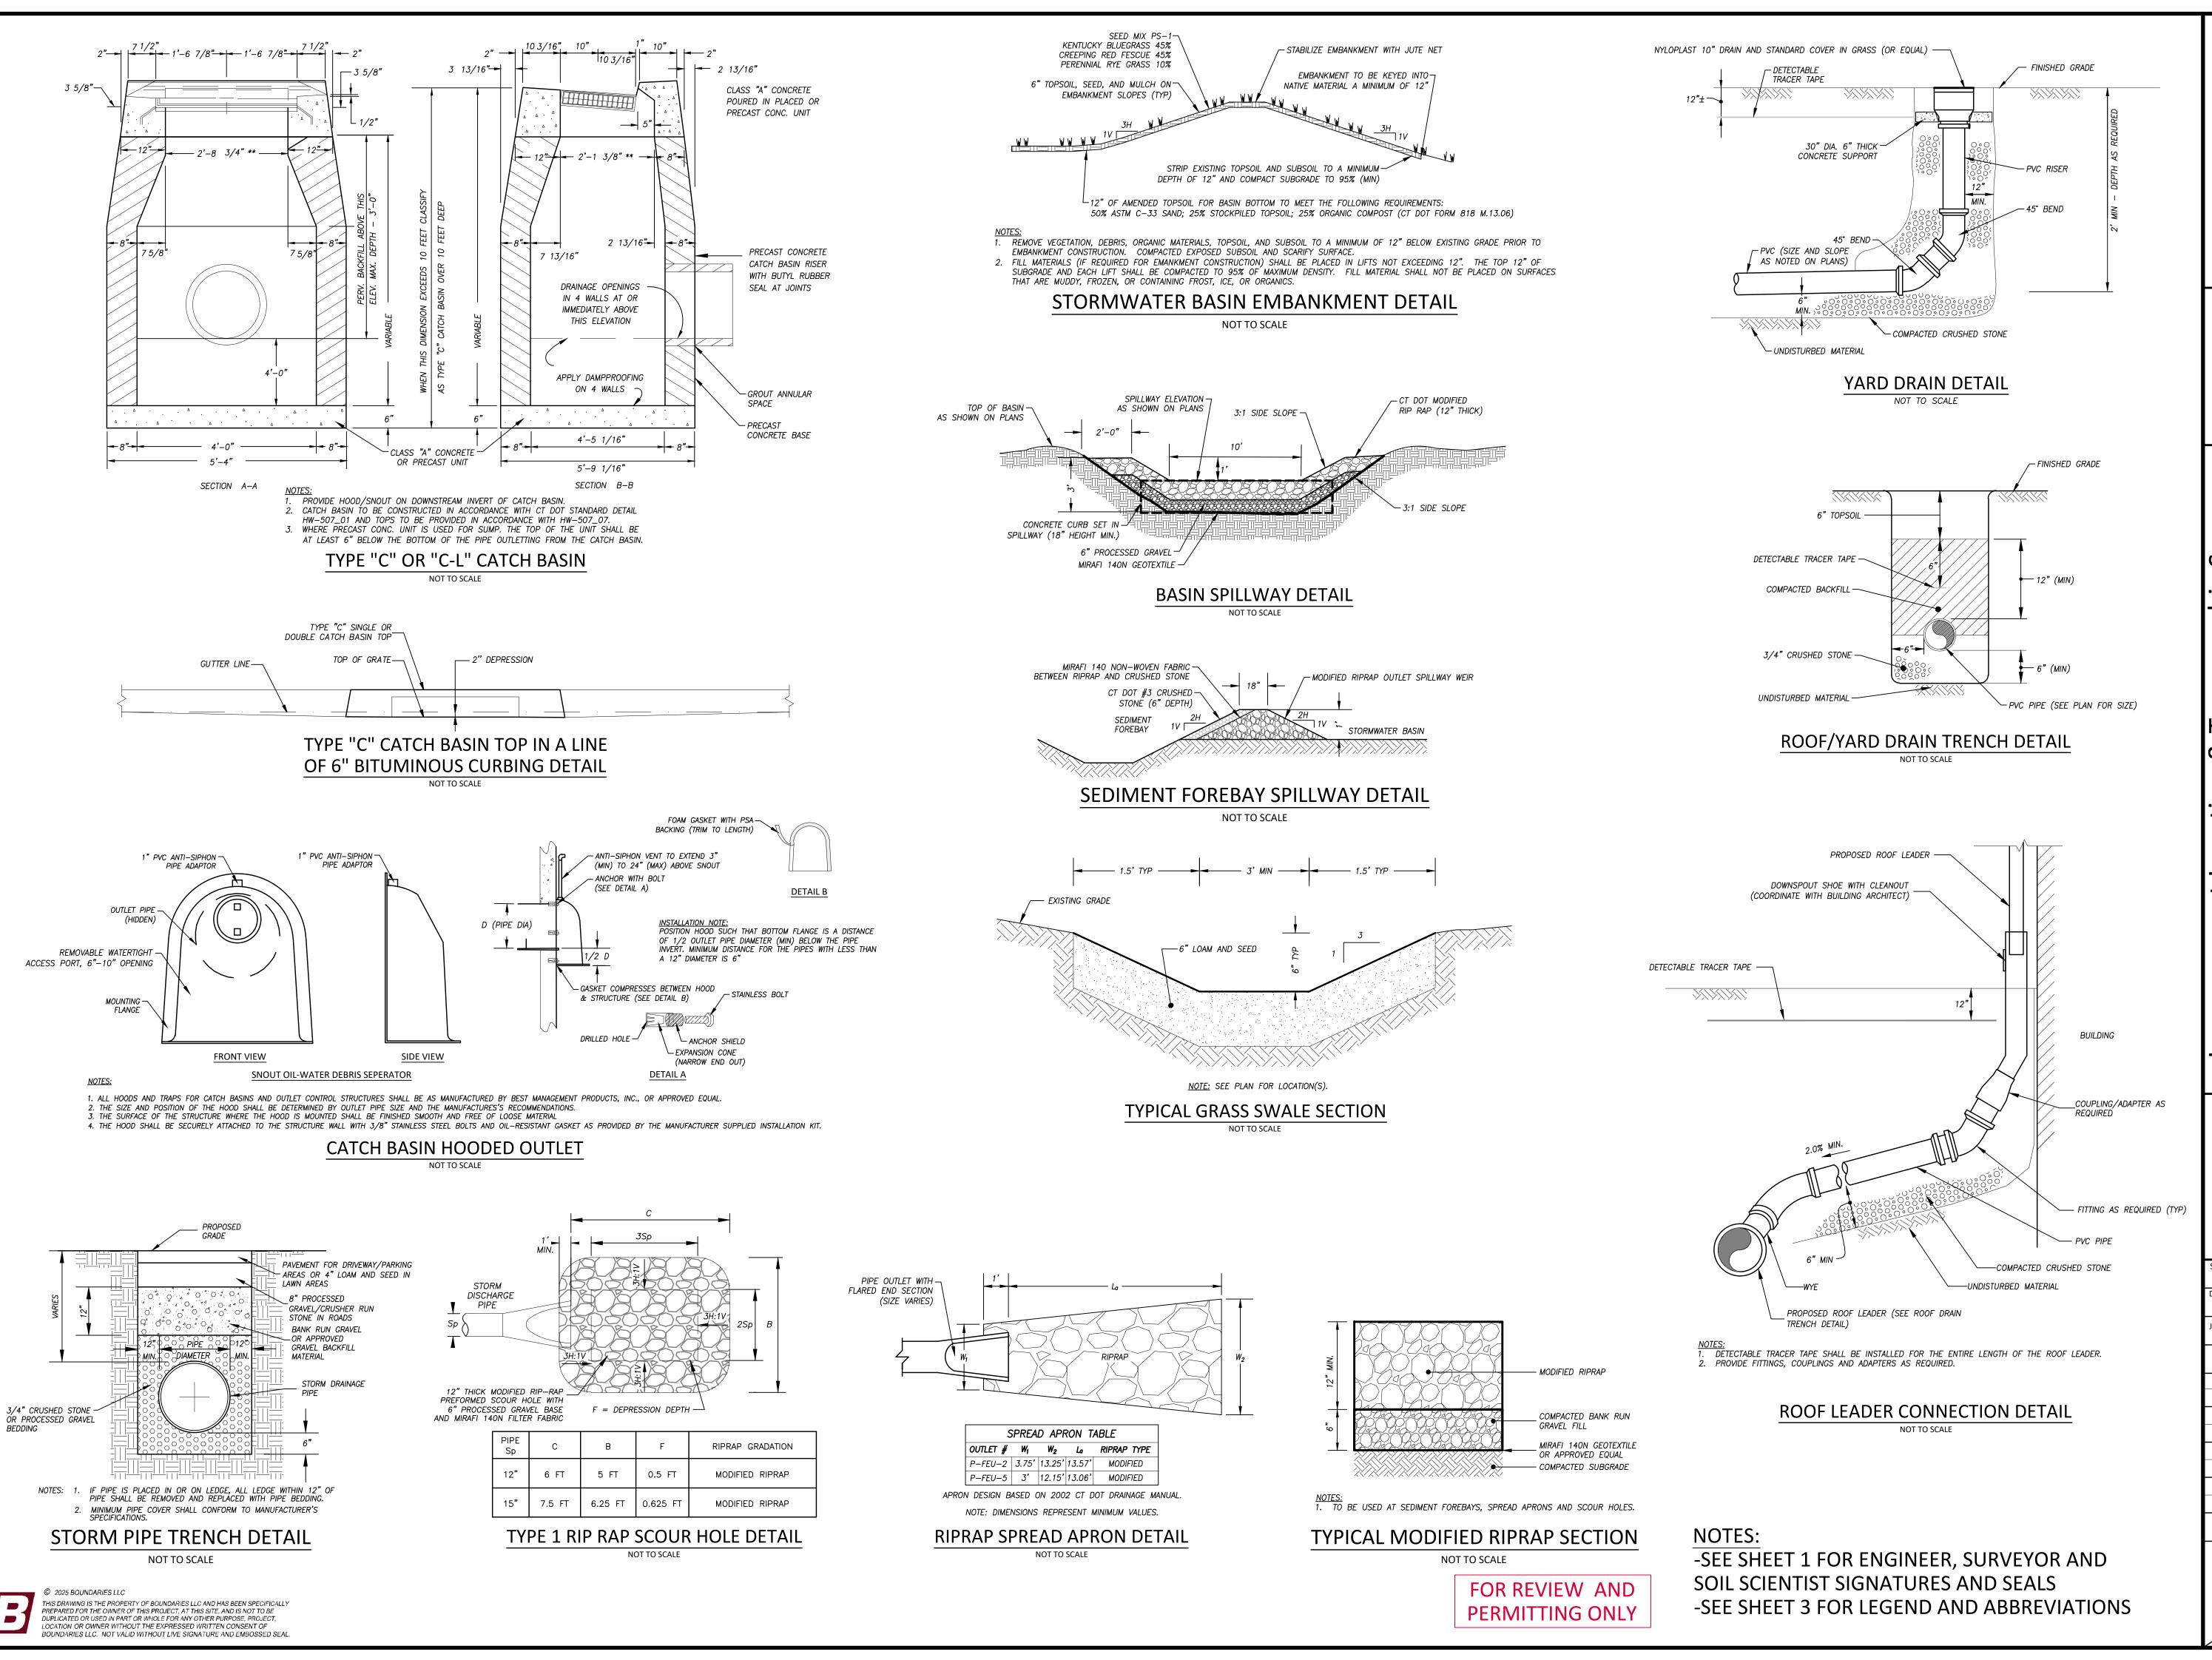

**Topographic** er, orn ocation  $\mathbf{C}$ mprovement

> As Noted February 2025

24-3432

Revisions